NEW BEDFORD WATER WORKS APPLICATION FOR SERVICE NEW BEDFORD-I HEREBY ACKNOWLEDGE the receipt of a copy of the Regulations prescribed in the Ordinance of the City, for the use of Water, and Lrequest that the water may be furnished through a meter at SS 245 SMONST EX HCUS at such rates as may from time to time be established by the City. I hereby agree to pay promptly the bill for the Service pipe laid down for my premises, and to pay all dues for water, and I agree to conform to the said Regulations and to all provisions of the Water Ordinances, until written notice is given by me or my agent to cut off the supply Size and kind of pipe COP From Turned on Meter Set Reading Building rates Paid

31-727

picked up complings x

2" - Copper 07/19/2022

Contractor RJ Canessa Inspector Percy Reynolds

198.1 E X E ACUSHNET AVE 1.0 N X S SHARON ST 20.7 E X W BUILD 63 W X E BUILD 15 N X N BUILD MAIN TO PROPERTY LINE 18

16 PIPE INSIDE PROPERTY

#### DISPLAY PERMIT IN A CONSPICUOUS PLACE ON THE PREMISES



Required minimum static pressure for the proposed project site

#### Commonwealth of Massachusetts

## City of New Bedford

133 William Street New Bedford, MA 02740



#### WATER SERVICE PERMIT

Date: 9/8/2022 No. W-22-22 Permit Fee: \$565.00 SHARON ST 984 Service Location: Owner Name: ARAUJO JOSE "TRUSTEE"SHARON Owner Phone #: (774) 930-5167 Type of Occupancy: Residential Type of Work: Water - Domestic New 2" WATER DOMESTIC SERVICE Work Description: 2" COPPER P137a I21-25, 33,37 **FKA 984 SHARON ST** PERMIT EXPIRS 06/17/22 Contractor Certificate #: Type of Business : Address: City/Town/State: Type of Service Pipe Size Trench Length: Fire Service **Domestic Service** Estimated consumption of water Estimated average daily consumption 0.00 gallons Cross Connection? No Estimated maximum day consumption Right of Way? No Are lawn sprinklers and/or lawn irrigation proposed on site? Meter Impact? No Estimated fire flows required for the project site: 0.00 Street Opening Permit Required? No Does the project require a fire supression system?

Call Phone: (781) 942-9077 For Inspection

### DISPLAY PERMIT IN A CONSPICUOUS PLACE ON THE PREMISES



**Commonwealth of Massachusetts** 

## **City of New Bedford**






0.00



# GRANTED WITH THE USUAL CONDITIONS

COMMISSIONER

Call Phone: (781) 942-9077 For Inspection

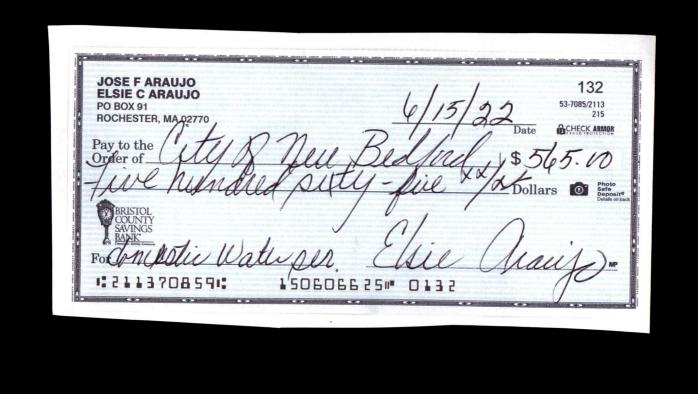

\*RELIEF GRANTED BY NEW BEDFORD ZONING BOARD OF APPEALS CASE #4365 \*\*SPECIAL PERMIT FROM NEW BEDFORD PLANNING BOARD REQUESTED FOR REDUCTION IN REQUIRED PARKING

LANDSCAPE TABLE				
SYMBOL	BOTANICAL NAME	COMMON NAME	SIZE	QUANTITY
		SHRUBS		
	LLEX GLABRA 'SHAMROCK'	INKBERRY	2 GAL.	14
	JUNIPERUS SQUAMATA	BLUE STAR	2 GAL.	11
<b>⊗</b>	HYDRANGEA MACROPHYLLA 'NIKKO BLUE'	NIKKO BLUE HYDRANGEA	2 GAL.	12
**	MISCANTHUS SINENSIS	AUTUMN ANTHEM	2 GAL.	17

## **GENERAL CONSTRUCTION NOTES:**

1. THE CONTRACTOR IS SPECIFICALLY CAUTIONED THAT THE LOCATION AND/OR ELEVATION OF EXISTING UTILITIES AND STRUCTURES AS SHOWN ON THESE PLANS IS BASED ON RECORDS OF VARIOUS UTILITY RELIED ON AS BEING EXACT OR COMPLETE. THE LOCATION OF ALL UNDERGROUND UTILITIES AND STRUCTURES SHALL BE VERIFIED IN THE FIELD BY THE CONTRACTOR PRIOR TO THE START OF CONSTRUCTION. THE CONTRACTOR MUST CONTACT THE APPROPRIATE UTILITY COMPANY, ANY GOVERNING PERMITTING AUTHORITY, AND "DIG SAFE" AT LEAST 72 HOURS PRIOR TO ANY EXCAVATION WORK TO REQUEST EXACT FIELD LOCATION OF UTILITIES INTERFERING WITH THE PROPOSED CONSTRUCTION AND APPROPRIATE REMEDIAL ACTION TAKEN BEFORE PROCEEDING WITH THE WORK. IT SHALL BE THE RESPONSIBILITY OF THE CONTRACTOR TO RELOCATE ALL EXISTING UTILITIES WHICH CONFLICT WITH THE PROPOSED IMPROVEMENTS SHOWN ON THE PLAN.

3. ALL CONSTRUCTION SHALL BE IN ACCORDANCE WITH ALL APPLICABLE STATE AND LOCAL STANDARDS AND REGULATIONS.


5. ALL BENCHMARKS SHOWN ON THIS PLAN ARE TO BE CHECKED FOR CONSISTENCY BY THE CONTRACTOR. ANY DISCREPANCIES MUST BE RESOLVED BY THIS OFFICE PRIOR TO CONSTRUCTION. 6. WHERE PROPOSED PAVEMENT AND WALKS ARE TO MEET EXISTING, THE CONTRACTOR SHALL SAWCUT A NEAT LINE AND MATCH GRADE. SEAL ALL JOINTS WITH HOT BITUMINOUS ASPHALT JOINT SEALER. 7. ALL EXISTING TREES, SHRUBS AND GROUND COVER WHERE NATURAL GRADE IS TO BE RETAINED SHALL BE

PLAN SHALL BE TREATED WITH 4" OF LOAM, SEEDED AND HAY MULCHED FOR EROSION CONTROL. 9. SITE IMPROVEMENTS SHALL CONFORM TO A.D.A. SPECIFICATIONS. 10. CONTRACTOR SHALL THOROUGHLY FAMILIARIZE THEMSELVES WITH ALL CONSTRUCTION DOCUMENTS, SPECIFICATIONS AND SITE CONDITIONS PRIOR TO BIDDING AND PRIOR TO CONSTRUCTION.

11. ANY DISCREPANCIES BETWEEN DRAWINGS, SPECIFICATIONS AND SITE CONDITIONS SHALL BE REPORTED IMMEDIATELY TO THE OWNER'S REPRESENTATIVE FOR CLARIFICATION AND RESOLUTION PRIOR TO BIDDING OR CONSTRUCTION.

12. THESE PLANS ARE PERMITTING PLANS AND SHALL NOT TO BE USED FOR CONSTRUCTION. A FINAL SET OF STAMPED PLANS FOR CONSTRUCTION WILL BE ISSUED AFTER RECEIVING FINAL APPROVAL FROM THE LOCAL

SUBSURFACE ROOF RECHARGE UNIT SIZING CALCULATIONS (PER BUILDING): = 4,850 SF, 100.00% IMPERVIOUS, INFLOW DEPTH = 2.77" FOR 2-YEAR STORM EVENT = 0.32 CFS @ 12.09 HRS, VOLUME= 1,119 CF VOLUME= 913 CF, ATTEN= 97%, LAG= 0.0 MIN = 0.00 CFS @ 9.20 HRS, = 0.00 CFS @ 9.20 HRS, ROUTING BY STOR-IND METHOD, TIME SPAN= 0.00-30.00 HRS, DT= 0.05 HRS PEAK ELEV= 152.01' @ 15.55 HRS SURF.AREA= 432 SF REQUIRED STORAGE= 612 CF AVAIL.STORAGE STORAGE DESCRIPTION 149.83 430 CF 12.00'W X 9.00'L X 3.66'H PRISMATOID X 4 1,581 CF OVERALL - 506 CF EMBEDDED = 1,075 CF X 40.0% VOIDS 120.0"W X 32.0"H X 7.12'L PARABOLIC ARCH X 4 INSIDE #1 506 CF TOTAL AVAILABLE STORAGE = 936 CF >>> 612 CF

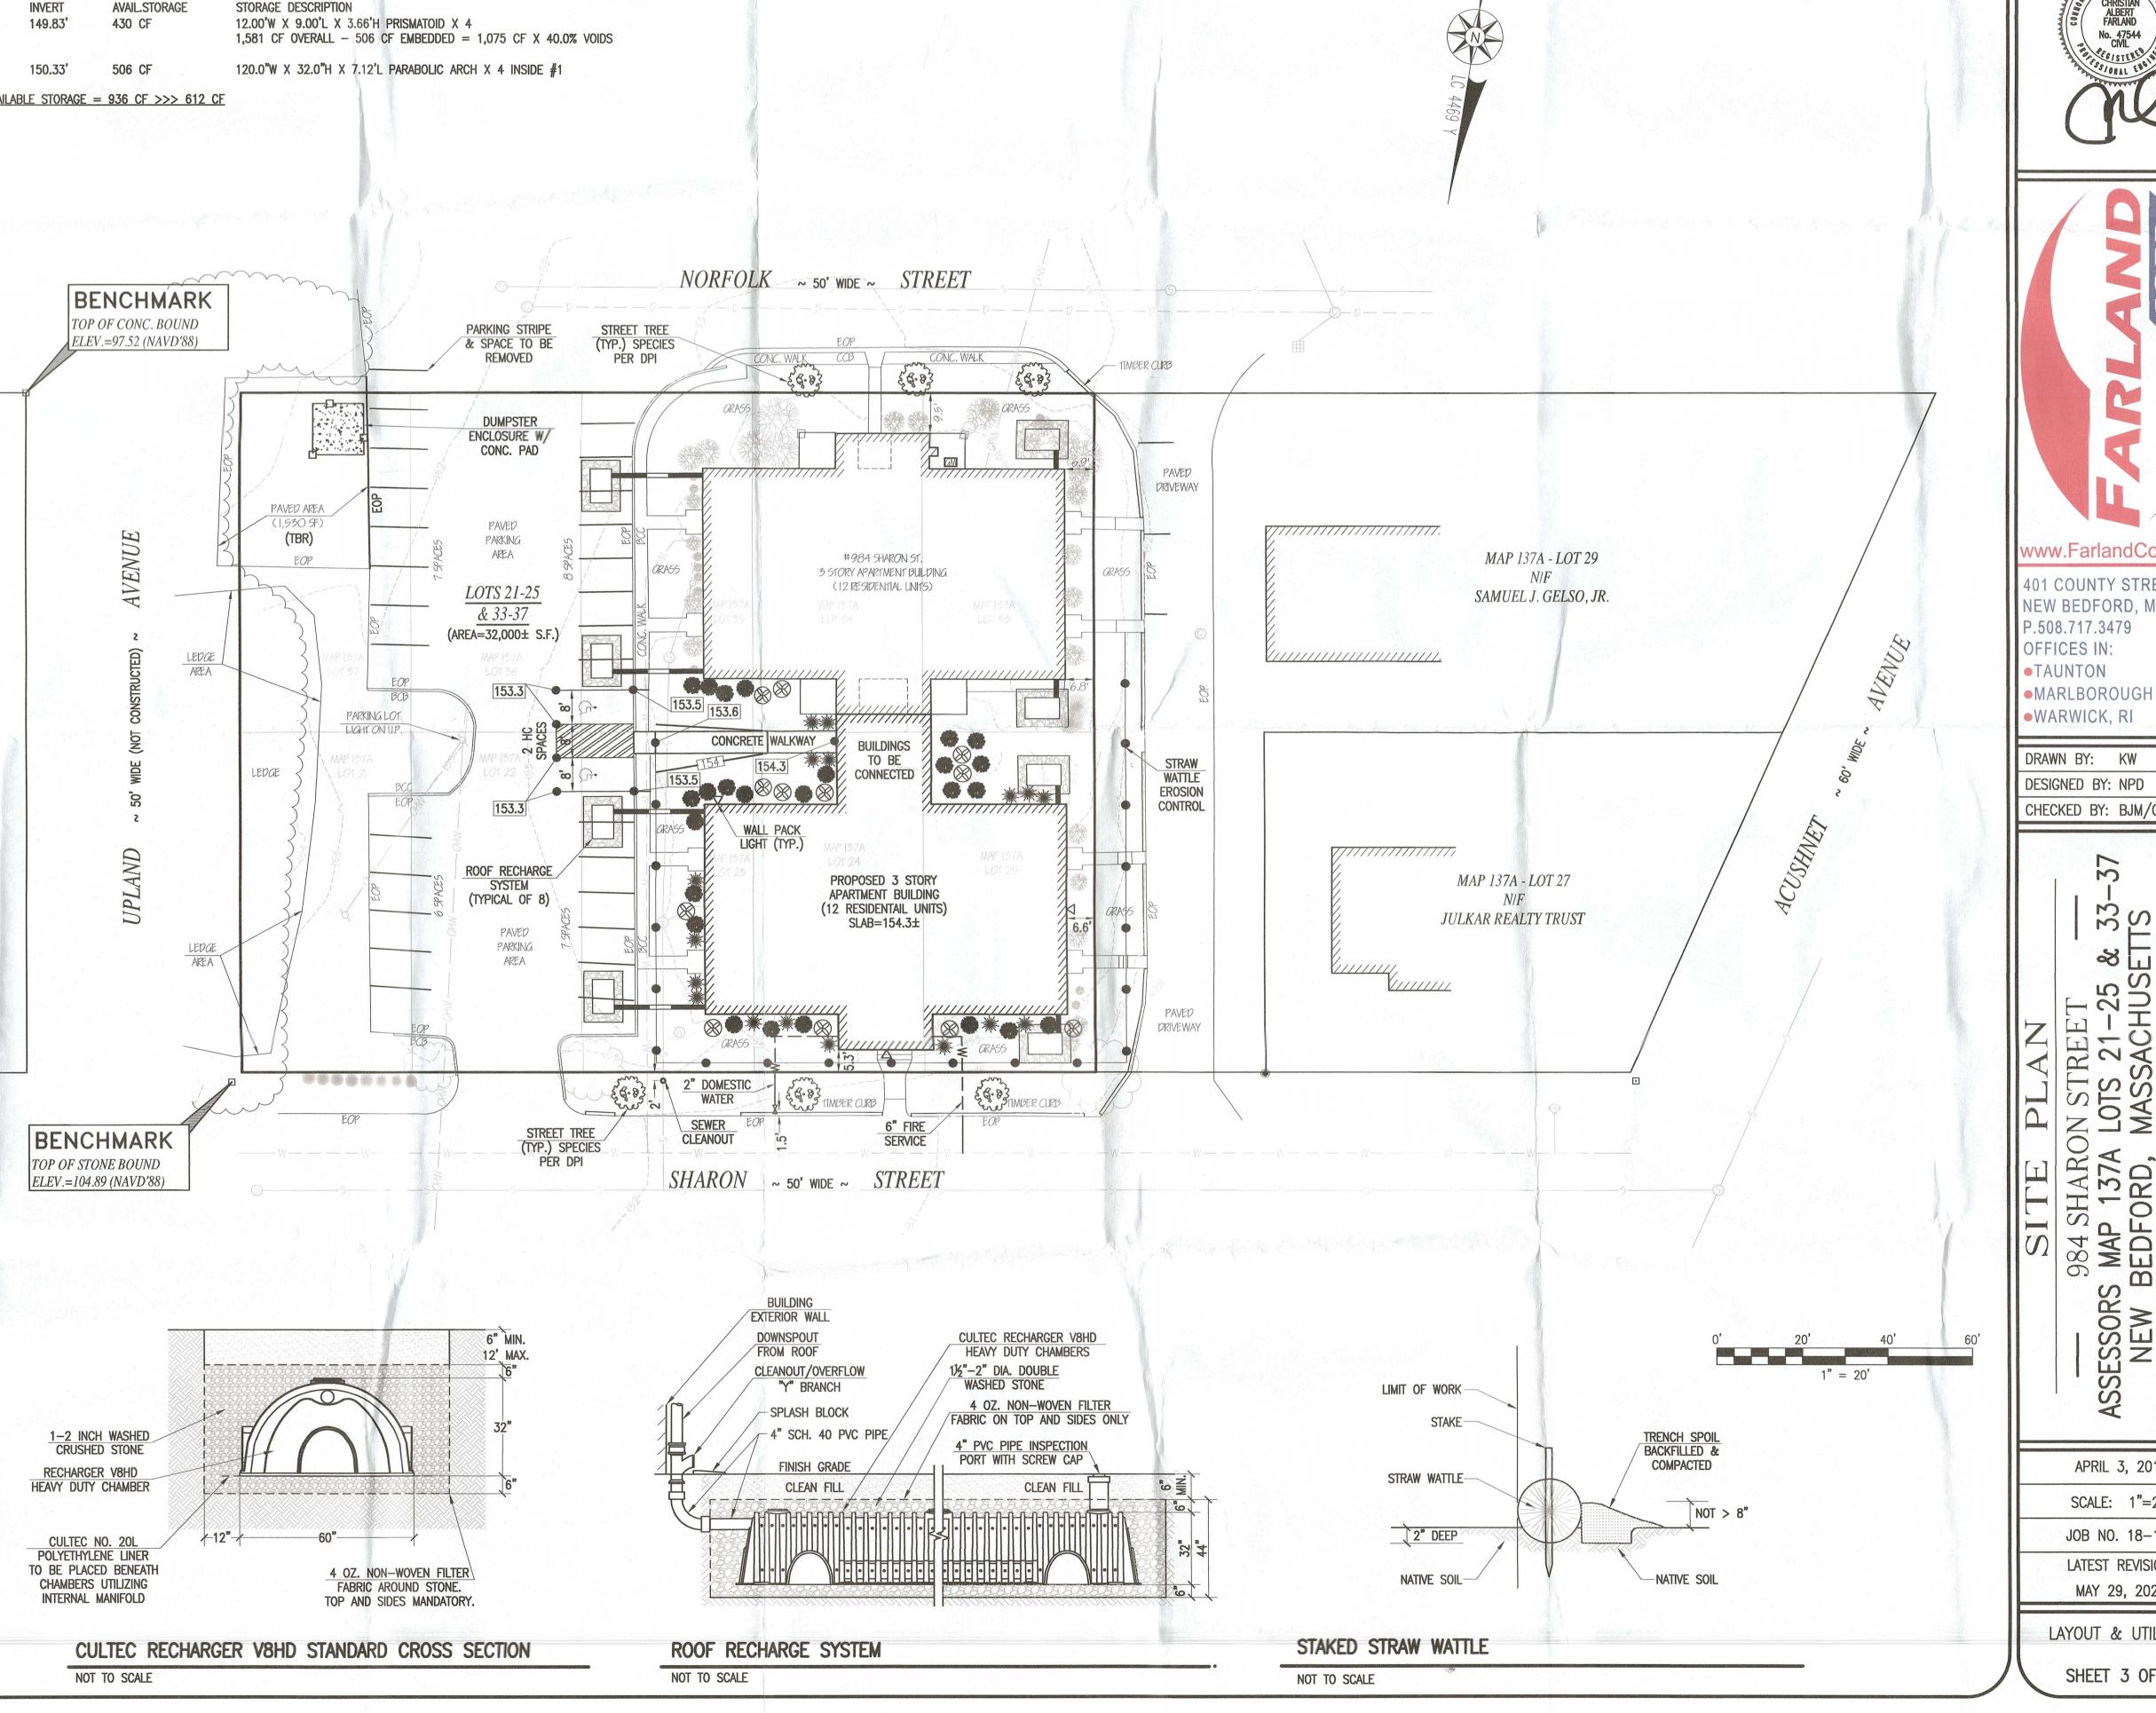

**REVISIONS** 

7/3/19 | PB, DPI COMMENTS 4/20/20 DPI COMMENTS DPI COMMENTS 5/29/20 DPI COMMENTS





www.FarlandCorp.con 401 COUNTY STREET NEW BEDFORD, MA 02740 P.508.717.3479 OFFICES IN:

•WARWICK, RI DRAWN BY: KW DESIGNED BY: NPD

CHECKED BY: BJM/CAF

33 名回 984 SHARON STREET
SS MAP 137A LOTS 21–25
BEDFORD, MASSACHUSE
STREET REALTY TRUST

ASSESSORS

NEW E

REPARED SHARON STRI
PO BOX 91
ROCHESTER. APRIL 3, 2019

SCALE: 1"=20' JOB NO. 18-160 LATEST REVISION: MAY 29, 2020

LAYOUT & UTILITIES SHEET 3 OF 3

AND/OR STATE DEPARTMENTS.

COMPANIES AND WHERE POSSIBLE, MEASUREMENTS TAKEN IN THE FIELD. THIS INFORMATION IS NOT TO BE VERTICAL ELEVATIONS REFER TO THE NORTH AMERICAN VERTICAL DATUM (NAVD) OF 1988.

4. THE CONTRACTOR SHALL BE RESPONSIBLE FOR ESTABLISHING AND MAINTAINING ALL CONTROL POINTS AND

BENCH MARKS NECESSARY FOR THE WORK. KEPT IN THEIR EXISTING STATE UNLESS REMOVAL IS REQUIRED FOR CONSTRUCTION PURPOSES. 8. ALL AREAS DISTURBED BY CONSTRUCTION AND NOT TO BE PAVED OR OTHERWISE TREATED AS NOTED ON