Domestic# 16697 SERVICE 34143

NEW BEDFORD WATER WORKS

APPLICATION FOR SERVICE AND METER NEW BEDFORD 09.03/2021 to 09.03/2022

94149	APPLICATION FOR SERVICE AND METER
Thesupply	NEW BEDFORD 09.05:2021 + 09.03 2022
I HEREBY ACKNOWLEDGE the rec	eipt of a copy of the Regulations prescribed in the Ordinance of the
	quest that the water may be furnished through a
	meter at 114 116 County St
P. 24 L. 119	0
at such rates as may from time to	
I hereby agree to pay promptly the	bill for the Service pipe laid down for my premises, and to pay
	onform to the said Regulations and to all provisions of the Water
Ordinances, until written notice is	given by me or my agent to cut off the supply.
	Inayak LIC 114-116 Country & New Bedford, MA
V	* Kalur (Curiseu
TELEPHO	DNE 516.884.3333
Service laid R.T. Courses &	Size and kind of pipe H" CLD1
From connecting to main a	in County It St.
Turned on	Meter Set
Reading	Location
Building rates	Paid
Cost of Service Hlob CO	Paid Poud
31-727	
EK 11806	

S	X	SL	WINSOR ST	12.6
N	X	NL	MOSHER ST	161.0'
E	X	WL	COUNTY ST	19.5'
S	Х	NL	BUILDING	21.6'
N	y	SI.	BUILDING	31.0

MAIN TO PROPERTY LINE E X WL COUNTY ST 18'

PIPE TO INSIDE PROPERTY

views partit: necsoage selected property has no Parcel JP or MBL cannot add Premit.

Domestic# 16697

SERVICE 34143

NEW BEDFORD WATER WORKS APPLICATION FOR SERVICE AND METER

Tuesupply	1000 5000	42 (30 23 0000
0	NEW BEDFORD 09.03-2021	1009.09 2022
I HEREBY ACKNOWLEDGE the recei	pt of a copy of the Regulations prescribed in	the Ordinance of the
City, for the use of Water, and I requ	uest that the water may be furnished thro	ugh a
H" inch (/)	meter at 114 116 County St	ugit u
	meter at in the course of	
P. 24 L. 119		
at such rates as may from time to ti	me be established by the City.	
	ill for the Service pipe laid down for my p	premises, and to pay
all dues for water, and I agree to con	nform to the said Regulations and to all pro	visions of the Water
	ven by me or my agent to cut off the sup	
	Inaude IC 114-116 Coc	nty & New Bedford, MM
		•
		Usell
	NE 516.884.3333	
Service laid RT Courses	Size and kind of pipe 4" CLD	
From connecting to main or	County St	St.
Turned on	Meter Set	,
Reading	Location	<u>.</u>
Building rates	Paid	
Cost of Service HUD CO	Paid Poud	
31-727		
EK 11806		

R J CANESSA EXCAVATING CO	NSITIVE ICON AND FOIL HOLOGRAM.	11806
PO BOX 51643 PH. 508-998-3404 NEW BEDFORD, MA 02745		53-7223/2113 89613 E
PAY TO THE ORDER OF CITY of Noul Bellings	DATE 4/3/303	CHECK ARMOR Sign
Four Randud Suter Sun XX	1/h. \$	46.00
BayCoast BANK.	DC	DLLARS Judge
FOR 1/4 County Street NB	Robert Canessa	ন জ arrity Featu
"OllBOG" ::211372239: B4O2	93360"	Sec



CITY OF NEW BEDFORD Jonathan F. Mitchell, Mayor

Department of Public Infrastructure

Ronald H. Labelle Commissioner

> Water Wastewater Highways Engineering Cemetery

To Whom It May Concern:

I INAYAT L	LC - D(LMEET SINGH, being
	Owner of propert	v located at
	only street	New Bedford, MA.
024-00-0110 Plot, Lot	, hereby agree to	allow R.J. Canessa Excavation
Po Box 51643 A	Jew Bedford HAO!	A745 (Name) act on my behalf including affixing my
signature in securing p	ermit for:	
_	Sewer/Drain S Water Service	Service Permits
Photo:	Driveway Inst	tallation Permits allation Permits
I further agree to confe the permit (s) being ap		City rules and ask regulations applicable to
N	ame Duf	- DILMEET SINGH
	42 Yaledy Address	ive Manhasset NY-11035
	8 4 20	516 884 3333



Commonwealth of Massachusetts

CITY OF NEW BEDFORD

City Hall, Room 308, 133 William Street New Bedford, MA 02740 (508) 979-1540



No. B-19-1333 MSBC Sect. 110.14 - Any permit issued shall be deemed abandoned and invalid unless the work authorized by it shall have

BUILDING PERMIT

FEE PAID: \$1.625.00

9/2/2020

	been commeced within s	six (6) months after its issuan	ce.			, , , , , , , , , , , , , , , , , , ,
This certifies that	Thomas Whalen		Contractor Lic. #	003022	ParcelID	24-119
owner/contractor h	as permission to: Com	nmerical Sprinkler - 3	00.00			
on: 116-116A	COUNTY ST					
provisions of the statute	n accepting this pe <mark>rmit shall</mark> of the Comonweal <mark>th adn to</mark> g, or tearing down <mark>of a buildi</mark>	the by-laws of the Cit	from to the terms of application ty of New Bedford relating to the	therefore on file i	in this office; tion, enlarging	to the g, altering,
	Permit is issued subject to	the following special r	requirements: (Restrictions)			
CITY DEPARTMENT/CO	MMISSION COMMENTS		BUILDING DEPARTMI	ENT COMMENTS		
permit. You are adviced to Department. Commission:	commission has expressed con contact that agency and resolv	ve this matter.				
	YOUR AREA INSPE <mark>CTOR IS:</mark>	Matthew Silva	1	<mark>ГеІ. (50</mark> 8) 979-1540	Between 8:0	0am - 9:00am
	Y INSPECTOR 48 HOURS I PPLYING SHEATHING OR	No Bu	OCCUPANCY PERMIT REilding or Structure shall be used or occupied Building Commissioner - MSBC, Sect. 120.1	until the Certificate of Us		
This Card Mo	ust Be Displayed in a Conspi	cuous Place on the P	Premises and Not Torn Down or	Removed Until Co	ompletion of V	Vork
SUB	JECT TO MASSACHUSETTS STATE BUILDING CODE		Building Commissioner	<u> </u>		

Plan Review Comments:

: will require fp 06 permit from the fire department for all sprinkler and fire alarm work. Will need final test and inspection upon completion.

: AN ELECTRICIAN AND ELECTRICAL PERMIT WILL BE REQUIRED FOR ALL WIRING ASSOCIATED WITH THIS PROJECT.

- : 1. The Department is requiring that you or your engineer to verify in writing that the proposed fire service will provide sufficient volume and pressure for the building.
- 2. Fire Service: Install tapping sleeve and gate for the size of the service.
- 3. Fire service to be 10 ft away from sewer service.
- 4. Install backflow at point of entry into building.
- 5. Owner to apply for a fire supply permit.
- 6. Owner to summit a site plan showing the location size and type of materials.

Applicant must contact the Engineering office to request legal address numbers be issued to the present-day main entrances of the establishment. The #114 belongs to the building south of this establishment, and #116 was an address number that was assigned to the main entrance of a dwelling originally owned by Alexander Price, who owned the property as of May 18, 1881. It appears that this was one of those building that originally was a home and then was converted to a commercial/residential structure. There is no record on file in Engineering that shows legal address numbers were requested for the main entrances of the structure which presently exists on this property.

: ASR-D.P.I. Engrg.

RE: TB-19-1333 114-116 County St. (Purported Address) [Front Building—Fernando's Club & Apts. above] Plot 24 Lot 119 Reviewed 1/14/2020

This location was formerly going by the address numbers of 114-116 County St., which were not assigned by Engineering to the 2 main entrances presently on said building. The owner of the building (Dilmeet Singh, who is also manager for the corporation—INAYAT, LLC) has complied with the D.P.I. requirement of contacting D.P.I. to correct the address issues for this building, as well as the apartment building to the rear (i.e. The front building, Fernando's Club—116 and apts. above—116A; the rear apartment building—114A). Alex P. from D.P.I. visited the site on 1/7/2020 and verified the correct numbers were placed on the respective doors. Inspectional Services updated permit address in View Permit on 1/13/2020.

Any other comments pending comments (by Wayne Perry of IPP/FOG permitting and/or Cliff Souza of Water) must be addressed before the CO is signed off by Inspectional Services.

: 780 CMR 110.5 Inspection Requests - It shall be the duty of the holder of the building permit or their duly authorized agent to notify the building official when work is ready for inspection. It shall be the duty of the permit holder to provide access to and means for inspections of such work that are required by 780 CMR. The building official may require the permit holder or his or her representative to attend these inspections.

: Certificate of Occupancy is Required upon completion of this project

: Fire Protection Engineer - Alycia J. Wood - No. 47368 (508) 728-8374 ajwood13@comcast.net


This project is to be constructed under Construction Control
All inspection reports are to be submitted to the Building Department
Final Construction Control Affidavit is required upon completion of this project


: Scope of Work

Install new wet and dry sprinkler systems as shown on stamped permit drawings per NFPA 13 standards

All work to be performed as per plans submitted

Electrical, Plumbing, and Fire Alarm Permits are required

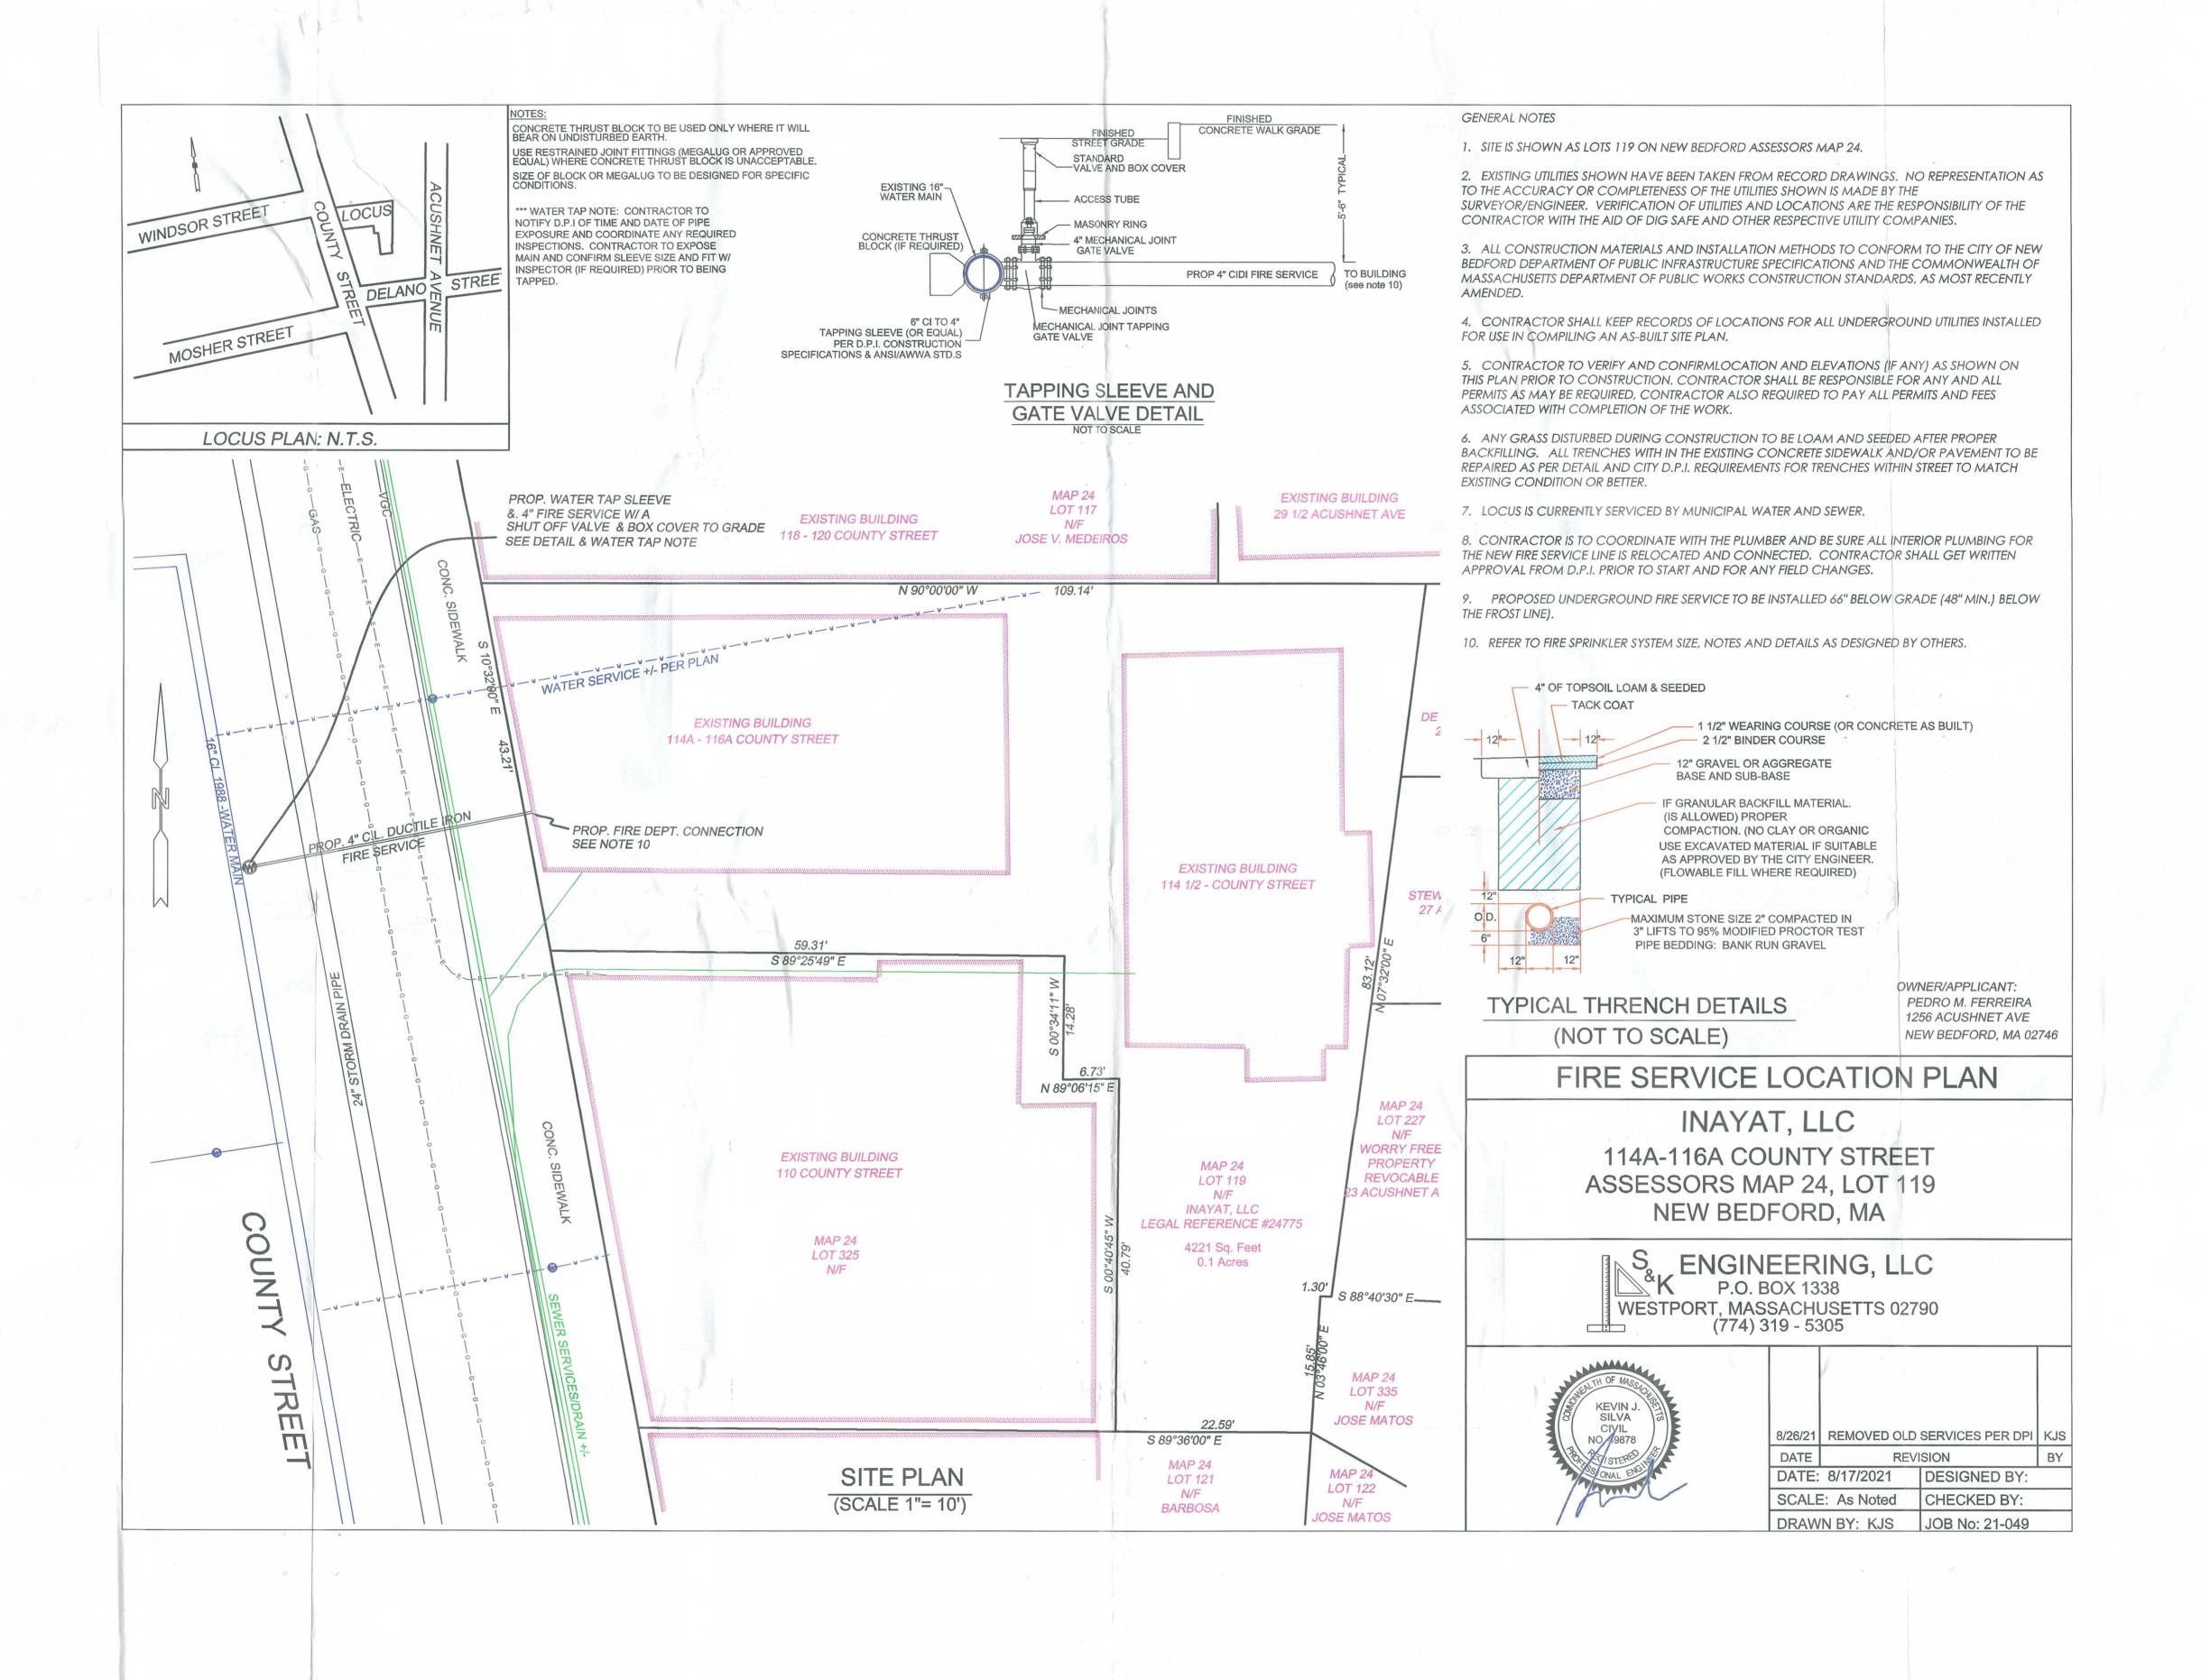

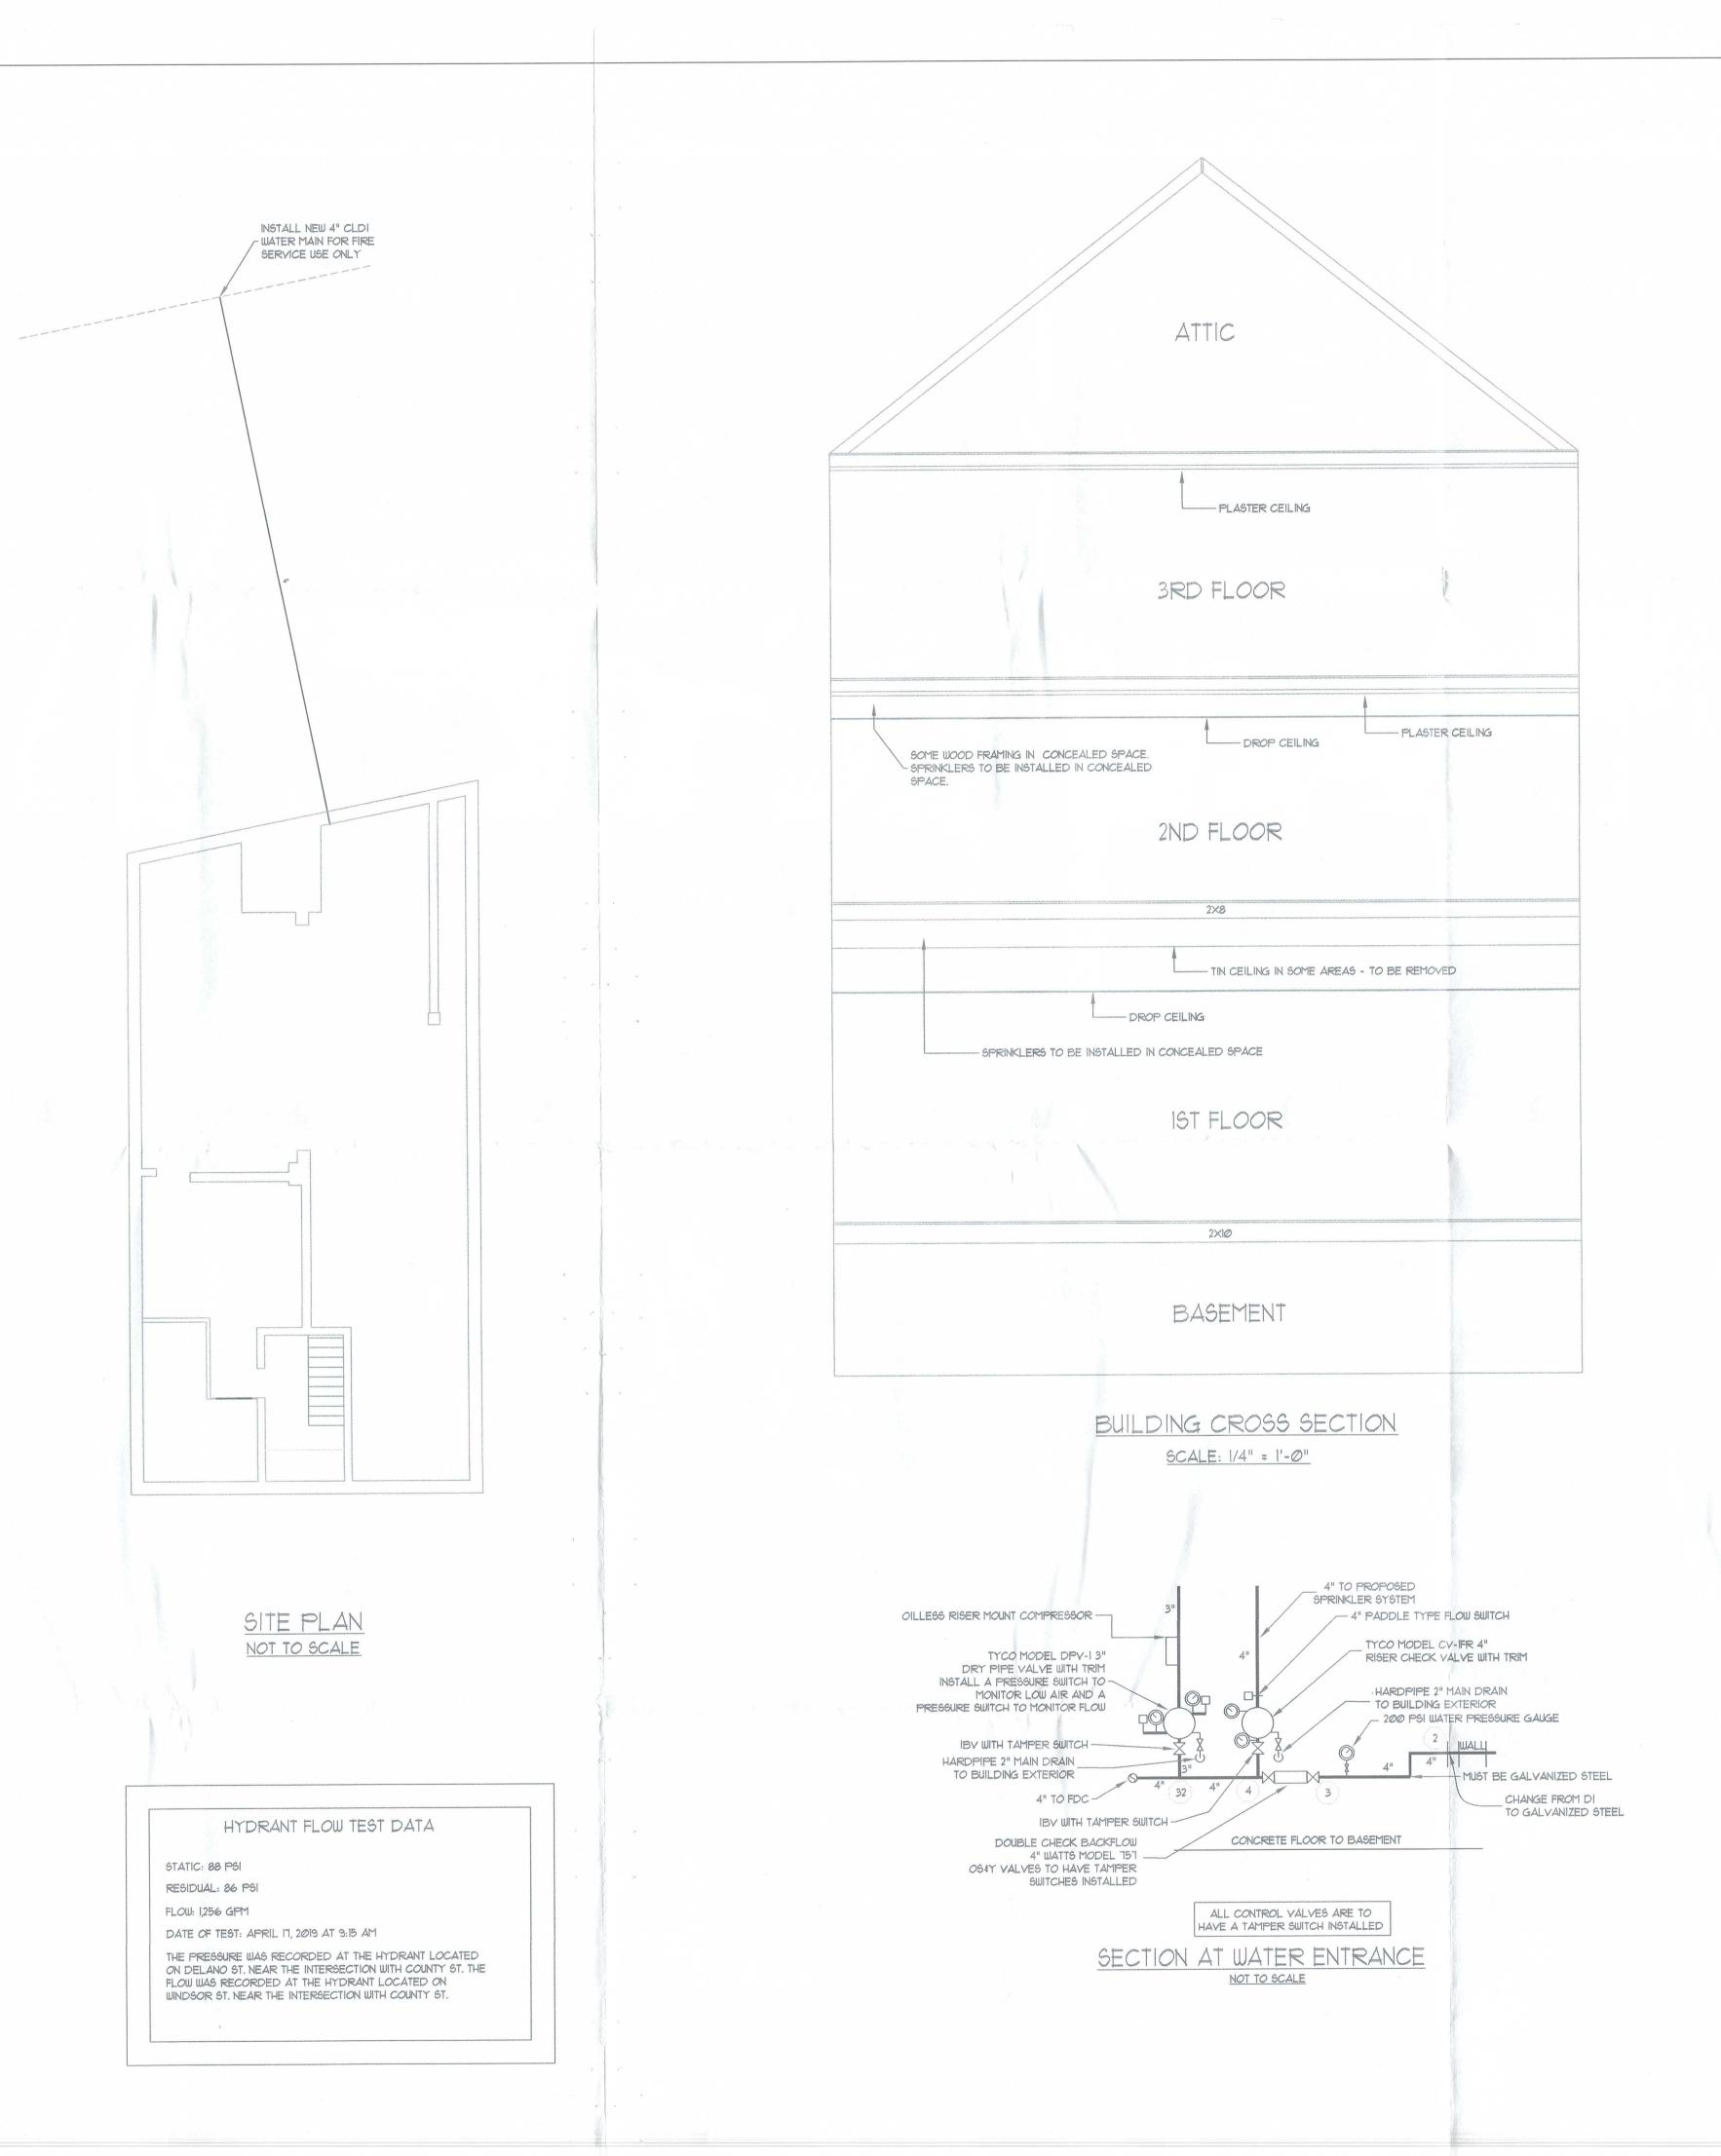

O TYCO SERIES TY-FRB QUICK RESPONSE PENDENT SPRINKLER 5.6 K-FACTOR, 1/2" N.P.T., WHITE COATED, 155°F RATED, SIN TY323 TYCO SERIES RFII QUICK RESPONSE CONCEALED PENDENT SPRINKLER 5.6 K-FACTOR, 12" N.P.T., WHITE COATED, 155 F RATED, SIN TY3531 TYCO SERIES RFII QUICK RESPONSE CONCEALED PENDENT SPRINKLER 5.6 K-FACTOR, 1/2" N.P.T., WHITE COATED, 200°F RATED, SIN TY3531 CUO TYCO MODEL CC3 COMBUSTIBLE CONCEALED SPACE SPRINKLER 5.6 K-FACTOR, 1/2" N.P.T., BRASS, 200°F RATED, SIN TY3199 TYCO SERIES TY-FRB QUICK RESPONSE UPRIGHT SPRINKLER 5.6 K-FACTOR, 1/2" N.P.T., WHITE COATED, 155°F RATED, SIN TY313 . TYCO SERIES TY-FRB QUICK RESPONSE SIDEWALL SPRINKLER 5.6 K-FACTOR, 12" N.P.T., WHITE COATED, 155 F RATED, SIN TY3331 • TYCO SERIES LFII RESIDENTIAL CONCEALED PENDENT SPRINKLER 4.9 K-FACTOR, 1/2" N.P.T., WHITE FINISH, 160°F RATED, SIN TY3596 TYCO SERIES LFII RESIDENTIAL CONCEALED PENDENT SPRINKLER 4.9 K-FACTOR, 1/2" N.P.T., WHITE FINISH, 200°F RATED, SIN TY3596 TYCO SERIES LFII RESIDENTIAL HORIZONTAL SIDEWALL SPRINKLER 4.4 K-FACTOR, 12" N.P.T., WHITE FINISH, 155°F RATED, SIN TY2334 TYCO BB3 SPECIFIC APPLICATION ATTIC SPRINKLER 5.6 K-FACTOR, 1/2" N.P.T., BRONZE FINISH, 212 F. RATED, SIN TY3182 TYCO HIP SPECIFIC APPLICATION ATTIC SPRINKLER 5.6 K-FACTOR, 12" N.P.T., BRONZE FINISH, 200°F. RATED, SIN TY3187 TYCO SDI SPECIFIC APPLICATION ATTIC SPRINKLER 5.6 K-FACTOR, 1/2" N.P.T., BRONZE FINISH, 212°F. RATED, SIN TY3183 TYCO AP SPECIFIC APPLICATION ATTIC SPRINKLER 5.6 K-FACTOR, 1/2" N.P.T., BRONZE FINISH, 200°F. RATED, SIN TY3190

GENERAL SPECIFICATIONS:

(1) This project involves the installation of a sprinkler system compliant with NFPA-13 in a mixed use building. The building consists of a restaurant occupancy on the first floor and a residential boarding house on the second and third floors. Fire alarm system design is not included as part of the scope of these plans.

(2) The installation shall meet all requirements of NFPA-13 (2013 edition), the Massachusetts Building Code (9th edition), and any locally adopted ordinances and laws of the New Bedford Fire and Building Departments. All equipment shall be UL Listed for fire suppression systems. Sprinklers shall be as listed on these plans or exact equals in K-factor and flow/pressure requirements.

(3) The restaurant seating area and basement is considered an Ordinary Hazard Group I occupancy, the kitchen area of the restaurant is considered an Ordinary Hazard Group II classification and the 2nd and 3rd floor dwelling units are considered a residential occupancy classification. In addition, the combustible concealed spaces between the 1st and 2nd floor and the 2nd and 3rd floor along with the attic space are considered Light Hazard occupancies. Coverage rules of NFPA-13 shall be met in accordance with these requirements. All sprinklers installed throughout the basement and first floor shall be quick response and all sprinklers installed throughout the 2nd and 3rd floors shall be residential sprinklers. The sprinklers in the combustible concealed spaces shall be Tyco Combustible Concealed Space sprinklers as specified and the attic shall be Tyco Attic sprinklers as specified.

(4) Pipe: The underground piping shall be cement lined ductile iron, Class 350 and shall transition to schedule 10 black steel pipe just above the floor to the basement. All piping larger than 2" on the wet sprinkler system shall be schedule 10 black steel with rolled grooved fittings. All smaller piping on the wet sprinkler system shall be schedule 40 black steel with cast threaded fittings. All dry sprinkler system piping shall be galvanized steel.

(5) Hangers: Steel pipe shall be supported with cadmium plated adjustable sprinkler band hangers spaced at a

maximum centerline distance of 12'-0".

(6) All dry sprinkler system piping shall be pitched back towards the main riser to drain. Cross mains shall be pitched 1/4" per 10 feet and branch lines shall be pitched 1/2" per 10 feet. The dry sprinkler system shall be provided with a UL listed compressor compliant for sprinkler system usage.

(7) This design has contemplated keeping all water filled sprinkler system piping well within the heated/insulated envelope of the building. The owner shall be responsible for ensuring that sufficient heat be provided in the building including the stairwells to ensure that the temperature remains at or above 40°F.

(8) Once the combustible concealed spaces are exposed between the 1st and 2nd floors and 2nd and 3rd floors, the layout of the concealed space sprinklers will need to be evaluated for complete coverage as access into this space was limited at the time of this design. In addition, the tin ceiling between the 1st and 2nd

floors will need to be removed completely for proper sprinkler coverage.

(9) The sprinkler system risers shall be as detailed and shall include flow switches, supervision of the control valves, and main drain with test connection by-pass.

(10) All sprinkler piping shall be hydrostatically tested at 200 psi for a minimum period of 2 hours. The Sprinkler

Contractor shall complete a standard Contractor's Material and Test Certificate for each building.

(11) The sprinkler system alarms shall be connected into the fire alarm panel. The fire alarm panel must be monitored by a UL Listed Central Station. The connections to the panel shall be provided by others and shall not be the responsibility of the Sprinkler Contractor. At a minimum, this panel shall monitor system flow, low air and position of the control valves.

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FIREWOOD®RCN.COM

REVISIONS:

NO. DATE: DESCRIPTION:

LEGEND

Pendent Sprinkler
Pendent Sprinkler-1" Drop
Upright Sprinkler
Sidewall Sprinkler
Pipe Rise
Pipe Drop



SCALE: 1/4" = 1'-0"

DATE: AUGUST 2, 2019

CAD JOB NO .: COUNTYSTNB.DWG

DRAWN BY: A. J. WOOD
D-4.DWG TEMPLATE

OWNER:

MICHAEL SINGH

LOCATION:

116 COUNTY ST. NEW BEDFORD, MA

DRAWING TITLE:

SPRINKLER SYSTEM
PLANS, DETAILS & NOTES

DRAWING NO.:

FP 3