

REET MAIN 595' OF 4" AW STREE RD, MASSA JECT #: 20 E PROJEC (ACUSNET	PH LIP GAS M T ACHUSETTS	AIN 4345825			Clifford St Clifford St Clifford St Cliccolate Works C Jackson Hewritt Clicandy store Legends Barber Stop C Central Ave Bourassas True Value Hardware store Combra Store Combra Store Central Ave Cliphone store Central Ave Cliphone store Central Ave Cliphone store Courses a chille Cliphone store Central Ave Courses a chille Cliphone store Central Ave Courses a chille Cliphone store Central Ave Central Ave Central Ave Central Ave Central Ave	Princeton St reto shop Citiford St reto Bedford Vesories into Show St Central Ave Central	r dealer Hatch St A Hatch St A A A A A A A A A A A A A	Hatch St
SHAW STREE		ASE 1 AND 2 ON SHEET 6	ATION C - PHASE 1 AND 2 ON SHEET 7	4616379	1 SI 2 GI 3 IN 4 IN 5 LC 6 LC 7 LC	SHEET INDEX ESCRIPTION TE PLAN, LOCUS PLAN AND SHEE ENERAL NOTES STALLATION PLAN STALLATION PLAN DCATION A - PHASE 1, 2 AND SCH DCATION B - PHASE 1, 2 AND SCH DCATION C - PHASE 1, 2 AND SCH TANDARD CORROSION DETAILS	EDULE OF MATERIALS EDULE OF MATERIALS	
SITE PLAN NEW BEDFORD, MASSACHUSETTS (SCALE: 1"=30') DO NOT SCALE FROM DRAWINGS)					0 ISSUED FOR 0 NO. DESCRIPTION	CONSTRUCTION REVISION STAT	DATE D	WS/AB/EK DW/CK/AP
SSUED FOR NSTRUCTION	SEALED BY:	SEALED ON: 01/22/2021 LICENSE EXPIRATION:	DESIGNED IN ACCORDANCE WITH TITLE 49-PART 192 OF MINIMUM FEDERAL SAFETY STANDARDS AND GPTC GUIDE FOR GAS TRANSMISSION AND DISTRIBUTION PIPING SYSTEMS. LATEST EDITION.	FIELD VERIFY DIMENSIONS PRIOR TO PIPE FABRICATION	SITE	EVERS	RCE ENERGY N RELAY ACHUSETTS ID SHEET INDEX	
01/21/2021	SIGNATURE	06/30/2022	29 BARTLETT STREET MARLBOROUGH, MA 01752 TEL. (630) 353-4000 FAX (630) 535-7777 WWW.ENENGINEERING.COM		SCALE: AS NOTED DRAWN BY / DATE LR 11/06/2020 APPROVED BY / DATE EK 01/21/2021	CHECKED BY / DATE AB 01/12/2021 MANEB21PIP021R0	SHEET SHEET NUMBER MA-NEB-21-PIP-021-01	REV. NO.

GENERAL NOTES

- 1. IF ANY OF THE FOLLOWING OCCUR A DRAWING REVISION IS REQUIRED AND MUST BE APPROVED AND/OR STAMPED BY THE ENGINEER OF RECORD. CHANGES CAN BE APPROVED AND/OR STAMPED BY A PROJECT ENGINEER, BUT THE ENGINEER OF RECORD MUST BE INFORMED.
 - A. IF THE TIE IN POINT MOVES TO A DIFFERENT SEGMENT OF PIPE THAN SHOWN
 - B. IF A CHANGE IN THE LOCATION OF VALVES IS REQUIRED
 - C. IF THERE IS ANY CHANGE TO WHAT IS SHOWN ON THE DRAWING WITHIN 50 FT OF A
 - PRESSURE REGULATING STATION, DISTRICT REGULATOR, OR GATE STATION
 - D. IF A CHANGE IN PIPE SIZE, MATERIAL, FITTINGS, OR WALL THICKNESS IS REQUIRED.
- 2. MINOR CHANGES SUCH AS OFFSETS MAY NOT REQUIRE DRAWING CHANGES.
- 3. EXCAVATOR SHALL CALL DIGSAFE/CALL BEFORE YOU DIG (DIAL 811) AT LEAST 72 HOURS PRIOR TO CONSTRUCTION. SATURDAYS, SUNDAYS, AND HOLIDAYS ARE EXCLUDED FROM THE 72-HOUR TIME SPAN, NOT CONSIDERED BUSINESS WORKDAYS.
- 4. CONSTRUCTION DRAWINGS ARE BASED ON EVERSOURCE HISTORICAL DOCUMENTATION AND HAVE NOT BEEN FIELD VERIFIED. WHEN THE PIPE IS EXPOSED AND VARIANCES TO THE CERTIFIED DRAWINGS ARE FOUND, CONTACT GAS ENGINEERING TO DETERMINE PATH FORWARD.
- 5. ALL WORK SHALL BE PERFORMED PER EVERSOURCE, LOCAL, STATE, OSHA, AND FEDERAL REGULATIONS AND STANDARDS.
- 6. MATERIAL AND CONSTRUCTION SHALL CONFORM TO EVERSOURCE GAS STANDARDS.
- 7. THE LOCATIONS OF EXISTING UTILITIES AND UNDERGROUND STRUCTURES ARE APPROXIMATE AND MUST BE FIELD VERIFIED. ADDITIONAL UNDERGROUND FACILITIES MAY EXIST THAT ARE NOT SHOWN ON THESE DRAWINGS WHICH MAY REQUIRE ADDITIONAL OFFSETS IN THE PIPELINE.
- 8. WORK LOCATIONS SHOWN ON THE DRAWINGS ARE APPROXIMATE. EXACT LOCATIONS OF TIE-INS SHALL BE DETERMINED AT THE TIME OF CONSTRUCTION TO SUIT FIELD CONDITIONS AT THE SPECIFIC TIE-IN POINT. VERIFY LOCATIONS OF ALL EXISTING UTILITIES PRIOR TO BEGINNING ANY TIE-IN WORK.
- 9. ALL LIVE GAS WORK INCLUDING BUT NOT LIMITED TO TAPPING OF FITTINGS ON LIVE MAINS, STOPPING, MANIPULATING VALVE, ABANDONMENT, SHALL BE PERFORMED BY, OR AT THE DIRECTION AND UNDER THE DIRECT SUPERVISION OF EVERSOURCE GAS PERSONNEL AND IN ACCORDANCE WITH THE WRITTEN PROCEDURE. DRAWING CHANGES MAY ALSO REQUIRE A CHANGE TO THE PROCEDURE.
- 10. EXCAVATOR IS REQUIRED TO PROTECT EXISTING UTILITIES, STRUCTURES, LANDSCAPE FEATURES, SIGNAGE, CURBS, ETC. CARE SHOULD BE TAKEN NOT TO DISTURB OR DAMAGE SUCH ROADWAY, SIDEWALKS, AND GRASS DISTURBED SHALL BE RESTORED TO THE SATISFACTION OF THE CITY OR TOWN. PLANT BEDS WILL BE RELOCATED TO THEIR EXISTING REGULAR LOCATION.
- 11. IF THE PROJECT IS WITHIN 50 FEET OF A DISTRICT REGULATOR OR GATE STATION, ENSURE THAT A QUALIFIED I&R TECHNICIAN IS ON SITE.
- 12. ALL TRAFFIC CONTROL SHALL CONFORM TO THE LATEST EDITION OF THE MANUAL OF UNIFORM TRAFFIC CONTROL DEVICES (MUTCD), INCLUDING ALL REVISIONS AND ADDENDA. ALL TRAFFIC CONTROL DEVICES WILL BE SUPPLIED BY EXCAVATOR.
- 13. PROPERTY LINES, STRUCTURES AND EXISTING CONDITIONS DEPICTED ON PLANS ARE BASED ON EVERSOURCE GIS INFORMATION AND HAVE NOT BEEN VERIFIED BY LAND SURVEY UNLESS NOTED.
- 14. EXISTING SERVICES SHOWN ON PLAN ARE FOR INFORMATION ONLY. PROPOSED SERVICES ARE NOT SHOWN ON PLANS AND ARE TO BE INSTALLED PER EVERSOURCE CONSTRUCTION STANDARDS.
- 15. PROPOSED WORK SHALL BE PERFORMED AND COMPLETED IN COMPLIANCE WITH ALL PERMITS AND APPROVALS.
- 16. MAINS AND SERVICES SHALL BE PRESSURE TESTED IN ACCORDANCE WITH EVERSOURCE OM-205.
- 17. MAOP:

LP = 14" W.C.
LIP = 35 PSIG
IP = 60 PSIG
HP = 90 PSIG

18. ALL WORK SHALL BE PERFORMED PER EVERSOURCE, LOCAL, STATE AND FEDERAL REGULATIONS AND STANDARDS.

- 19. ALL PIPE WILL BE INSTALLED WITH A MINIMUM DEPTH IN ACCORDANCE WITH EVERSOURCE STANDARDS
- 20. SQUEEZE OPERATIONS SHOULD BE COMPLETED IN ACCORDANCE WITH OM-233
- 21. ENSURE ALL SERVICES BEING TRANSFERRED TO A HIGHER PRESSURE SYSTEM HAVE UPGRADED PRESSURE REGULATORS INSTALLED PRIOR TO ACTIVATION.
- 22. ENSURE VALVES ON EXISTING MAIN, WHERE PROPOSED MAIN WILL BE INSERTED HAVE BEEN MADE INOPERABLE.
- 23. ADDITIONAL VALVES AND TEES THAT ARE INCLUDED IN THE SCHEDULE OF MATERIALS MAY BE INSTALLED TEMPORARILY WHEN NEEDED TO FACILITATE TIE-INS AND PURGES.
- 24. METFIT FITTINGS MAY BE SUBSTITUTED FOR ELECTROFUSION FITTINGS WHERE NEEDED.
- 25. DO NOT SCALE FROM DRAWINGS.

ISSUED FOR	SEALED BY:	SEALED ON: 01/22/2021	DESIGNED IN ACCORDANCE WITH TITLE 49-PART 192 OF MINIMUM FEDERAL SAFETY STANDARDS AND GPTC GUIDE FOR GAS TRANSMISSION AND DISTRIBUTION PIPING SYSTEMS. LATEST EDITION.	FIELD VERIFY
ONSTRUCTION 01/21/2021	BARSIONAL ENGINE	LICENSE EXPIRATION:	ENERGINEERING 29 BARTLETT STREET	PRIOR TO PIPE
	SIGNATURE	06/30/2022	MARLBOROUGH, MA 01752 TEL. (630) 353-4000 FAX (630) 535-7777 WWW.ENENGINEERING.COM	

	0	ISSUED FOR C	ONSTRUCTION		01/21/2021	WS	/AB/EK	
	NO.	DESCRIPTION			DATE	DW/	/CK/AP	
			REVISION STAT	JS				
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	SHAW STREET MAIN RELAY							
DIMENSIONS	NEW BEDFORD, MASSACHUSETTS							
FABRICATION			GENERAL NOTE	ES				
	SCA	LE:NOT TO SCA		SHEE	T 2	OF 9		
	DF	RAWN BY / DATE _R 11/06/2020	CHECKED BY / DATE AB 01/12/2021		SHEET NUMBER		REV. NO.	
	APF	PROVED BY / DATE EK 01/21/2021	MANEB21PIP021R0	MA-N	NEB-21-PIP-021-	02	0	


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RETIRE

CI

30'

6"

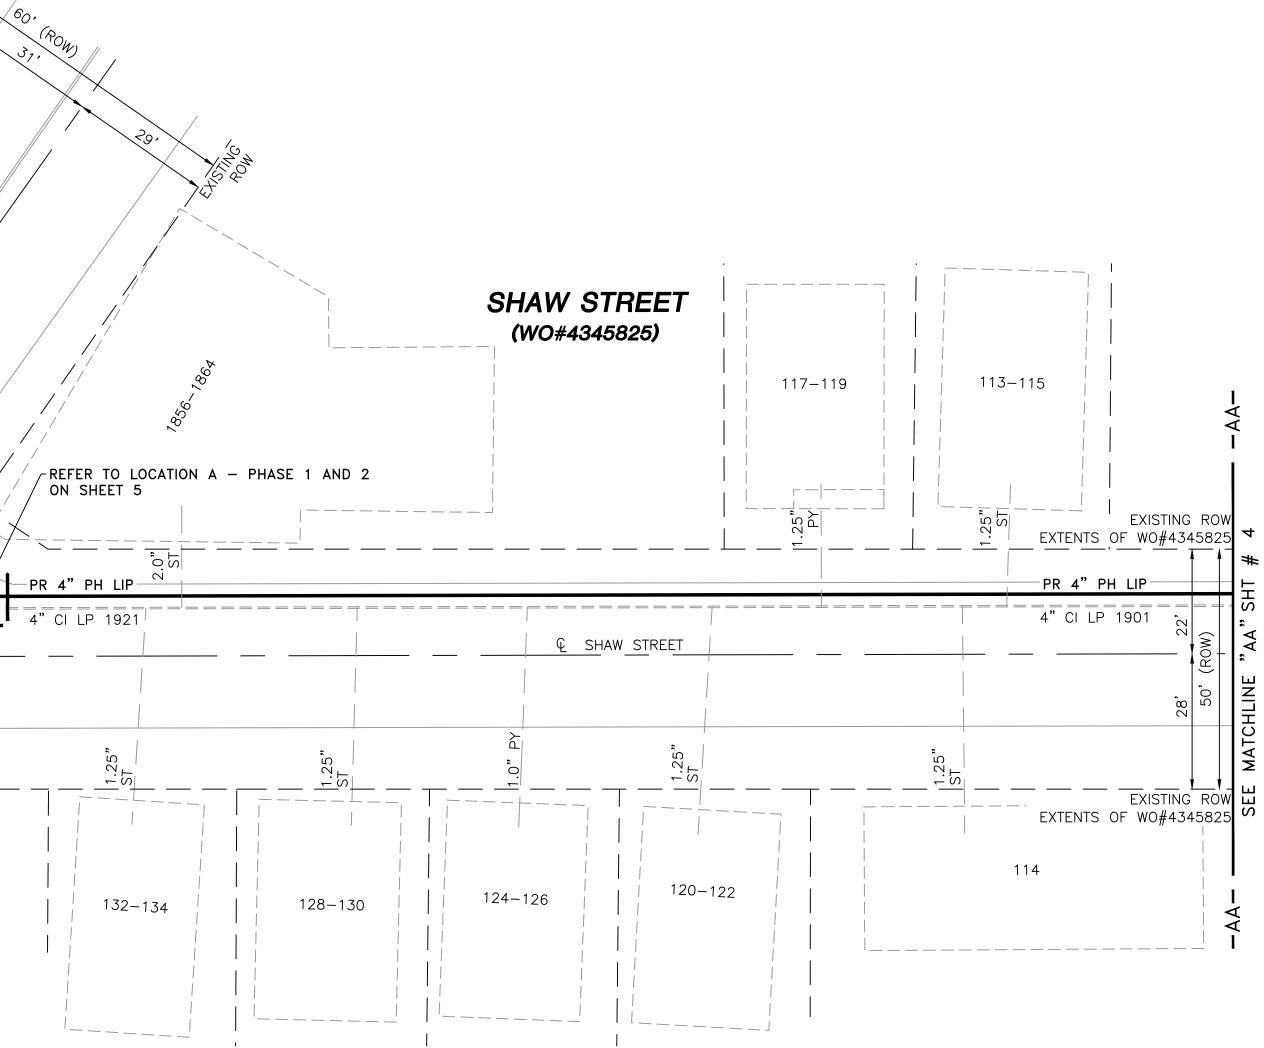


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01/21/2021	SIGNATURE	LICENSE EXPIRATION: 06/30/2022	ENERGINEERING 29 BARTLETT STREET MARLBOROUGH, MA 01752 TEL. (630) 353-4000 FAX (630) 535-7777 WWW.ENENGINEERING.COM	PRIOR TO PIPE






DRAWING LEGEND

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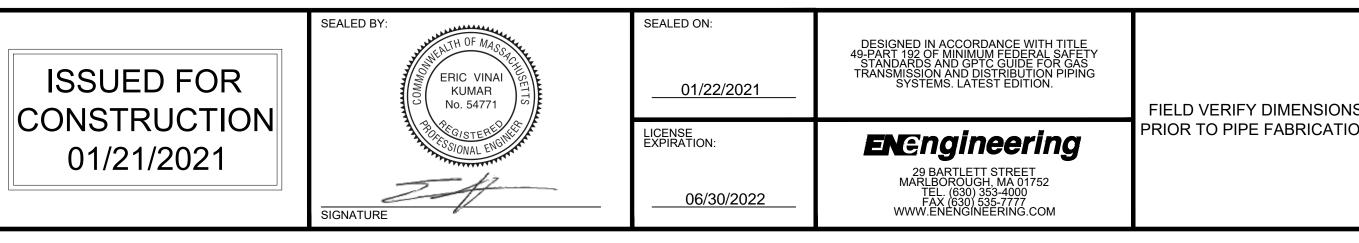
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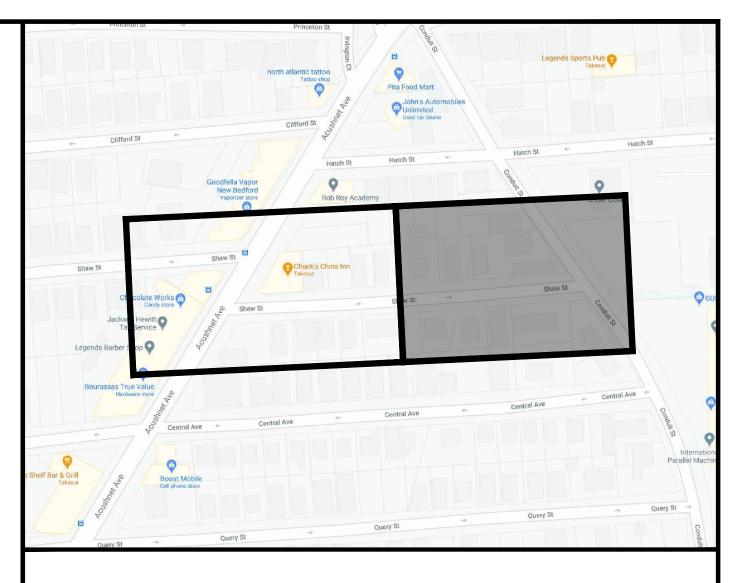
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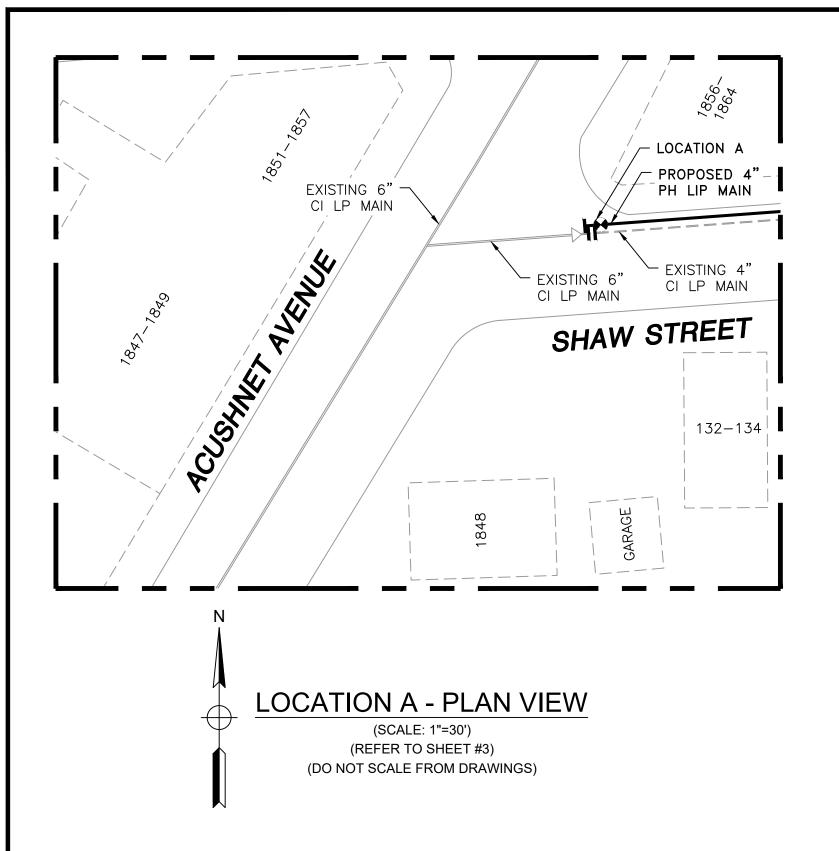


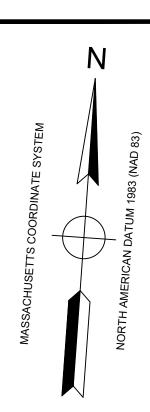


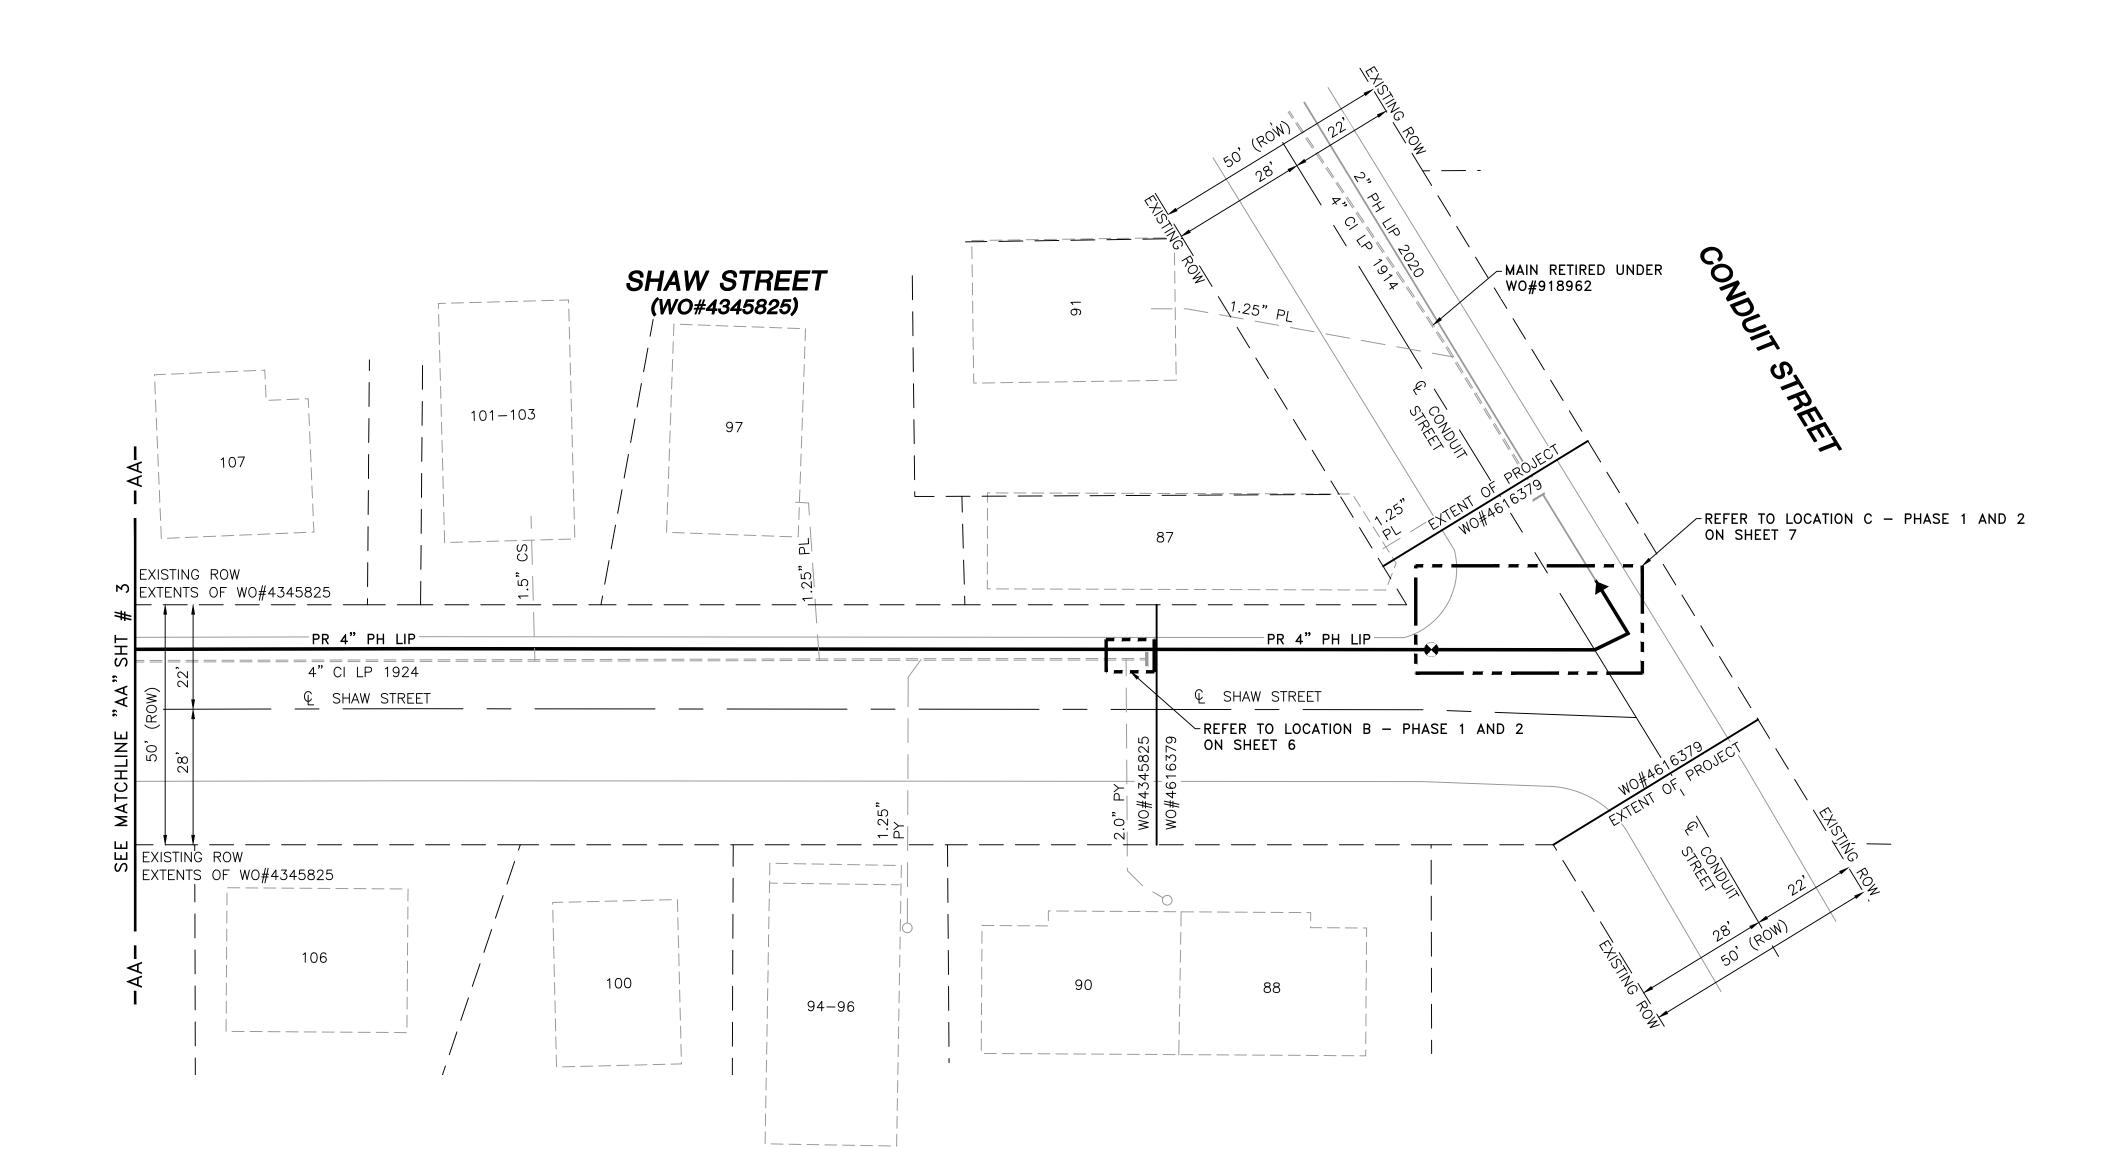


DRAWING LEGEND

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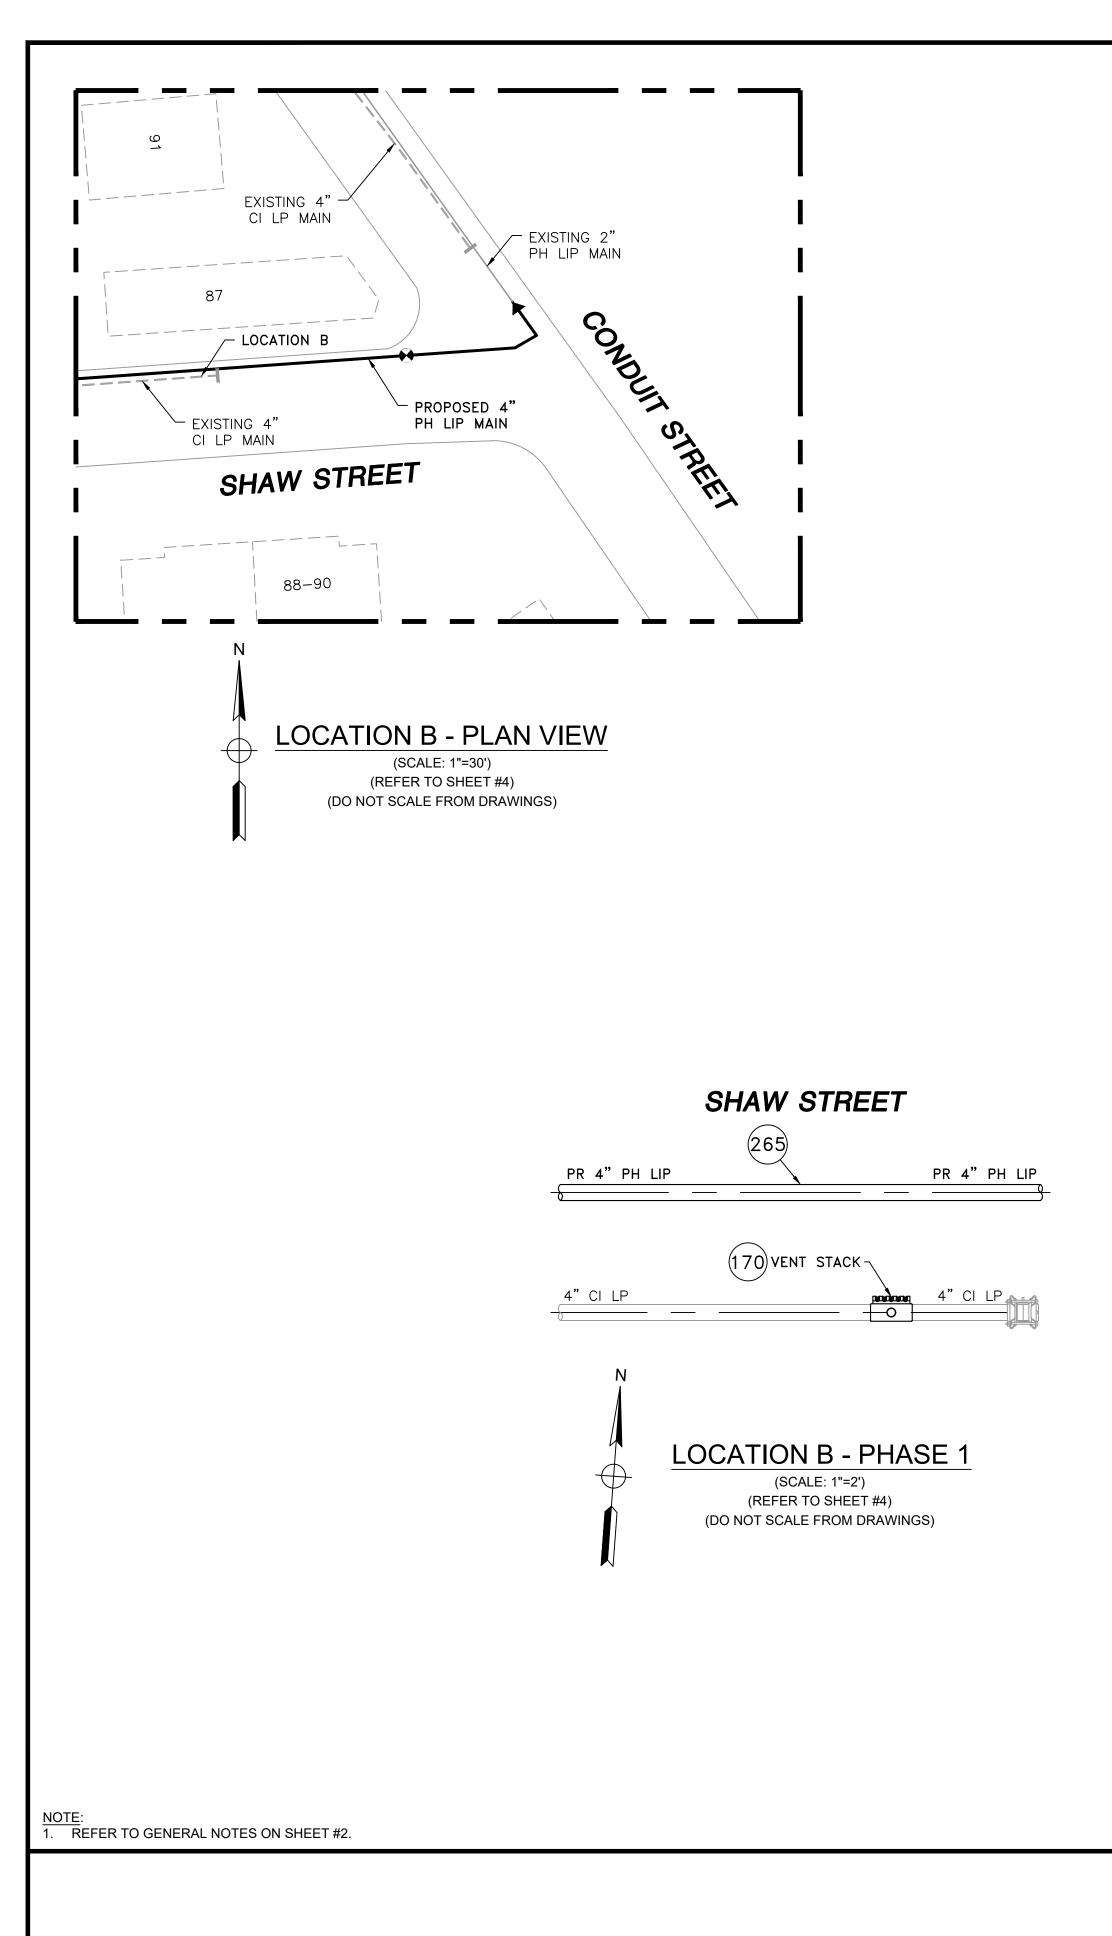
NOTE: 1. REFER TO GENERAL NOTES ON SHEET #2.

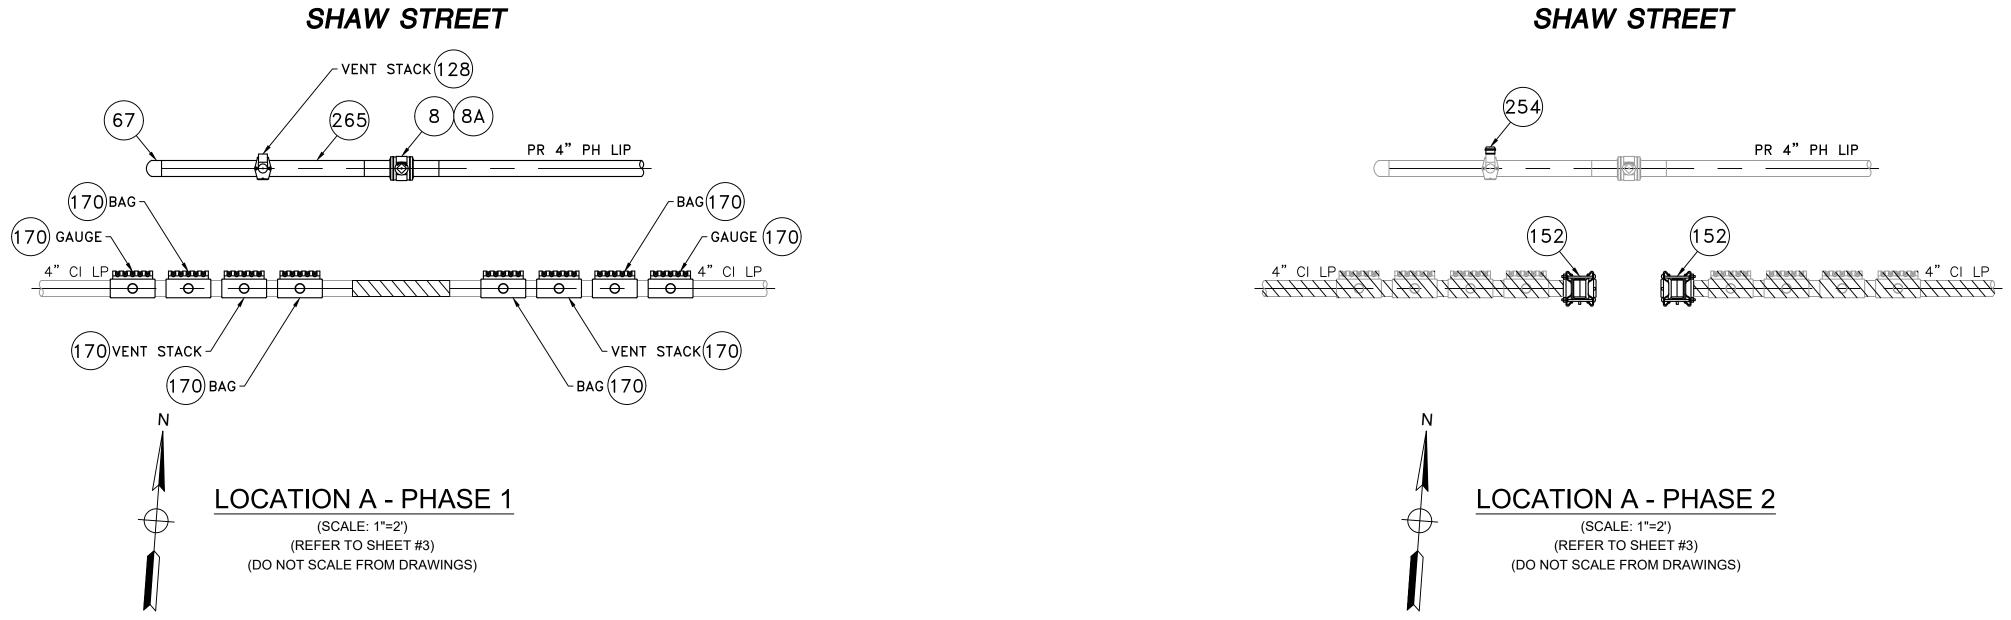

SHAW STREET MAIN RELAY - LOCATION A - SCHEDULE OF MATERIALS							
ITEM	QTY	SIZE	MAXIMO NO.	DESCRIPTION	MATERIAL		
8	1	4"	501002	BALL VALVE, BUTT FUSION, IPS, HDPE 3408/4710, SDR 11, ASTM D2513, ASME B16.40. FULL PORT, 1/4 TURN, KEROTEST POLYBALL OR APPROVED EQUAL.	ASTM D251		
8A	1	4"		BOX, VALVE, PLASTIC, SNAP-ON, ADJ, W/CI NON-LOCKING LID	PLASTIC		
67	AS REQUIRED	4"	542538	CAP, BUTT FUSION, IPS, HDPE 4710, SDR 11, ASTM D2513, ASTM D3350, ASTM D3261. PERFORMANCE PIPE OR APPROVED EQUAL.	ASTM D251		
128	1	4" X 2"	584304	HV TAPPING TEE, ELECTROFUSION, IPS X IPS, HDPE 3408/4710, SDR 11, ASTM D2513, ASTM D3350, ASTM D3261, ASTM F1055. CENTRAL PLASTICS OR APPROVED EQUAL.	ASTM D251		
152	2	4"	578128	END CAP, BOLTED MECHANICAL, CIP. SMITH-BLAIR MAXI-GRIP OR APPROVED EQUAL			
170	8	4" x 2"		BAND CLAMP, WITH WELDED 2" FNPT SERVICE OUTLET, 304L SS SINGLE SECTION BAND AND GAP BRIDGES, SS STUDS WITH TEFLON COATED HEX NUTS, COMPLETELY LINED WITH NITRILE RUBBER GASKET. MUELLER 540 SERVI-SEAL OR APPROVED EQUAL. COMPLETE WITH PLUG.			
254	AS REQUIRED	2"	581633	END CAP MECHANICAL COMPRESSION, SDR 11 IPS, DUPONT ZYTEL ST-801 NYLON BODY, 316 SS COMRESSION RING, INTERNAL STIFFENER, ASTM D-2513, ASTM F1924. METFIT OR APPROVED EQUAL.	ASTM D251		
265	10' +/-	4"	554008	PIPE, IPS, HDPE 3408/4710 SDR 11, ASTM D2513, ASTM D3350, PERFORMANCE PIPE OR APPROVED EQUAL	ASTM D251		

					0 ISSUED FOR C	ONSTRUCTION	01/21/2021	WS/AB/EK
					NO. DESCRIPTION		DATE	DW/CK/AP
						REVISION STAT	JS	
	SEALED BY:	SEALED ON:	DESIGNED IN ACCORDANCE WITH TITLE 49-PART 192 OF MINIMUM FEDERAL SAFETY STANDARDS AND GPTC GUIDE FOR GAS TRANSMISSION AND DISTRIBUTION PIPING SYSTEMS. LATEST EDITION.			EVERS	RCE ENERGY	
ISSUED FOR		01/22/2021	TRANSMISSION AND DISTRIBUTION PIPING SYSTEMS. LATEST EDITION.			SHAW STREET MAIN	RELAY	
CONSTRUCTION	No. 54771			FIELD VERIFY DIMENSIONS		NEW BEDFORD, MASSA	CHUSETTS	
CONSTRUCTION	RACISTERED STERED	LICENSE EXPIRATION:	ENCogingoring	PRIOR TO PIPE FABRICATION	LOCATION	A - PHASE 1, 2 AND SCH	EDULE OF MATERIA	LS
01/21/2021	3SIONAL END	EXFINATION.	EN @ngineering		SCALE: AS NOTED		SHEE	T 6 OF 9
0172172021	ki		29 BARTLETT STREET MARLBOROUGH, MA 01752		DRAWN BY / DATE LR 11/06/2020	CHECKED BY / DATE AB 01/12/2021	SHEET NUMBER	REV. NO.
	SIGNATURE	06/30/2022	29 BARTLETT STREET MARLBOROUGH, MA 01752 TEL. (630) 353-4000 FAX (630) 535-7777 WWW.ENENGINEERING.COM		APPROVED BY / DATE EK 01/21/2021	MANEB21PIP021R0	MA-NEB-21-PIP-021-0	06 0

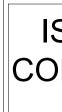PR 4"PH LIP






				SHAW
ITEM	QTY	SIZE	MAXIMO NO.	
				BAND CLAN
170	1	4" x 2"		WITH TEFLC
				APPROVED
265	10' +/-	4"	554008	PIPE, IPS, H

SHAW STREET

PR 4"PH LIP

4" CI LP 4" CI LP

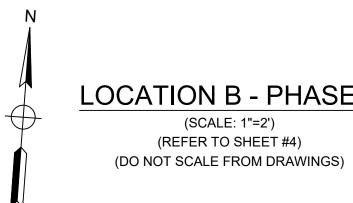


ISSUED FOR CONSTRUCTION	SEALED BY:	SEALED ON: 01/22/2021	DESIGNED IN ACCORDANCE WITH TITLE 49-PART 192 OF MINIMUM FEDERAL SAFETY STANDARDS AND GPTC GUIDE FOR GAS TRANSMISSION AND DISTRIBUTION PIPING SYSTEMS. LATEST EDITION.	FIELD VERIFY
01/21/2021	SIGNATURE	LICENSE EXPIRATION:	29 BARTLETT STREET	PRIOR TO PIPE
		06/30/2022	MARLBOROUGH, MA 01752 TEL. (630) 353-4000 FAX (630) 535-777 WWW.ENENGINEERING.COM	

STREET MAIN RELAY - LOCATION B - SCHEDULE OF MATERIALS					
DESCRIPTION	MATERIAL				
1P, WITH WELDED 2" FNPT SERVICE OUTLET, 304L SS SINGLE SECTION BAND AND GAP BRIDGES, SS STUDS					
N COATED HEX NUTS, COMPLETELY LINED WITH NITRILE RUBBER GASKET. MUELLER 540 SERVI-SEAL OR					
EQUAL. COMPLETE WITH PLUG.					
DPE 3408/4710 SDR 11, ASTM D2513, ASTM D3350, PERFORMANCE PIPE OR APPROVED EQUAL	ASTM D2513				

PR 4" PH LIP


LOCATION B - PHASE 2 (SCALE: 1"=2') (REFER TO SHEET #4)


> 0 ISSUED FOR CONSTRUCTION 01/21/2021 WS/AB/EK NO. DESCRIPTION DATE DW/CK/AP **REVISION STATUS EVERS©URCE** ENERGY SHAW STREET MAIN RELAY NEW BEDFORD, MASSACHUSETTS FY DIMENSIONS LOCATION B - PHASE 1, 2 AND SCHEDULE OF MATERIALS SCALE: AS NOTED SHEET 7 OF 9 DRAWN BY / DATE LR 11/06/2020 APPROVED BY / DATE EK 01/21/2021 CHECKED BY / DATE AB 01/12/2021 SHEET NUMBER REV. NO MA-NEB-21-PIP-021-07 0 MANEB21PIP021R0

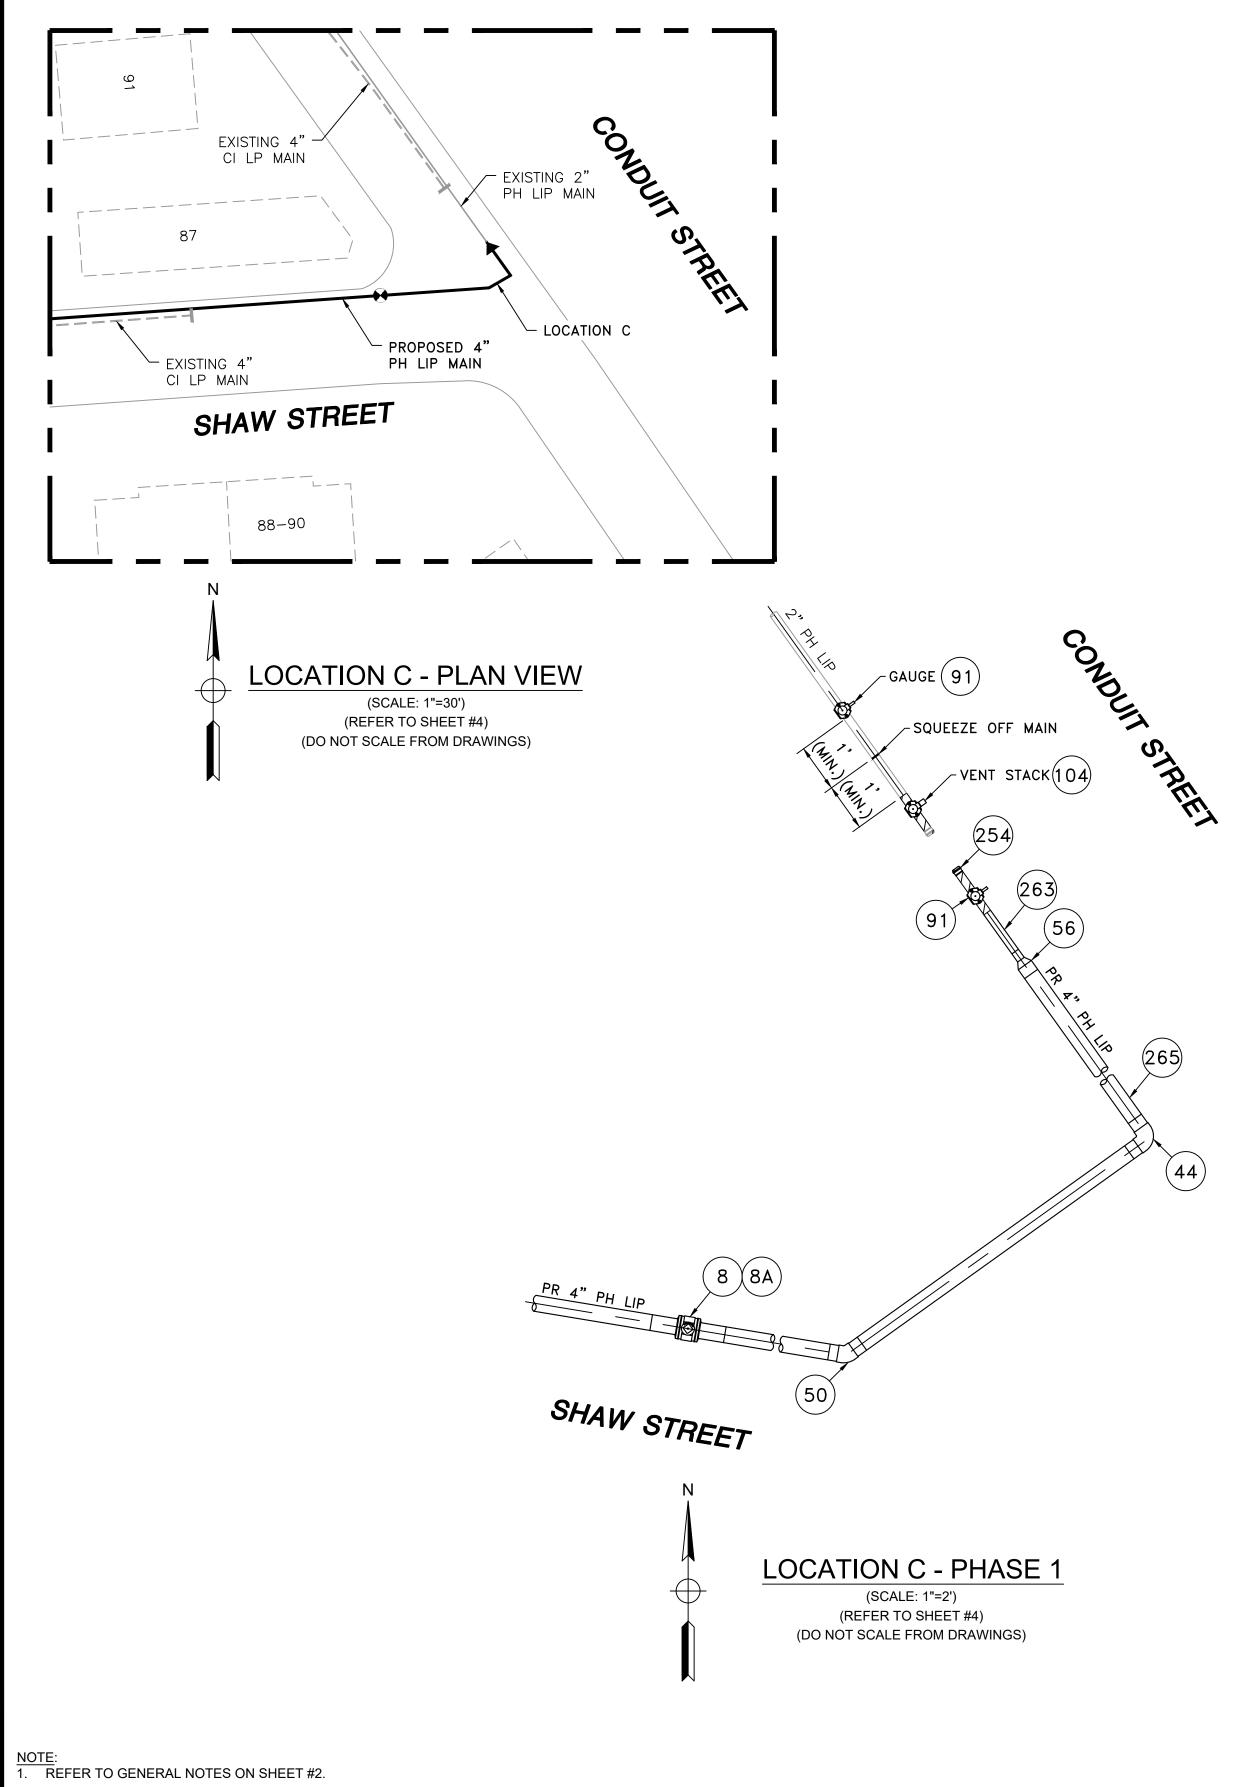

(44)

SHAW STREET MAIN RELAY - LOCATION C - SCHEDULE OF MATERIALS						
ITEM QTY SIZE MAXIMO NO.		MAXIMO NO.	DESCRIPTION	MATERIAL		
8	1	4"	501002	BALL VALVE, BUTT FUSION, IPS, HDPE 3408/4710, SDR 11, ASTM D2513, ASME B16.40. FULL PORT, 1/4 TURN, KEROTEST POLYBALL OR APPROVED EQUAL.	ASTM D251	
8A	1	4"		BOX, VALVE, PLASTIC, SNAP-ON, ADJ, W/CI NON-LOCKING LID	PLASTIC	
44	AS REQUIRED	4"	545341	ELBOW, 90 DEG, BUTT FUSION, IPS, HDPE 4710, SDR 11, ASTM D2513, ASTM D3350, ASTM D3261. PERFORMANCE PIPE OR APPROVED EQUAL.	ASTM D251	
50	AS REQUIRED	4"	545338	ELBOW, 45 DEG, BUTT FUSION, IPS, HDPE 4710, SDR 11, ASTM D2513, ASTM D3350, ASTM D3261. PERFORMANCE PIPE OR APPROVED EQUAL.	ASTM D251	
56	1	4" X 2"	555593	REDUCER, BUTT FUSION, IPS, HDPE 4710, SDR 11, ASTM D2513, ASTM D3350, ASTM D3261. PERFORMANCE PIPE OR APPROVED EQUAL.	ASTM D251	
91	3	2" X 1/2"	500866	TAPPING TEE, ELECTROFUSION, IPS X CTS, HDPE 3408/4710, SDR 11, ASTM D2513, ASTM D3350, ASTM D3261 ASTM F1055. CENTRAL PLASTICS OR APPROVED EQUAL.	ASTM D251	
104	1	2" X 1"	560779	TAPPING TEE, ELECTROFUSION, IPS X IPS, HDPE 3408/4710, SDR 11, ASTM D2513, ASTM D3350, ASTM D3261, ASTM F1055. CENTRAL PLASTICS OR APPROVED EQUAL.	ASTM D251	
254	AS REQUIRED	2"	581633	END CAP MECHANICAL COMPRESSION, SDR 11 IPS, DUPONT ZYTEL ST-801 NYLON BODY, 316 SS COMRESSION RING, INTERNAL STIFFENER, ASTM D-2513, ASTM F1924. METFIT OR APPROVED EQUAL.	ASTM D251	
255	AS REQUIRED	2"	579840	COUPLING, MECHANICAL COMPRESSION, SDR 11 IPS, DUPONT ZYTEL ST-801 NYLON BODY, 316 SS COMRESSION RING, INTERNAL STIFFENER, ASTM D-2513, ASTM F1924. METFIT OR APPROVED EQUAL.	ASTM D251	
263	5' +/-	2"	554025	PIPE, IPS, HDPE 3408/4710 SDR 11, ASTM D2513, ASTM D3350, PERFORMANCE PIPE OR APPROVED EQUAL	ASTM D251	
265	65' +/-	4"	554008	PIPE, IPS, HDPE 3408/4710 SDR 11, ASTM D2513, ASTM D3350, PERFORMANCE PIPE OR APPROVED EQUAL	ASTM D251	
270	AS REQUIRED	1/2"	542609	END CAP, MECHANICAL STAB, CTS, HDPE, PE 4710/3408, ASTM D2513, WITH SS GRIPPING SUPPORT RING, ACETAL COLLET AND SPACER RETAINER RING, PE THRUST WASHER, BUNA-N O-RING, ZINC-PLATED CS INSERT STIFFENER, PERFECTION WITH END CAP OR APPROVED EQUAL.	ASTM D251	

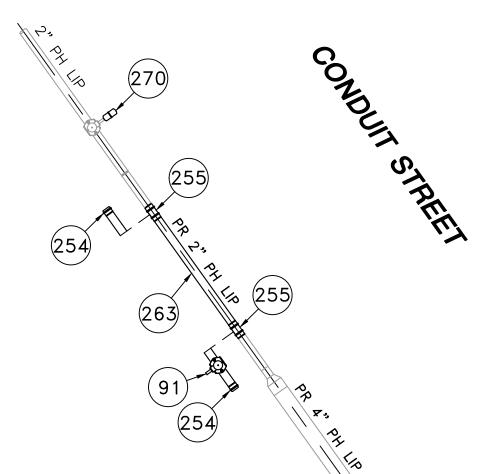


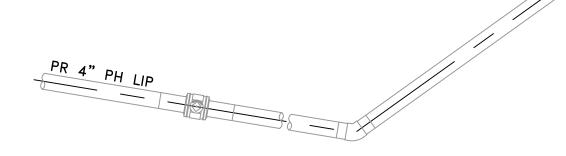

SHAW STREET LOCATION C - PHASE 2 (SCALE: 1"=2') (REFER TO SHEET #4) (DO NOT SCALE FROM DRAWINGS)

ISSUED FOR	SEALED BY:	SEALED ON: 01/22/2021	DESIGNED IN ACCORDANCE WITH TITLE 49-PART 192 OF MINIMUM FEDERAL SAFETY STANDARDS AND GPTC GUIDE FOR GAS TRANSMISSION AND DISTRIBUTION PIPING SYSTEMS. LATEST EDITION.	FIELD VERIFY D PRIOR TO PIPE F
CONSTRUCTION 01/21/2021		LICENSE EXPIRATION: 06/30/2022	29 BARTLETT STREET MARLBOROUGH, MA 01752 TEL. (630) 353-4000 FAX (630) 535-7777 WWW.ENENGINEERING.COM	

	0	ISSUED FOR C	CONSTRUCTION		01/21/2021	WS/	AB/EK	
	NO.	DESCRIPTION			DATE	DW/	/CK/AP	
			REVISION STAT	US				
	EVERS © URCE							
	SHAW STREET MAIN RELAY							
DIMENSIONS	NEW BEDFORD, MASSACHUSETTS							
FABRICATION	LOCATION C - PHASE 1, 2 AND SCHEDULE OF MATERIALS							
	SCA	LE: AS NOTED	SHEET 8 OF 9					
		RAWN BY / DATE	CHECKED BY / DATE	S	HEET NUMBER		REV. NO.	
	APF	<u>.R 11/06/2020</u> ROVED BY / DATE EK 01/21/2021	AB 01/12/2021 MANEB21PIP021R0	MA-NE	EB-21-PIP-021-	·08	0	

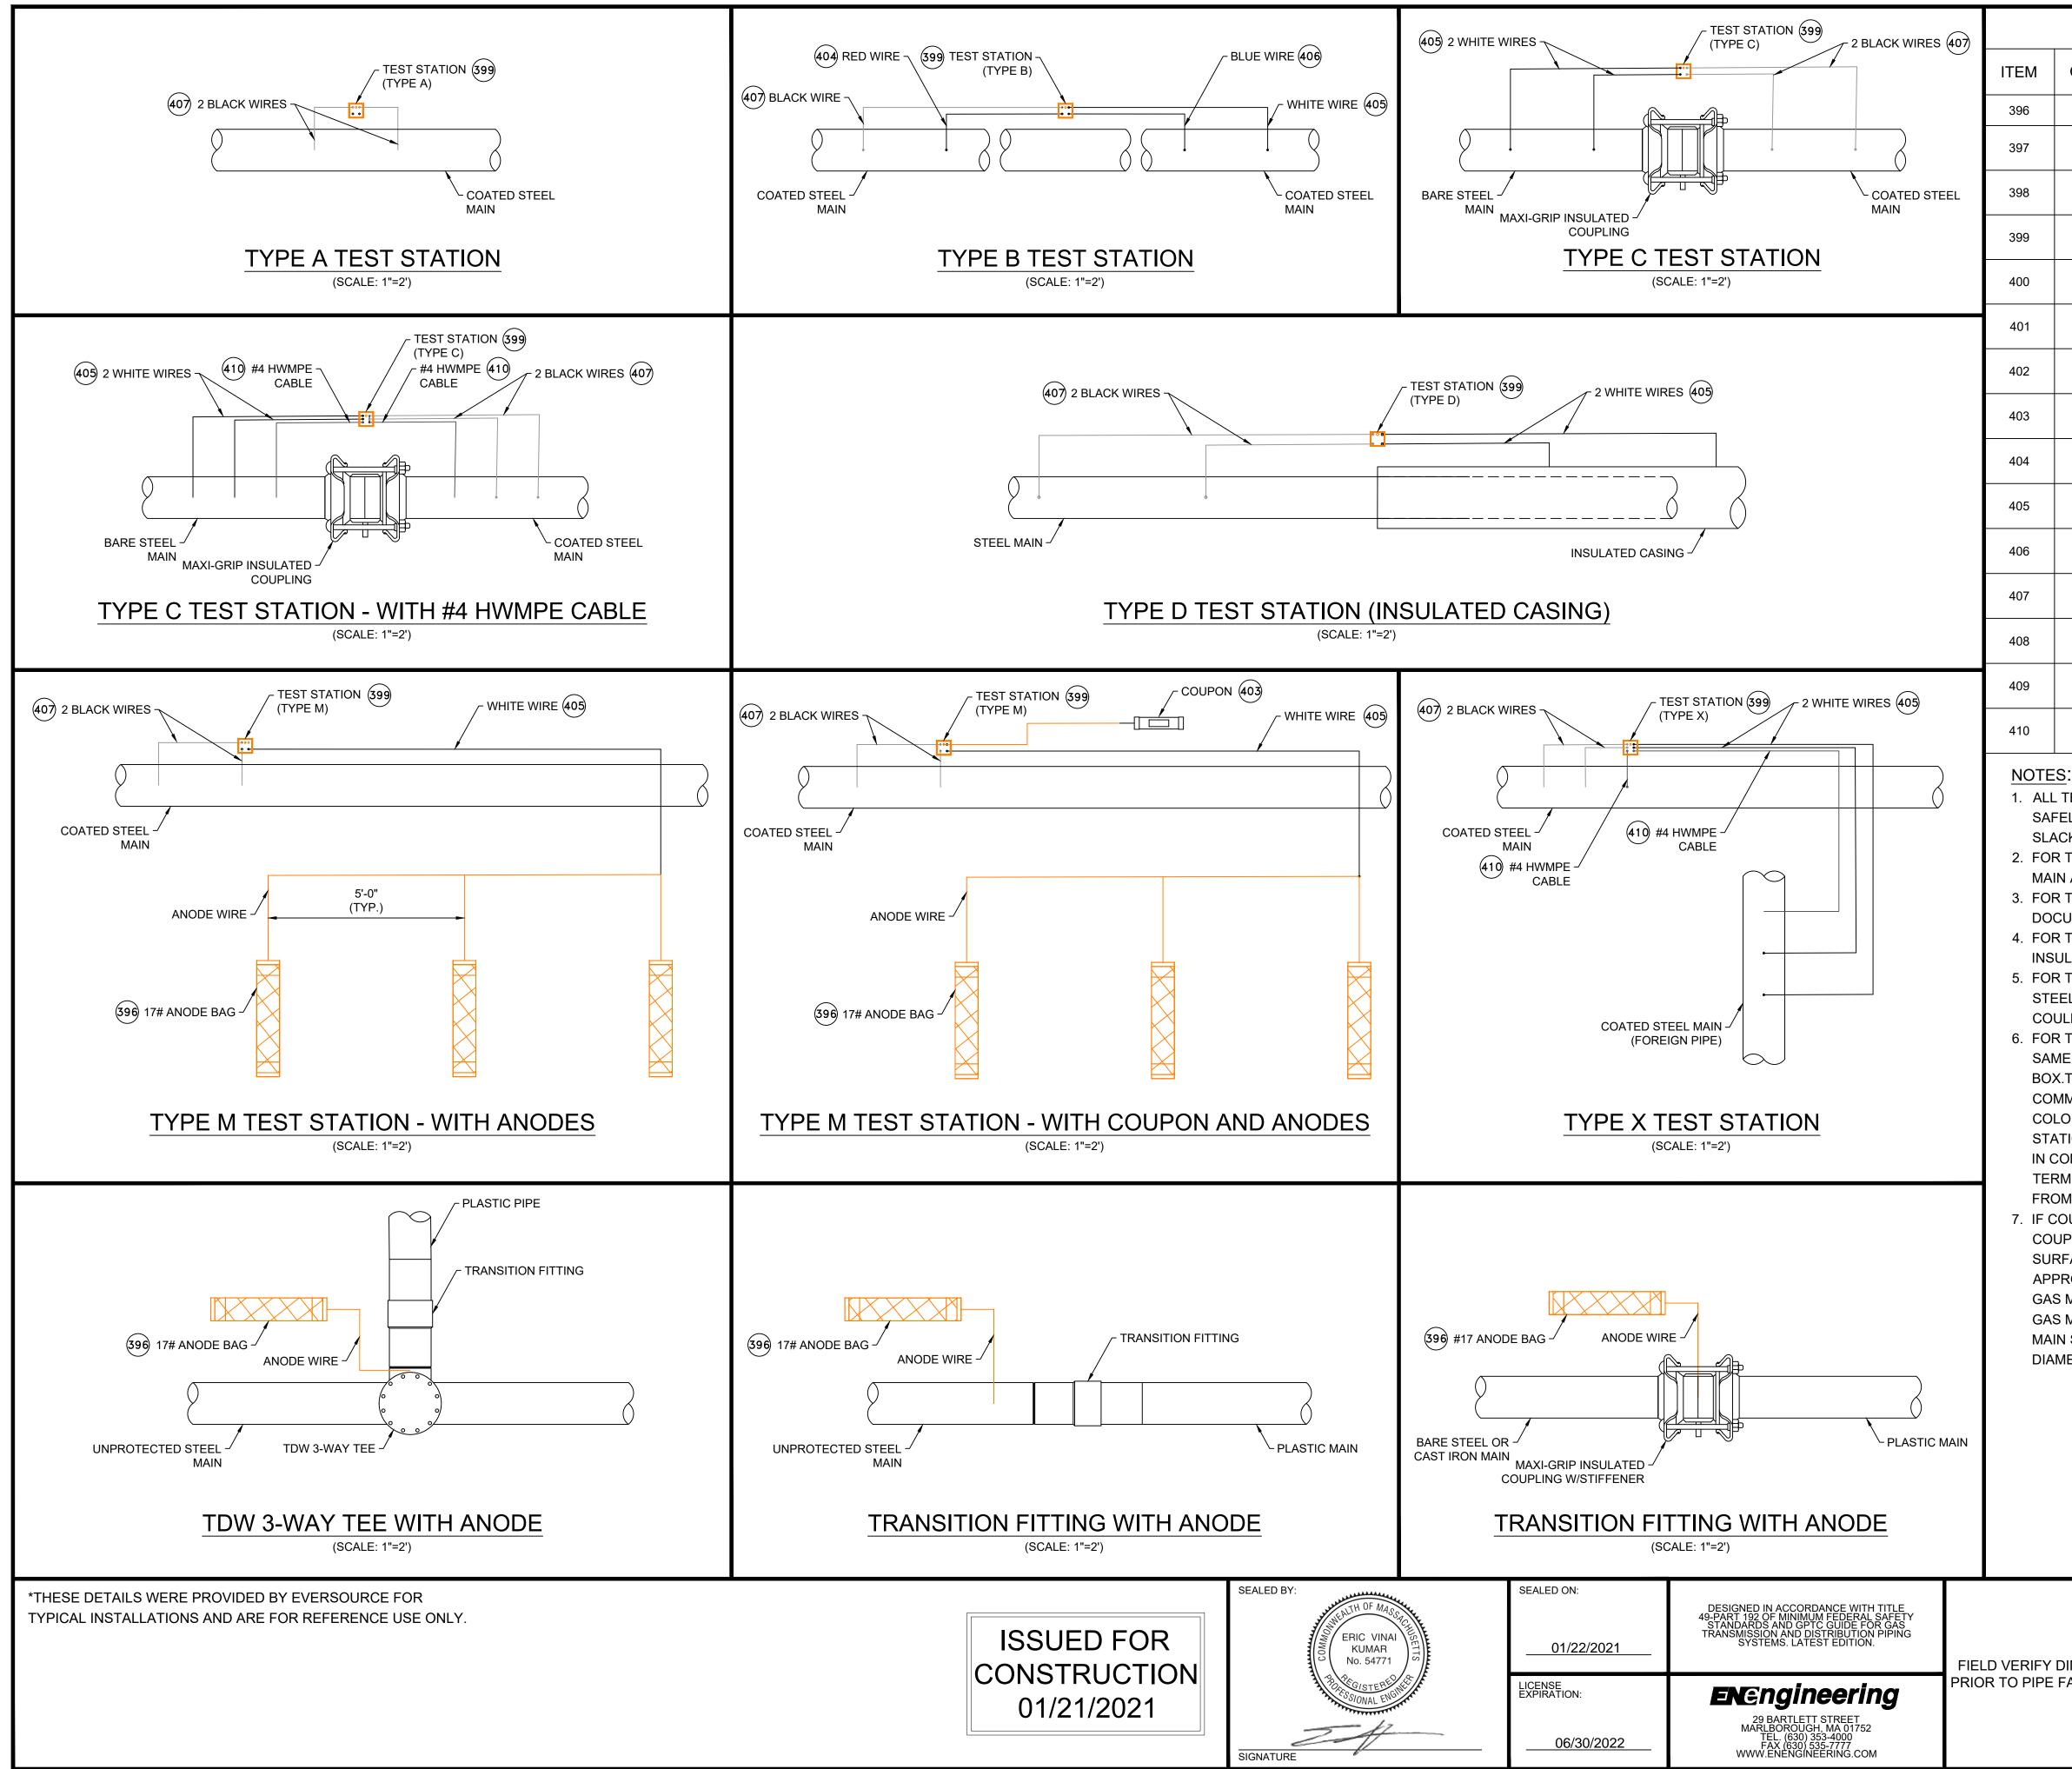

CATHODIC PROTECTION BILL OF MATERIALS						
QTY	SIZE	MAXIMO NO.	DESCRIPTION			
X	EA	577776	ANODE,BAG, 17 LB NET, HIGH POTENTIAL MAGNESIUM, W/ 10 FT #10 AWG TW ORANGE LEAD WIRE, PACKED IN CARDBOARD BOX 42 LB TOTAL WEIGHT			
x	EA	517626	CONNECTOR, SPLIT BOLT, 12 SOLID - 10 STRANDED, CU TO CU, HOUSING (COVER) MATE IN 590389,			
x	EA	590389	HOUSING, 50 V MAX, 10 AWG MAX, FOR PROTECTING TRACER WIRE SPLICES, USED WITH CONNECTOR IN 517626. 10/BAG			
x	EA	590871	BOX VALVE, TEST STATION, CP TEST #178, 10-1/4 IN DIA. LID, 8-3/8 IN I.D. 16 IN H., ASTM A48 CL 25 CAST IRON, FOR OFF-ROAD USE ONLY			
x	BOX	508567	POWDER, CARTRIDGE, TYPE IS F-33, ALLOY , CAP COLOR CLEAR, 15 GM CHARGE, 20/PAC, FOR STEEL PIPE			
x	EA	559168	SLEEVE,ELECTRICAL, #14 TO 10 AWG, W/ THERMITE WELDER, FOR CATHODIC PROTECTION			
x	ES	584045	EDI CONCENTRIC COUPON ASSEMBLY INCLUDING UCB-ZIN-LW010, 10 FT OF CABLE			
x	ES	603126	EDI CONCENTRIC COUPON ASSEMBLY INCLUDING UCB-ZIN-LW025, 25 FT OF CABLE			
x	ROLL	603140	WIRE,ELECTRICAL, THHN, 1/C, #10 AWG, STRANDED, RED, INSULATED, CU, 500 FT SPOOL, WIRE			
x	ROLL	578415	WIRE,ELECTRICAL, THHN, 1/C, #10 AWG, STRANDED, WHITE, INSULATED, CU, 500 FT SPOOL, WIRE			
x	ROLL	603141	WIRE,ELECTRICAL, THHN, 1/C, #10 AWG, STRANDED, BLUE INSULATED, CU, 500 FT SPOOL, WIRE			
x	ROLL	603139	WIRE,ELECTRICAL, THHN, 1/C, #10 AWG, STRANDED, BLACK, INSULATED, CU, 500 FT SPOOL,WIRE			
x	EA	500804	WELDER,THERMITE, THERMITE, FOR GAS PIPE, #12 CABLE,HORIZONTAL STEEL PIPE 4 IN AND LARGER DIAMETER			
x	EA	500805	WELDER,THERMITE, THERMITE, FOR GAS PIPE, #12 CABLE, HORIZONTAL STEEL PIPE 3/4 - 3-1/2 IN DIAMETER			
x	FT	513850	CABLE, INSULATED, CATHODIC PROTECTION, 1/C, #4 AWG, 7 STR, 600 V, BLACK, HMWPE, CU, 1000 FT ROLLS			

1. ALL TEST STATION BOXES SHOULD BE INSTALLED IN A SAFE LOCATION WHERE ONE INDIVIDUAL CAN SAFELY OPEN AND ACCESS THE TEST WIRES. ALL TEST WIRES INSIDE THE BOX SHOULD HAVE ENOUGH SLACK ON THE WIRES SO THEY CAN EXTEND A MINIMUM OF 12" ABOVE GRADE.

2. FOR TYPE A TEST STATIONS, THE TWO WIRES SHOULD BE THERMITE WELDED TO THE COATED STEEL MAIN AND BE THE SAME COLOR. (COUPONS COULD BE ADDED TO THE TEST STATION TYPE) 3. FOR TYPE B TEST STATIONS, EACH OF THE FOUR WIRES SHOULD BE A DIFFERENT COLOR AND DOCUMENTED

4. FOR TYPE C TEST STATIONS, THE WIRES SHOULD BE THE SAME COLOR ON EACH SIDE OF THE INSULATED COUPLING. (ANODES AND/OR COUPONS COULD BE ADDED TO THIS TEST STATION TYPE) 5. FOR TYPE D TEST STATIONS WHICH ARE AT A CASING, WHITE WIRES ARE NORMALLY INSTALLED ON THE STEEL CASING AND BLACK WIRES ON INSTALLED ON THE CARRIER PIPE. (ANODES AND/OR COUPONS COULD BE ADDED TO THIS TEST STATION TYPE).

6. FOR TYPE M TEST STATIONS, THE TWO WIRES THERMITE WELDED TO THE CARRIER PIPE SHOULD BE THE SAME COLOR WIRE. THERE IS ALSO MAGNESIUM ANODE(S) WIRE(S) LOCATED INSIDE THE TEST STATION BOX.THE WIRE COLOR (TYPICALLY ORANGE) FOR THE ANODES. IF THE ANODE WIRES ARE SPLICED TO A COMMON ANODE HEADER CABLE, THE ANODE HEADER CABLE SHOULD BE A (WHITE OR RED) DIFFERENT COLOR WIRE THAN THE WIRE THAT WAS THERMITE WELDED TO THE CARRIER PIPE. AT A TYPE M TEST STATION, NO MAGNESIUM ANODES SHOULD BE DIRECTLY THERMITE WELDED TO THE CARRIER PIPE OR IN CONTACT WITH THE CARRIER PIPE. THE ANODE HEADER WIRE OR INDIVIDUAL ANODE WIRES SHOULD TERMINATE INSIDE THE TEST STATION BOX. ANODES SHOULD BE SPACED A MINIMUM OF 5' ON CENTER FROM EACH OTHER AND A MINIMUM OF 12" AWAY AND BELOW THE BOTTOM OF THE STEEL MAIN. 7. IF COUPONS ARE TO BE INSTALLED, FIRST REMOVE THE PROTECTIVE LABEL COVERING THE STEEL COUPON AND THE RED STICKERS COVERING EACH SENSING PORT. CLEAN THE ENTIRE STEEL COUPON SURFACE WITH ALCOHOL TO REMOVE THE CORROSION INHIBITOR .PLACE THE COUPON ASSEMBLY APPROXIMATELY 12" FROM THE GAS MAIN BEING MONITORED WITH THE SENSING PORTS FACING THE GAS MAIN. THE COUPON ASSEMBLY SHOULD BE LOCATED ADJACENT TO THE BOTTOM PORTION OF THE GAS MAIN, ANYWHERE BETWEEN 3 O'CLOCK AND 9 O'CLOCK. THE SOIL BETWEEN THE COUPON AND THE MAIN SHOULD BE WELL COMPACTED AND CONTAIN NO ROCKS LARGER THAN A CENTIMETER IN DIAMETER OR FOREIGN MATERIAL.

0	ISSUED FOR C	ONSTRUCTION		01/21/2021	WS/	/AB/EK	
NO.	DESCRIPTION			DATE	DW/	/CK/AP	
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DF	RAWN BY / DATE	CHECKED BY / DATE	Ş	SHEET NUMBER		REV. NO.	
APF	PROVED BY / DATE	MANEB21PIP021R0	MA-N	IEB-21-PIP-021-	09	0	
	SCA DF L APF	NO. DESCRIPTION	EVERSEU SHAW STREET MAIN NEW BEDFORD, MASSA STANDARD CORROSIO SCALE:1"=2' (DO NOT SCALE FROM DRAWIN DRAWN BY / DATE LR 11/06/2020 APPROVED BY / DATE AB 01/12/2021 APPROVED BY / DATE	NO. DESCRIPTION REVISION STATUS EVERSEURCE ENERG SHAW STREET MAIN RELAY NEW BEDFORD, MASSACHUSE STANDARD CORROSION DETA SCALE:1"=2' (DO NOT SCALE FROM DRAWINGS) DRAWN BY / DATE LR 11/06/2020 APPROVED BY / DATE AB 01/12/2021 MANED 24 DID0 24 DO	NO. DESCRIPTION DATE REVISION STATUS EVERSEURE EVERSEURE EVERSEURE ENERGY SHAW STREET MAIN RELAY NEW BEDFORD, MASSACHUSETTS STANDARD CORROSION DETAILS SCALE:1"=2' (DO NOT SCALE FROM DRAWINGS) SHEET NUMBER DRAWN BY / DATE CHECKED BY / DATE LR 11/06/2020 AB 01/12/2021 MA-NEB-21-PIP-021- APPROVED BY / DATE MANEB-21-PIP-021-	NO. DESCRIPTION DATE DW/ REVISION STATUS EVERSECE DEVERSECE EVERSECE ENERGY SHAW STREET MAIN RELAY NEW BEDFORD, MASSACHUSETTS STANDARD CORROSION DETAILS SCALE:1"=2' (DO NOT SCALE FROM DRAWINGS) SHEET 9 DRAWN BY / DATE CHECKED BY / DATE LR 11/06/2020 APPROVED BY / DATE MANED 24 DID024 DO	