

SHEET INDEX		
SHEET NUMBER	DESCRIPTION	
1	SITE PLAN, DRAWING LEGEND AND SHEET INDEX	
2	GENERAL NOTES AND SCHEDULE OF MATERIALS	
3	INSTALLATION PLAN	
4	INSTALLATION PLAN	
5	INSTALLATION DETAIL #1 AND SCHEDULE OF MATERIALS	
6	INSTALLATION DETAIL #2 AND SCHEDULE OF MATERIALS	

EVERSEURCE ENERGY

STOWELL STREET MAIN RELAY NEW BEDFORD, MASSACHUSETTS ENE PROJECT #: 2000000.36 EVERSOURCE PROJECT #: 1301152



SITE PLAN


NEW BEDFORD, MASSACHUSETTS (NOT TO SCALE)

SCOPE OF WORK

RELAY 250' OF 3" LP CI AND 335' OF 4" LP CI WITH 595' OF 2" LIP PH ON STOWELL STREET FROM FIELD STREET TO DARTMOUTH STREET.

SEALED ON:

ISSUED FOR CONSTRUCTION 01/06/20

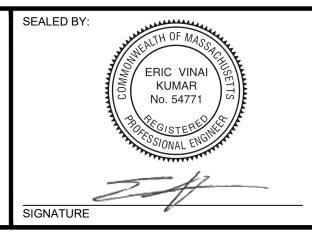

01/08/2020	EVERSOURCE ENERGY REVIEWER ENGINEERING
NSE IRATION:	
06/30/2020	
	EVERSOURCE ENERGY REVIEWER CONSTRUCTION

ENEngineering 29 BARTLETT STREET MARLBOROUGH, MA 01752 TEL. (630) 353-4000 FAX (630) 535-7777 WWW.ENENGINEERING.COM

FIELD VERIFY DIMENSIONS PRIOR TO PIPE FABRICATION

LOCUS PLAN NOT TO SCALE

	DRAWI	NG LEGEND	
	UTILITY POLE		EXISTING GAS MAIN
*	LIGHT POLE	=======	RETIRED GAS MAIN
	CATCH BASIN		PROPOSED GAS MAIN
∞	FIRE HYDRANT		EXISTING SERVICE
\bigcirc	UTILITY MANHOLE		RIGHT OF WAY
E	ELECTRIC MANHOLE	—— Е	ELECTRIC
T	TELEPHONE MANHOLE	— т —	TELEPHONE
W	WATER MANHOLE	W	WATER
	SANITARY MANHOLE	$\!$	SANITARY SEWER
	STORM MANHOLE	<(<(<(<	STORM SEWER
•	EXISTING REDUCER	>	PROPOSED REDUCER
1	EXISTING CAP	l	PROPOSED CAP
\otimes	EXISTING VALVE	•	PROPOSED VALVE
	EXISTING COUPLING		PROPOSED COUPLING

Α	ISSUED FOR CONSTRUCTION	01/06/2020	MR/AB/EK
VO .	DESCRIPTION	DATE	DW/CK/AP
	REVISION STATUS		

EVERS©URCE

STOWELL STREET MAIN RELAY NEW BEDFORD, MASSACHUSETTS SITE PLAN, DRAWING LEGEND AND SHEET INDEX SCALE: NOT TO SCALE

SHEET 1 OF 6 SHEET NUMBER MA-20-PIP-NEB-022-01 MA20PIPNEB022R0

- 1. MAINS AND SERVICES SHALL BE PRESSURE TESTED IN ACCORDANCE WITH EVERSOURCE OM-205. AT A MINIMUM TEST PRESSURE SHALL BE 90 PSIG FOR 4 HOURS. TEST MEDIUM SHALL BE NITROGEN OR
- 2. MAOP LP = 14" W.C. LIP= 35 PSIG.
- 3. CONTRACTOR TO LOCATE ALL UNDERGROUND FACILITIES PRIOR TO DIGGING.
- 4. BACKFILL WITH SAND WHERE PIPE TRENCH IS UNDER OR WITHIN 2' OF PAVEMENT, CURB, OR SIDEWALK.
- 5. ALL RIGHT-OF-WAY MUST BE STAKED BEFORE GAS MAIN CAN BE INSTALLED, IF INSTALLED IN OFF-STREET ALIGNMENT.
- 6. COORDINATE WITH EVERSOURCE GAS INSPECTOR FOR LOCATION OF UNDERGROUND UTILITIES PRIOR TO STARTING ANY EXCAVATION. EXERCISE CARE WHEN EXCAVATING NEAR EXISTING STRUCTURES.
- UTILITY LOCATIONS SHOWN ON PLANS ARE APPROXIMATE AND MAY NOT BE ALL INCLUSIVE. CONTRACTOR SHALL CALL 811 AND LOCAL GOVERNMENT AGENCIES PRIOR TO CONSTRUCTION FOR ALL UTILITY LOCATIONS.
- 8. ALL WORK SHALL BE PERFORMED PER EVERSOURCE, LOCAL, STATE AND FEDERAL REGULATIONS & STANDARDS.
- 9. CONTACT CITY OF NEW BEDFORD AND DEPARTMENT OF PUBLIC WORKS PRIOR TO COMMENCEMENT OF WORK AND PRIOR TO ANY PROPOSED ROAD CLOSURES.
- 10. CONTACT MASSACHUSETTS DEPARTMENT OF TRANSPORTATION WHEN REQUIRED.
- 11. ALL DISTURBED SOIL AND PAVEMENT SHALL BE RESTORED TO MATCH EXISTING CONDITION.
- 12. CONTACT PROJECT MANAGER PRIOR TO ANY FIELD CHANGES.
- 13. CONTRACTOR SHALL AVOID IMPACTING ANY AND ALL PRIVATE DRAINS AND DRIVEWAY CULVERTS.
- 14. ALL SEWER LATERALS THAT ARE CROSSED SHALL BE DOCUMENTED PRIOR TO AND AFTER CONSTRUCTION TO ENSURE NO DAMAGE WAS MADE TO EXISTING PIPES & STRUCTURES.
- 15. EXISTING GAS SERVICE LOCATIONS ARE APPROXIMATE & SHALL BE VERIFIED IN FIELD.
- 16. ALL PIPE TO BE INSTALLED WITH A MINIMUM DEPTH IN ACCORDANCE WITH EVERSOURCE STANDARDS.
- 17. ALL PROPOSED PIPE WILL BE INSTALLED VIA OPEN CUT/DIRECT BURY UNLESS OTHERWISE SPECIFIED.
- 18. THIS DOCUMENT REQUIRES A REVISION IF ANY OF THE FOLLOWING ARE REQUIRED;
 - 1) IF THE TIE IN POINT MOVES TO A DIFFERENT LOCATION THAN SHOWN.
 - 2) IF A CHANGE TO THE GAS FLOW PATH INCLUDING BUT NOT LIMITED TO THE LOCATION OR ORIENTATION OF TEES, BRANCHES, AND HOT TAP FITTING OR A CHANGE IN THE LOCATION OF VALVES IS REQUIRED.
 - 3) IF THE WORK IS WITHIN 50 FT OF A PRESSURE REGULATING STATION, DISTRICT REGULATOR OR GATE STATION AND ADDITIONAL OFFSETS ARE REQUIRED THAN WHAT IS SHOWN.
 - 4) A CHANGE IN PIPE SIZE, MATERIAL, OR WALL THICKNESS IS REQUIRED.
- 19. EXISTING CONDITIONS INCLUDING LOCATION, SIZE, MATERIAL, INTERNAL PRESSURE, RATINGS OF GAS FACILITIES ARE BASED OFF HISTORICAL DOCUMENTATION AND HAS NOT BEEN FIELD VERIFIED. WHEN THE PIPE IS EXPOSED THIS DRAWING OR PROCEDURE REQUIRES A REVISION IF GAS FACILITIES ARE FOUND TO MEET ANY OF THE FOLLOWING;
 - 1) PIPE IS OF A DIFFERENT MATERIAL, SIZE, WALL THICKNESS OR PRESSURE CLASS THAN SHOWN. 2) INTERNAL PRESSURE IS MEASURED AND IS FOUND NOT TO BE CONSISTENT WITH THE OPERATING
 - 3) IF THE GAS FLOW PATH INCLUDING BUT NOT LIMITED TO THE ORIENTATION OF TEES, BRANCHES, AND HOT TAP FITTING OR THE LOCATION OF VALVES IS NOT AS SHOWN.
 - 4) IF THE MAIN IS FOUND TO BE OVER 5'FROM WHERE IS IT IS DIMENSIONED.
 - 5) IF MULTIPLE OR ADDITIONAL MAINS AND SERVICES ARE FOUND THAN WHAT IS SHOWN.
- 20. SQUEEZE LOCATIONS ARE SHOWN DIAGRAMMATICAL. SQUEEZE OPERATIONS SHOULD BE COMPLETED IN ACCORDANCE WITH OM-233.
- 21. MATERIAL AND CONSTRUCTION SHALL CONFORM TO EVERSOURCE GAS STANDARDS.
- 22. THE LOCATIONS OF EXISTING UTILITIES AND UNDERGROUND STRUCTURES ARE APPROXIMATE AND MUST BE FIELD VERIFIED. ADDITIONAL UNDERGROUND FACILITIES MAY EXIST THAT ARE NOT SHOWN ON THESE DRAWINGS WHICH MAY REQUIRE ADDITIONAL OFFSETS IN THE PIPELINE.
- 23. LOCATIONS SHOWN ON THE DRAWING ARE APPROXIMATE. EXACT LOCATIONS OF TIE-INS SHALL BE DETERMINED AT THE TIME OF CONSTRUCTION TO SUIT FIELD CONDITIONS. VERIFY LOCATIONS OF ALL EXISTING UTILITIES PRIOR TO BEGINNING ANY WORK.
- 24. ALL LIVE GAS WORK SHALL BE PERFORMED BY OR AT THE DIRECTION AND UNDER THE DIRECT SUPERVISION OF EVERSOURCE GAS PERSONNEL.
- 25. ROADWAY, SIDEWALKS AND GRASS DISTURBED SHALL BE RESTORED TO THE SATISFACTION OF THE CITY OR TOWN. PLANT BEDS TO BE RELOCATED TO EXISTING REGULATOR LOCATION.
- 26. SERVICES TO BE TIED INTO NEW MAIN.
- 27. ENSURE ALL SERVICES HAVE UPGRADED PRESSURE REGULATORS INSTALLED PRIOR TO ACTIVATION.
- 28. VENT STACKS TO BE SIZED PER EVERSOURCE STANDARD OM-225.

STOWELL STREET MAIN RELAY - SCHEDULE OF MATERIALS					
ITEM	QTY	SIZE	MAXIMO NO.	DESCRIPTION	MATERIAL
1	595'	2"		HDPE PIPE, 2", 0.216 IN THK WALL, PE 4710, DR 11	HDPE
2	1	2"		VALVE, BALL, FULL OPENING, PLASTIC	HDPE
3	1	2"		BOX, VALVE, PLASTIC, SNAP-ON, ADJ, W/CI NON-LOCKING LID	HDPE
4	AS REQUIRED	2"		PLASTIC 45 DEG ELBOW, DR 11	HDPE
5	AS REQUIRED	2"		PLASTIC 90 DEG ELBOW. DR 11	HDPE
6	AS REQUIRED	2"		PLASTIC END CAP	HDPE
7	AS REQUIRED	2"		METFIT COUPLING	HDPE
8	1	3" X 2"		3" X 2" MUELLER SERVI-SEAL	
9	4	4" X 2"		4" X 2" MUELLER SERVI-SEAL	
10	3	2" X 1"		EF 2" X 1" TEE	HDPE
11	2	4"		COMPRESSION END CAP	

_	
ISSUED FOR	
CONSTRUCTION	
01/06/20	

EALED BY:	ERIC VINAI KUMAR No. 54771 ROSIONAL ENGINEER
	24
IGNATURE	<i>V</i>

SEALED ON:

01/08/2020 EVERSOURCE ENERGY REVIEWER ENGINEERING LICENSE EXPIRATION: 06/30/2020 EVERSOURCE ENERGY REVIEWER CONSTRUCTION

DESIGNED IN ACCORDANCE WITH TITLE 49-PART 192 OF MINIMUM FEDERAL SAFETY STANDARDS AND GPTC GUIDE FOR GAS TRANSMISSION AND DISTRIBUTION PIPING SYSTEMS. LATEST EDITION. **EN**Engineering 29 BARTLETT STREET MARLBOROUGH, MA 01752 TEL. (630) 353-4000 FAX (630) 535-7777 WWW.ENENGINEERING.COM


FIELD VERIFY DIMENSIONS PRIOR TO PIPE FABRICATION

A ISSUED FOR CONSTRUCTION | 01/06/2020 | MR/AB/EK NO. DESCRIPTION DATE DW/CK/AF **REVISION STATUS EVERS©**URCE

STOWELL STREET MAIN RELAY NEW BEDFORD, MASSACHUSETTS

GENERAL NOTES AND SCHEDULE OF MATERIALS SCALE: NOT TO SCALE SHEET 2 OF 6

DRAWN BY / DATE MR 11/27/2019 CHECKED BY / DATE AB 01/06/2020 SHEET NUMBER MA-20-PIP-NEB-022-02 MA20PIPNEB022R0

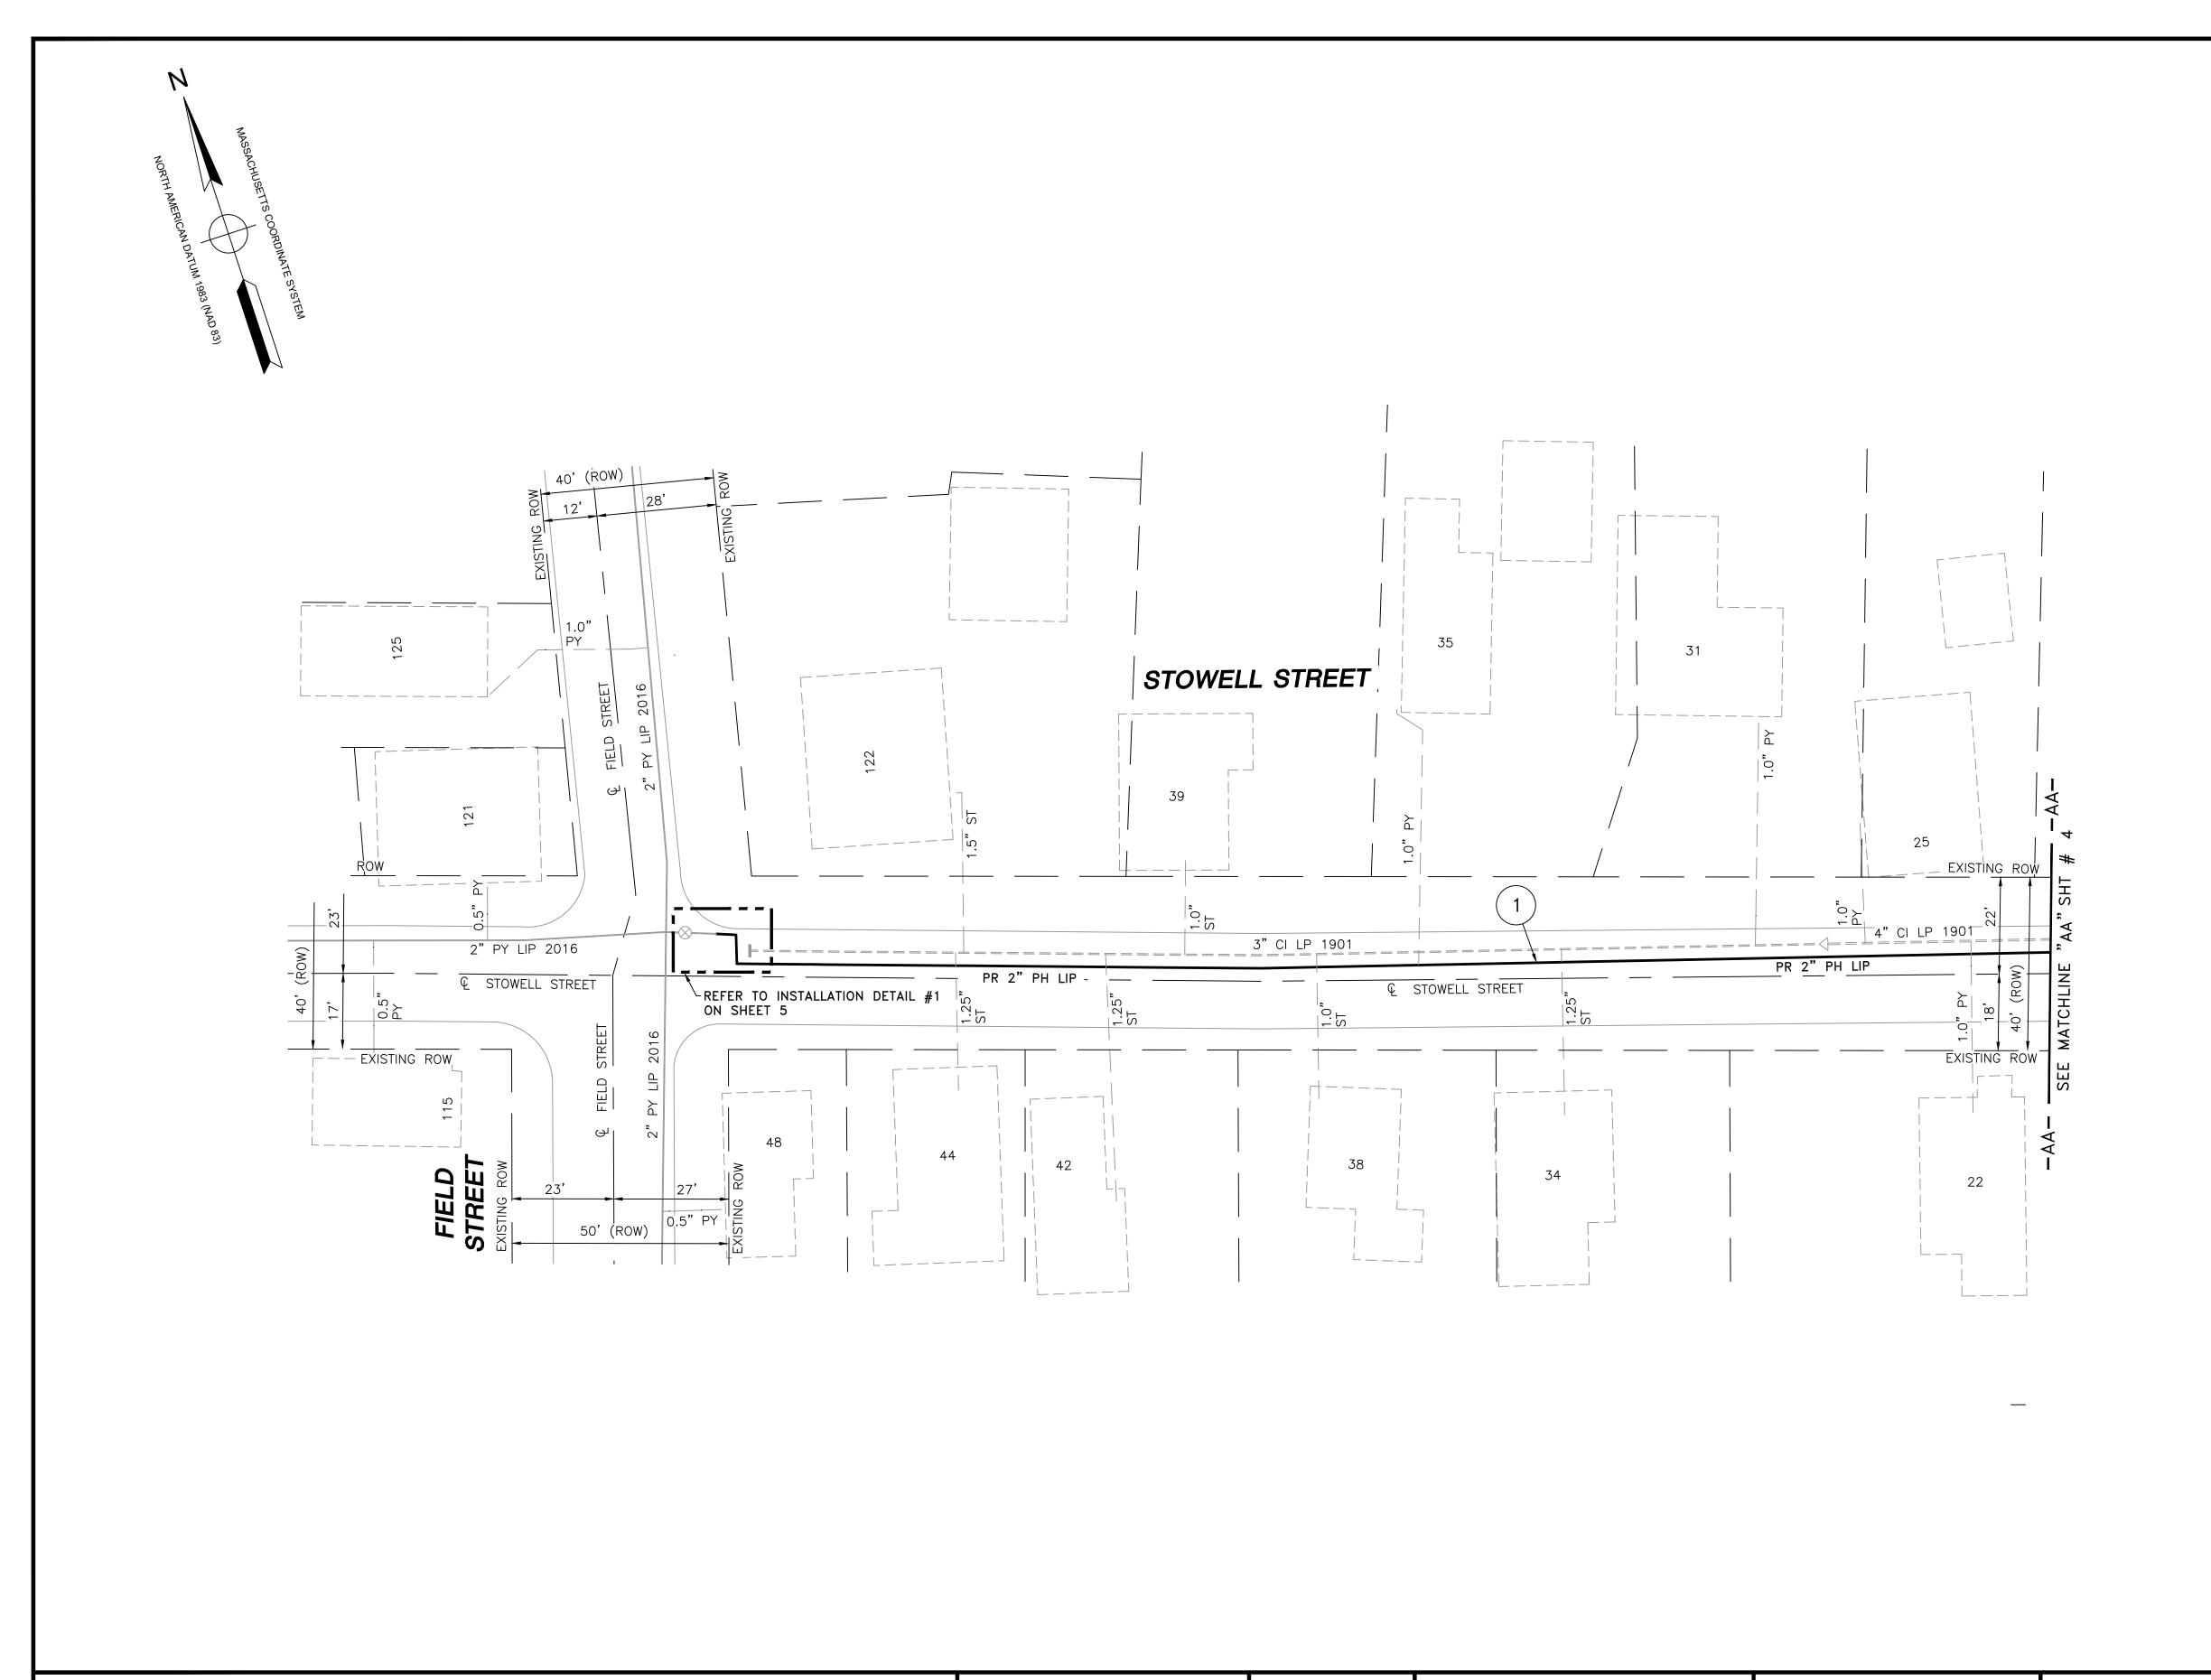

Expo's II Smoke Shop Uncle Ken's Bait and Tackle Jose S Cardoso Insurance

> LOCUS PLAN NOT TO SCALE

DRAWING LEGEND				
\rightarrow	UTILITY POLE		EXISTING GAS MAIN	
*	LIGHT POLE	=======	RETIRED GAS MAIN	
	CATCH BASIN		PROPOSED GAS MAIN	
∞	FIRE HYDRANT		EXISTING SERVICE	
U	UTILITY MANHOLE	_ — — –	RIGHT OF WAY	
E	ELECTRIC MANHOLE	—— Е ——	ELECTRIC	
T	TELEPHONE MANHOLE	— т —	TELEPHONE	
W	WATER MANHOLE	W	WATER	
	SANITARY MANHOLE	<-<<-	SANITARY SEWER	
	STORM MANHOLE	<<-<<	STORM SEWER	
•	EXISTING REDUCER	>	PROPOSED REDUCER	
I	EXISTING CAP	1	PROPOSED CAP	
\otimes	EXISTING VALVE	•	PROPOSED VALVE	
	EXISTING COUPLING	•	PROPOSED COUPLING	

Д	ISSUED FOR CONSTRUCTION	01/06/2020	MR/AB/E		
Ο.	DESCRIPTION	DATE	DW/CK/AF		
	REVISION STATUS				

NOTES:

1. CONTRACTOR TO POTHOLE EXISTING UTILITIES AT CROSSING LOCATIONS PRIOR TO CONSTRUCTION.

2. REFER TO GENERAL NOTES AND SCHEDULE OF MATERIALS ON SHEET #2.

			"
LENGTH	SIZE	MATERIAL	DESCRIPTION
315'	2"	PH	INSTALL
250'	3"	CI	RETIRE
55'	4"	CI	RETIRE

ISSUED FOR CONSTRUCTION 01/06/20


SEALED BY:	ERIC VINAI KUMAR No. 54771	
	1\\ / /F	
	POLESSIONAL ENGINE	
SIGNATURE		


01/08/2020	EVERSOURCE ENERGY REVIEWER ENGINEERING
LICENSE EXPIRATION:	
06/30/2020	EVERSOURCE ENERGY REVIEWER CONSTRUCTION

DESIGNED IN ACCORDANCE WITH TITLE 49-PART 192 OF MINIMUM FEDERAL SAFETY STANDARDS AND GPTC GUIDE FOR GAS TRANSMISSION AND DISTRIBUTION PIPING SYSTEMS. LATEST EDITION.	
ENEngineering 29 BARTLETT STREET	

FIELD VERIFY DIMENSIONS	
PRIOR TO PIPE FABRICATION	
	SCA

REVISION STATUS					
EVERS© URCE					
	E	ENERGY			
STOWELL STREET MAIN RELAY					
	NEW BEDFORD, MASSACHUSETTS				
	INSTALLATION PI	LAN			
CALE:1"=20' SHEET 3 OF 6					
DRAWN BY / DATE	CHECKED BY / DATE	SHEET NUMBER	REV. N		
MR 11/27/2019 APPROVED BY / DATE	AB 01/06/2020 MA20PIPNEB022R0	MA-20-PIP-NEB-022-03	0		

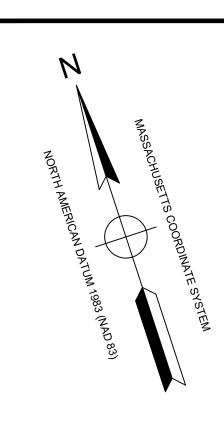

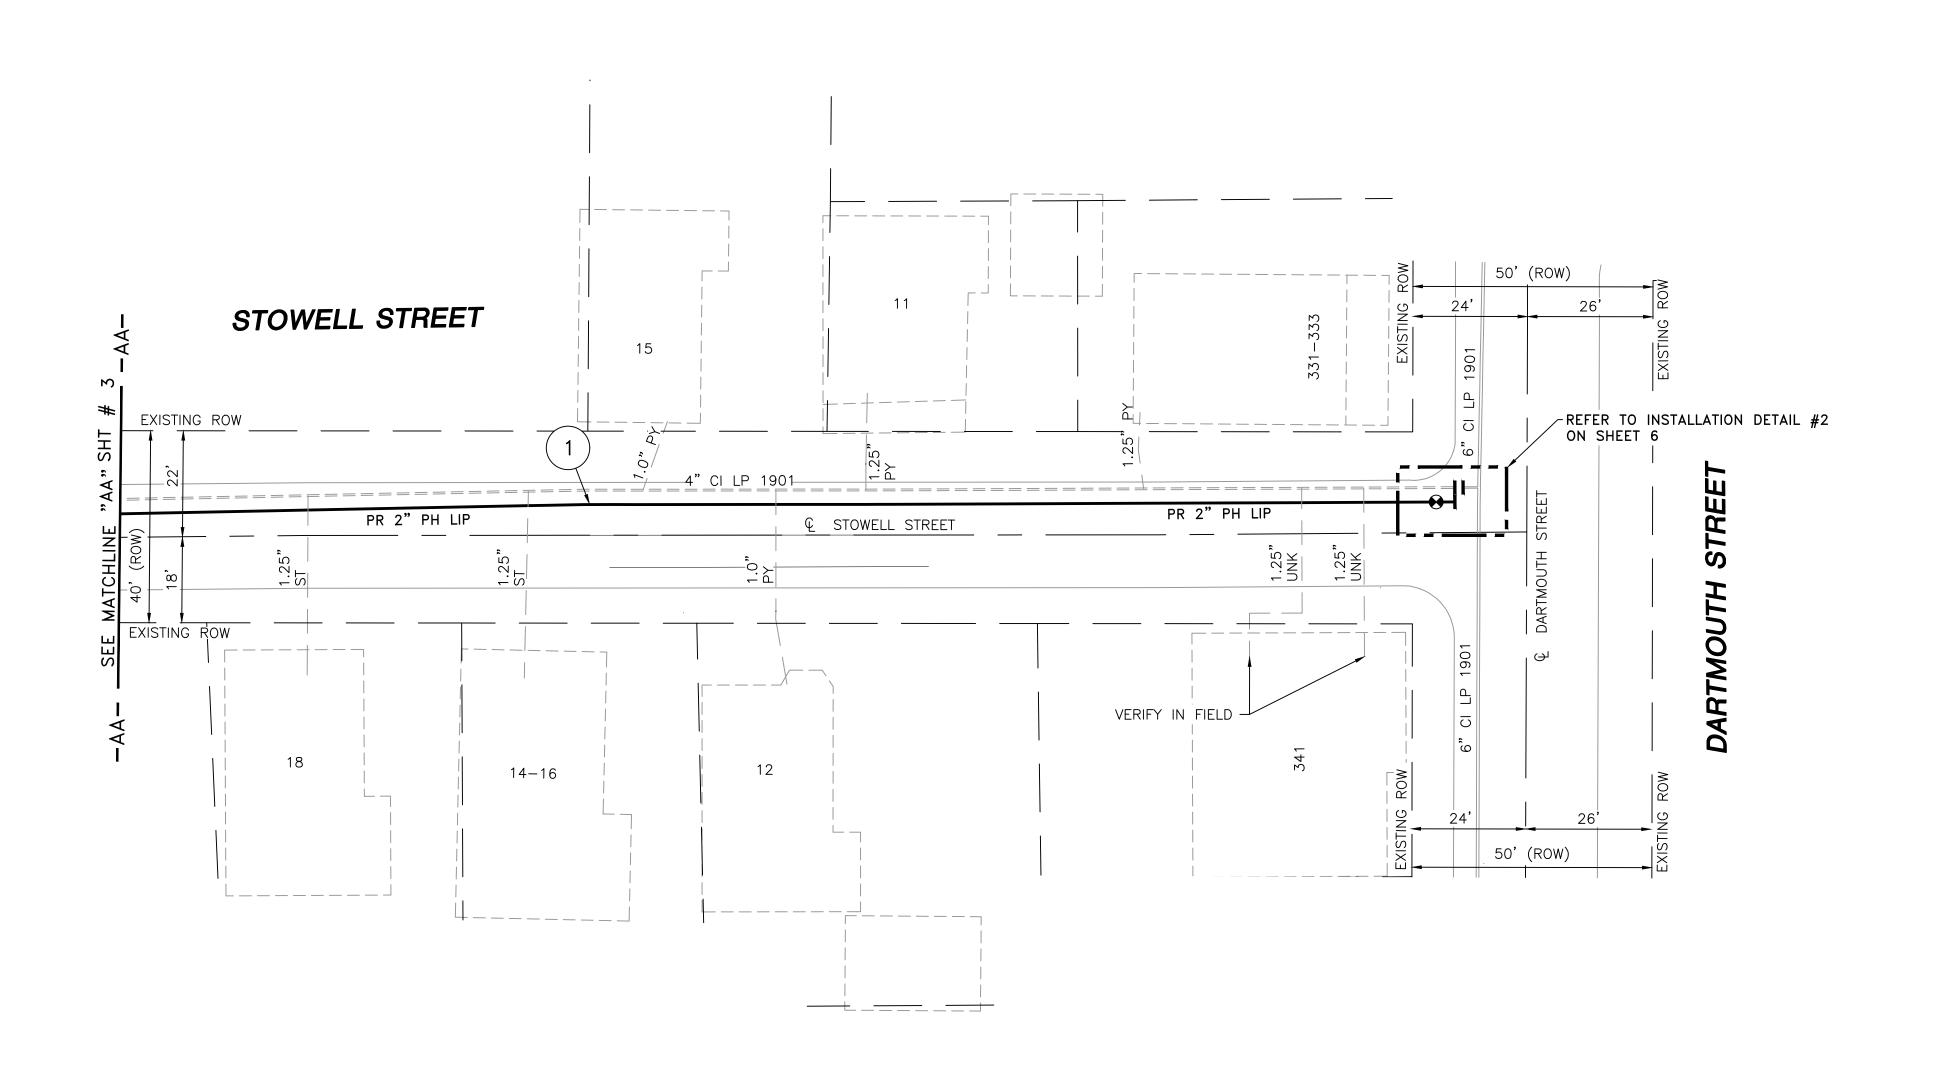

SEALED ON:



LOCUS PLAN NOT TO SCALE

DRAWING LEGEND						
\rightarrow	UTILITY POLE		EXISTING GAS MAIN			
*	LIGHT POLE	=======	RETIRED GAS MAIN			
	CATCH BASIN		PROPOSED GAS MAIN			
∞	FIRE HYDRANT		EXISTING SERVICE			
U	UTILITY MANHOLE	_ — — –	RIGHT OF WAY			
E	ELECTRIC MANHOLE	—— Е ——	ELECTRIC			
T	TELEPHONE MANHOLE	— т —	TELEPHONE			
W	WATER MANHOLE	W	WATER			
	SANITARY MANHOLE	$\!$	SANITARY SEWER			
	STORM MANHOLE	<<-<<-	STORM SEWER			
•	EXISTING REDUCER	>	PROPOSED REDUCER			
	EXISTING CAP	1	PROPOSED CAP			
\otimes	EXISTING VALVE	•	PROPOSED VALVE			
	EXISTING COUPLING		PROPOSED COUPLING			

10.	DESCRIPTION	DATE	DW/CK/AP
Α	ISSUED FOR CONSTRUCTION	01/06/2020	MR/AB/EK

1. CONTRACTOR TO POTHOLE EXISTING UTILITIES AT CROSSING LOCATIONS PRIOR TO CONSTRUCTION.

2. REFER TO GENERAL NOTES AND SCHEDULE OF MATERIALS ON SHEET #2.

LENGTH	SIZE	MATERIAL	DESCRIPTION
280'	2"	PH	INSTALL
280'	4"	CI	RETIRE

ISSUED FOR CONSTRUCTION 01/06/20


SEALED BY:	ERIC VINAI KUMAR No. 54771
	No. 54771 RUMAH No. 54771 ROMAL ENGINEERS
	24
SIGNATURE	6"


01/08/2020	EVERSOURCE ENERGY REVIEWER ENGINEERING
LICENSE EXPIRATION:	
06/30/2020	EVERSOURCE ENERGY REVIEWER CONSTRUCTION

FIELD VERIFY DIMENSIONS PRIOR TO PIPE FABRICATION **EN**Engineering 29 BARTLETT STREET MARLBOROUGH, MA 01752 TEL. (630) 353-4000 FAX (630) 535-7777 WWW.ENENGINEERING.COM

REVISION STATUS **EVERS\$\rightarrow\$URCE** STOWELL STREET MAIN RELAY NEW BEDFORD, MASSACHUSETTS INSTALLATION PLAN SCALE:1"=20' SHEET NUMBER

SHEET 4 OF 6 DRAWN BY / DATE MR 11/27/2019 APPROVED BY / DATE MA-20-PIP-NEB-022-04 MA20PIPNEB022R0

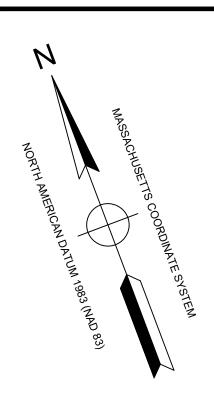

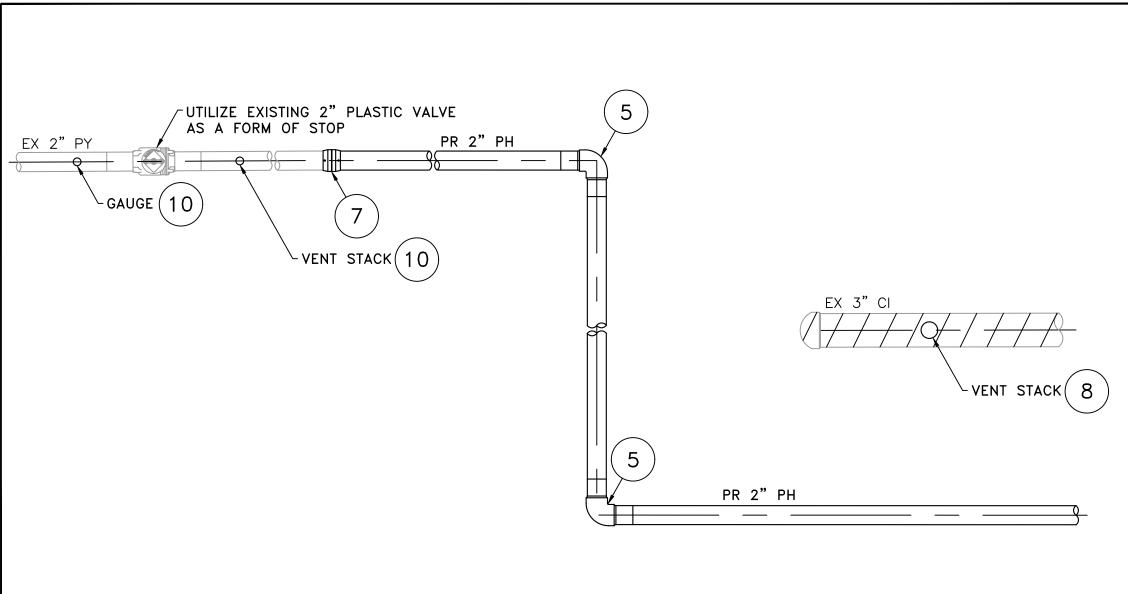

(SCALE: 1"=1')

(REFER TO SHEET #3)

INSTALLATI	ON DETAIL #1	

	STOWELL STREET MAIN RELAY - INSTALLATION DETAIL #1 - SCHEDULE OF MATERIALS				
ITEM	QTY	SIZE	MAXIMO NO.	MAXIMO NO. DESCRIPTION	
4	AS REQUIRED	2"		PLASTIC 45 DEG ELBOW, DR 11	HDPE
5	AS REQUIRED	2"		PLASTIC 90 DEG ELBOW. DR 11 HDPE	
7	AS REQUIRED	2"		METFIT COUPLING HDP	
8	1	3" X 2"	3" X 2" MUELLER SERVI-SEAL		
10	2	2" X 1"		EF 2" X 1" TEE	HDPE

STANDARD DRAWING NOTES:

- 1. IF ANY OF THE FOLLOWING OCCUR A DRAWING REVISION IS REQUIRED AND MUST BE APPROVED AND/OR STAMPED BY THE ENGINEER OF RECORD. CHANGES CAN BE APPROVED AND/OR STAMPED BY A PROJECT ENGINEER, BUT THE ENGINEER OF RECORD MUST BE INFORMED:
- A. IF THE TIE IN POINT MOVES TO A DIFFERENT SEGMENT OF PIPE THAN
- B. IF A CHANGE IN THE LOCATION OF VALVES IS REQUIRED
- C. IF THERE IS ANY CHANGE TO WHAT IS SHOWN ON THE DRAWING WITHIN 50 FEET OF A PRESSURE REGULATING STATION, DISTRICT REGULATOR, OR GATE STATION
- 2. IF A CHANGE IN PIPE SIZE, MATERIAL, FITTINGS, OR WALL THICKNESS IS
- 3. MINOR CHANGES SUCH AS OFFSETS MAY NOT REQUIRE DRAWING CHANGES.
- 4. EXCAVATOR SHALL CALL DIGSAFE / CALL BEFORE YOU DIG (DIAL 811) AT LEAST 72 HOURS PRIOR TO CONSTRUCTION. SATURDAYS, SUNDAYS, AND HOLIDAYS ARE EXCLUDED FROM THE 72-HOUR TIME SPAN, NOT CONSIDERED BUSINESS WORKDAYS.
- 5. CONSTRUCTION DRAWINGS ARE BASED ON HISTORICAL DOCUMENTATION AND HAVE NOT BEEN FIELD VERIFIED. WHEN THE PIPE IS EXPOSED AND VARIANCES TO THE CERTIFIED DRAWINGS ARE FOUND, CONTACT GAS ENGINEERING TO DETERMINE PATH FORWARD.
- 6. ALL WORK SHALL BE PERFORMED PER EVERSOURCE, LOCAL, STATE, OSHA, AND FEDERAL REGULATIONS AND STANDARDS.
- 7. MATERIAL AND CONSTRUCTION SHALL CONFORM TO EVERSOURCE GAS STANDARDS.
- 8. THE LOCATIONS OF EXISTING UTILITIES AND UNDERGROUND STRUCTURES ARE APPROXIMATE AND MUST BE FIELD VERIFIED. ADDITIONAL UNDERGROUND FACILITIES MAY EXIST THAT ARE NOT SHOWN ON THESE DRAWINGS WHICH MAY REQUIRE ADDITIONAL OFFSETS IN THE PIPELINE.
- 9. LOCATIONS SHOWN ON THE DRAWINGS ARE APPROXIMATE. EXACT LOCATIONS OF INS SHALL BE DETERMINED AT THE TIME OF CONSTRUCTION TO SUIT FIELD CONDITIONS ON THE SPECIFIC TIE-IN POINT. VERIFY LOCATIONS OF ALL EXISTING UTILITIES PRIOR TO BEGINNING ANY TIE IN WORK.
- 10. ALL LIVE GAS WORK INCLUDING BUT NOT LIMITED TO TAPPING OF FITTINGS ON LIVE MAINS, STOPPING, MANIPULATING VALVE, ABANDONMENT, SHALL BE PERFORMED BY, OR AT THE DIRECTION AND UNDER THE DIRECT SUPERVISION OF EVERSOURCE GAS PERSONNEL AND IN ACCORDANCE WITH THE WRITTEN PROCEDURE. DRAWING CHANGES MAY ALSO REQUIRE A CHANGE TO THE PROCEDURE.
- 11. EXCAVATOR IS REQUIRED TO PROTECT EXISTING UTILITIES, STRUCTURES, LANDSCAPES FEATURES, SIGNAGE, CURBS, ETC. CARE SHOULD BE TAKEN NOT TO DISTURB OR DAMAGE SUCH ITEMS. ROADWAY, SIDEWALKS, AND GRASS DISTURBED SHALL BE RESTORED TO THE SATISFACTION OF THE CITY OR TOWN. PLANT BEDS WILL BE RELOCATED TO THEIR EXISTING REGULAR LOCATION.
- 12. IF THE PROJECT IS WITHIN 50 FEET OF A DISTRICT REGULATOR OR GATE STATION, ENSURE THAT A QUALIFIED I&R TECHNICIAN IS ON SITE.
- 13. ALL TRAFFIC CONTROL SHALL CONFORM TO THE LATEST EDITION OF THE MANUAL OF UNIFORM TRAFFIC CONTROL DEVICES (MUTCD), INCLUDING ALL REVISIONS AND ADDENDA. ALL TRAFFIC CONTROL DEVICES WILL BE SUPPLIED BY EXCAVATOR.
- 14. PROPERTY LINES AND STRUCTURES DEPICTED ON PLANS ARE BASED ON GIS INFORMATION AND HAVE NOT BEEN VERIFIED BY LAND SURVEY UNLESS NOTED.
- 15. ANY ADDITIONAL NOTES MUST BE REVIEWED AND APPROVED BY GAS ENGINEERING.

	Α	ISSUED FOR CONSTRUCTION	01/06/2020	MR/AB/EK
ı	NO.	DESCRIPTION	DATE	DW/CK/AP
		REVISION STATUS		

EVERS©URCE

STOWELL STREET MAIN RELAY

NEW BEDFORD, MASSACHUSETTS INSTALLATION DETAIL #1 AND SCHEDULE OF MATERIALS

SCALE: 1"=1' SHEET 5 OF 6 SHEET NUMBER CHECKED BY / DATE AB 01/06/2020 MA-20-PIP-NEB-022-05 MA20PIPNEB022R0

	3//
ISSUED FOR	WO CO
CONSTRUCTION	444
01/06/20	

SEALED BY:

SIGNATURE

ERIC VINAI

KUMAR No. 54771

SEALED ON: LICENSE EXPIRATION:


01/08/2020 EVERSOURCE ENERGY REVIEWER ENGINEERING 06/30/2020 EVERSOURCE ENERGY REVIEWER CONSTRUCTION


ENEngineering 29 BARTLETT STREET MARLBOROUGH, MA 01752 TEL. (630) 353-4000 FAX (630) 535-7777 WWW.ENENGINEERING.COM

FIELD VERIFY DIMENSIONS

PRIOR TO PIPE FABRICATION

1. REFER TO GENERAL NOTES ON SHEET #2.

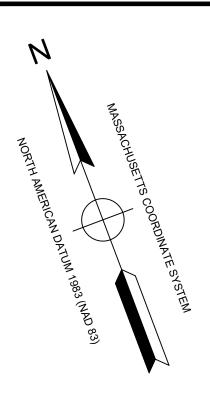

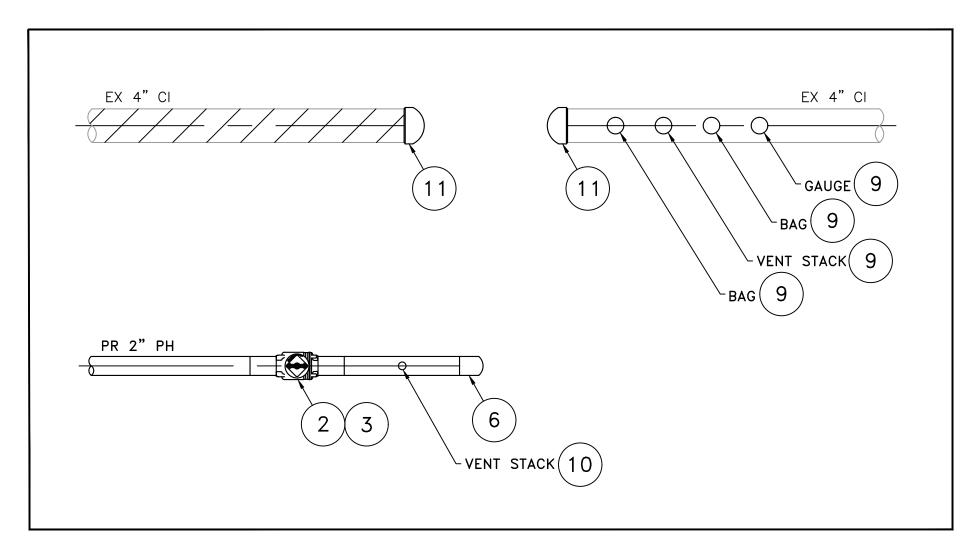

INSTALLATION DETAIL #	2
(SCALE: 1"=1")	
(REFER TO SHEET #4)	

	STOWELL STREET MAIN RELAY - INSTALLATION DETAIL #2 - SCHEDULE OF MATERIALS					
ITEM	QTY	SIZE	MAXIMO NO.	DESCRIPTION	MATERIAL	
2	1	2"		VALVE, BALL, FULL OPENING, PLASTIC	HDPE	
3	1	2"		BOX, VALVE, PLASTIC, SNAP-ON, ADJ, W/CI NON-LOCKING LID	HDPE	
4	AS REQUIRED	2"		PLASTIC 45 DEG ELBOW, DR 11	HDPE	
5	AS REQUIRED	2"		PLASTIC 90 DEG ELBOW. DR 11	HDPE	
6	AS REQUIRED	2"		PLASTIC END CAP	HDPE	
7	AS REQUIRED	2"		METFIT COUPLING	HDPE	
9	4	4" X 2"		4" X 2" MUELLER SERVI-SEAL		
10	1	2" X 1"		EF 2" X 1" TEE	HDPE	
11	2	4"		COMPRESSION END CAP		

STANDARD DRAWING NOTES:

- 1. IF ANY OF THE FOLLOWING OCCUR A DRAWING REVISION IS REQUIRED AND MUST BE APPROVED AND/OR STAMPED BY THE ENGINEER OF RECORD. CHANGES CAN BE APPROVED AND/OR STAMPED BY A PROJECT ENGINEER, BUT THE ENGINEER OF RECORD MUST BE INFORMED:
 - A. IF THE TIE IN POINT MOVES TO A DIFFERENT SEGMENT OF PIPE THAN
 - B. IF A CHANGE IN THE LOCATION OF VALVES IS REQUIRED
 - C. IF THERE IS ANY CHANGE TO WHAT IS SHOWN ON THE DRAWING WITHIN 50 FEET OF A PRESSURE REGULATING STATION, DISTRICT REGULATOR, OR GATE STATION
- 2. IF A CHANGE IN PIPE SIZE, MATERIAL, FITTINGS, OR WALL THICKNESS IS
- 3. MINOR CHANGES SUCH AS OFFSETS MAY NOT REQUIRE DRAWING CHANGES.
- 4. EXCAVATOR SHALL CALL DIGSAFE / CALL BEFORE YOU DIG (DIAL 811) AT LEAST 72 HOURS PRIOR TO CONSTRUCTION. SATURDAYS, SUNDAYS, AND HOLIDAYS ARE EXCLUDED FROM THE 72-HOUR TIME SPAN, NOT CONSIDERED BUSINESS WORKDAYS.
- 5. CONSTRUCTION DRAWINGS ARE BASED ON HISTORICAL DOCUMENTATION AND HAVE NOT BEEN FIELD VERIFIED. WHEN THE PIPE IS EXPOSED AND VARIANCES TO THE CERTIFIED DRAWINGS ARE FOUND, CONTACT GAS ENGINEERING TO DETERMINE PATH FORWARD.
- 6. ALL WORK SHALL BE PERFORMED PER EVERSOURCE, LOCAL, STATE, OSHA, AND FEDERAL REGULATIONS AND STANDARDS.
- 7. MATERIAL AND CONSTRUCTION SHALL CONFORM TO EVERSOURCE GAS STANDARDS.
- 8. THE LOCATIONS OF EXISTING UTILITIES AND UNDERGROUND STRUCTURES ARE APPROXIMATE AND MUST BE FIELD VERIFIED. ADDITIONAL UNDERGROUND FACILITIES MAY EXIST THAT ARE NOT SHOWN ON THESE DRAWINGS WHICH MAY REQUIRE ADDITIONAL OFFSETS IN THE PIPELINE.
- 9. LOCATIONS SHOWN ON THE DRAWINGS ARE APPROXIMATE. EXACT LOCATIONS OF INS SHALL BE DETERMINED AT THE TIME OF CONSTRUCTION TO SUIT FIELD CONDITIONS ON THE SPECIFIC TIE-IN POINT. VERIFY LOCATIONS OF ALL EXISTING UTILITIES PRIOR TO BEGINNING ANY TIE IN WORK.
- 10. ALL LIVE GAS WORK INCLUDING BUT NOT LIMITED TO TAPPING OF FITTINGS ON LIVE MAINS, STOPPING, MANIPULATING VALVE, ABANDONMENT, SHALL BE PERFORMED BY, OR AT THE DIRECTION AND UNDER THE DIRECT SUPERVISION OF EVERSOURCE GAS PERSONNEL AND IN ACCORDANCE WITH THE WRITTEN PROCEDURE. DRAWING CHANGES MAY ALSO REQUIRE A CHANGE TO THE PROCEDURE.
- 11. EXCAVATOR IS REQUIRED TO PROTECT EXISTING UTILITIES, STRUCTURES, LANDSCAPES FEATURES, SIGNAGE, CURBS, ETC. CARE SHOULD BE TAKEN NOT TO DISTURB OR DAMAGE SUCH ITEMS. ROADWAY, SIDEWALKS, AND GRASS DISTURBED SHALL BE RESTORED TO THE SATISFACTION OF THE CITY OR TOWN. PLANT BEDS WILL BE RELOCATED TO THEIR EXISTING REGULAR LOCATION.
- 12. IF THE PROJECT IS WITHIN 50 FEET OF A DISTRICT REGULATOR OR GATE STATION, ENSURE THAT A QUALIFIED I&R TECHNICIAN IS ON SITE.
- 13. ALL TRAFFIC CONTROL SHALL CONFORM TO THE LATEST EDITION OF THE MANUAL OF UNIFORM TRAFFIC CONTROL DEVICES (MUTCD), INCLUDING ALL REVISIONS AND ADDENDA. ALL TRAFFIC CONTROL DEVICES WILL BE SUPPLIED BY EXCAVATOR.
- 14. PROPERTY LINES AND STRUCTURES DEPICTED ON PLANS ARE BASED ON GIS INFORMATION AND HAVE NOT BEEN VERIFIED BY LAND SURVEY UNLESS NOTED.
- 15. ANY ADDITIONAL NOTES MUST BE REVIEWED AND APPROVED BY GAS ENGINEERING.

A ISSUED FOR CONSTRUCTION 01/06/2020 | MR/AB/EK NO. DESCRIPTION DW/CK/AF DATE **REVISION STATUS**

EVERS\$\rightarrow\$URCE

STOWELL STREET MAIN RELAY NEW BEDFORD, MASSACHUSETTS

INSTALLATION DETAIL #2 AND SCHEDULE OF MATERIALS

SCALE: 1"=1' SHEET 6 OF 6 SHEET NUMBER CHECKED BY / DATE AB 01/06/2020 MA-20-PIP-NEB-022-06 MA20PIPNEB022R0

ISSUED FOR
CONSTRUCTION
01/06/20

SEALED BY:	ERIC VINAI KUMAR No. 54771
	PORTERE LEGISTER CONTROL OF THE PROPERTY OF TH
	2-19-
SIGNATURE	V

SEALED ON:

FIELD VERIFY DIMENSIONS PRIOR TO PIPE FABRICATION