



## EVERS URCE ENERGY

ROCKDALE AVENUE MAIN RETIREMENT
RETIREMENT OF 440' OF 4" CI LP GAS MAIN
ROCKDALE AVENUE
NEW BEDFORD, MASSACHUSETTS
ENE PROJECT #: 2005881.130
EVERSOURCE PROJECT #: 6335090



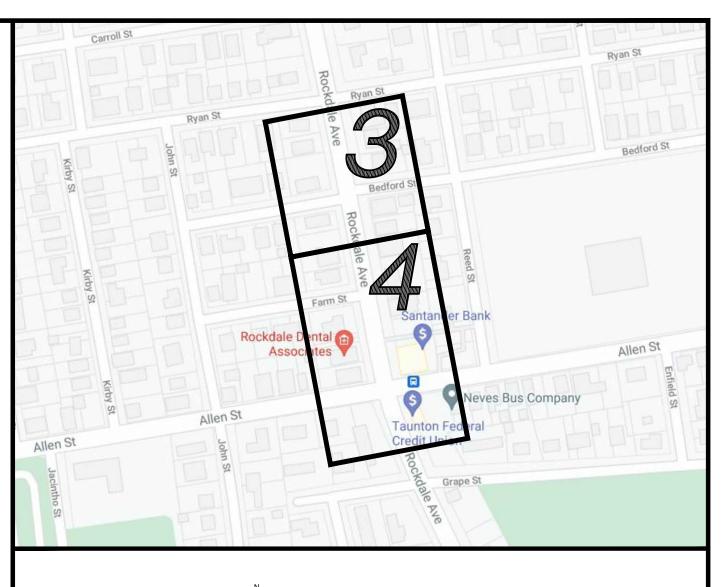

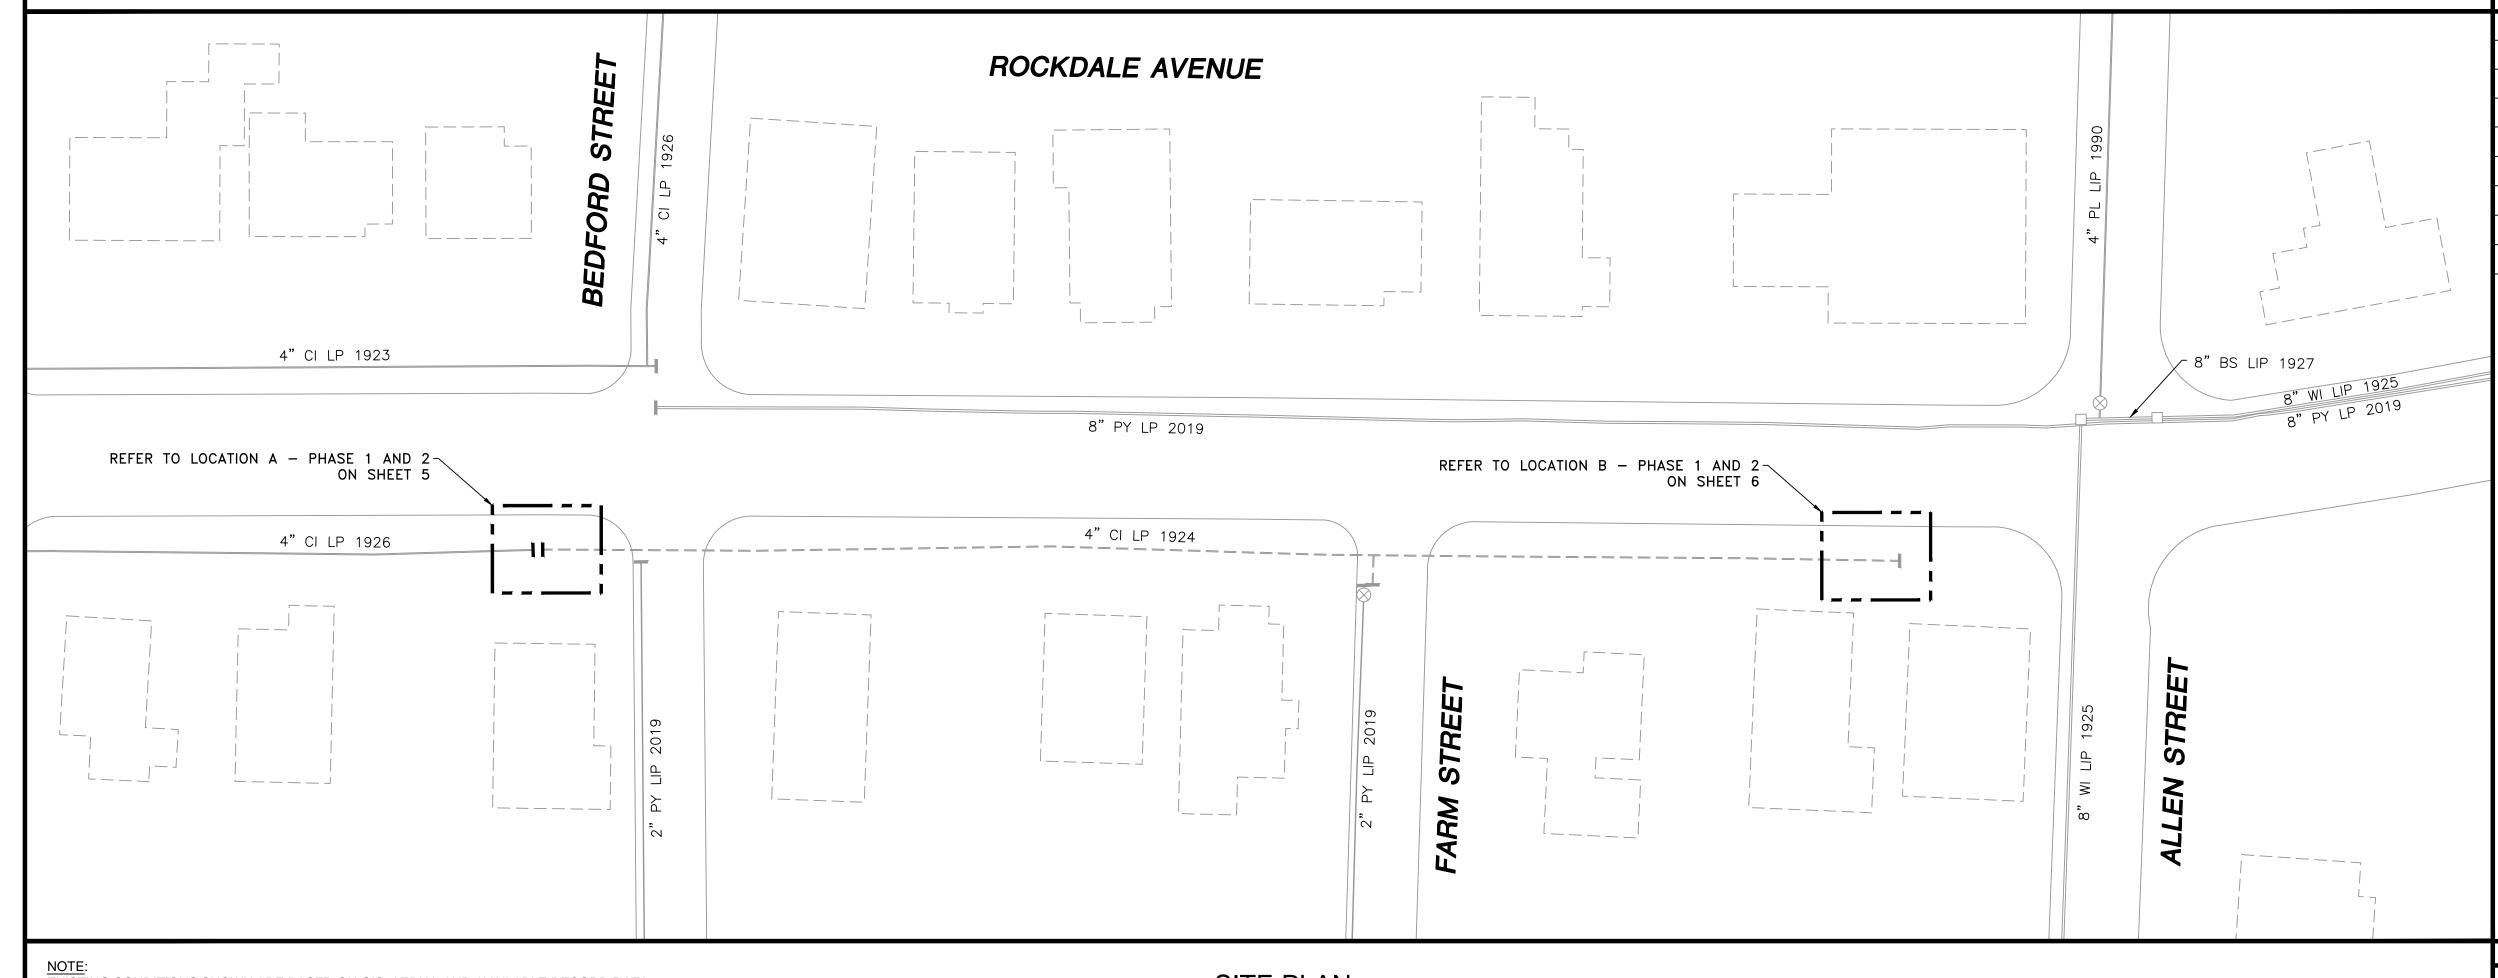

SHEET INDEX			
SHEET NUMBER	DESCRIPTION		
1	SITE PLAN, LOCUS PLAN AND SHEET INDEX		
2	GENERAL NOTES		
3	INSTALLATION PLAN		
4	INSTALLATION PLAN		
5	LOCATION A - PHASE 1, 2 AND SCHEDULE OF MATERIALS		
6	LOCATION B - PHASE 1, 2 AND SCHEDULE OF MATERIALS		
7	STANDARD CORROSION DETAILS		


EXISTING CONDITIONS SHOWN ARE BASED ON GIS, AERIAL AND AVAILABLE RECORD DATA, NO FIELD SURVEY WAS PERFORMED. CONTRACTOR TO VERIFY EXISTING CONDITIONS AS NEEDED IN THE FIELD. PROPOSED MAIN ALIGNMENT AND OFFSETS ARE APPROXIMATE.

#### SITE PLAN

NEW BEDFORD, MASSACHUSETTS (SCALE: 1"=30') (DO NOT SCALE FROM DRAWINGS)

·				
0	ISSUED FOR CONSTRUCTION	08/17/2021	LR/AB/EK	
NO.	DESCRIPTION	DATE	DW/CK/AP	
REVISION STATUS				

ISSUED FOR CONSTRUCTION 08/17/2021

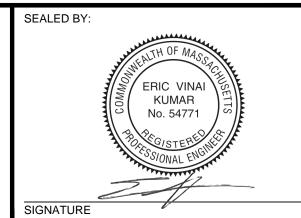

06/30/2022

29 BARTLETT STREET MARLBOROUGH, MA 01752 TEL. (630) 353-4000 FAX (630) 535-7777 WWW.ENENGINEERING.COM FIELD VERIFY DIMENSIONS
PRIOR TO PIPE FABRICATION

EVERSEURCE
ENERGY

ROCKDALE AVENUE MAIN RETIREMENT
NEW BEDFORD, MASSACHUSETTS

#### GENERAL NOTES

- 1. IF ANY OF THE FOLLOWING OCCUR A DRAWING REVISION IS REQUIRED AND MUST BE APPROVED AND/OR STAMPED BY THE ENGINEER OF RECORD. CHANGES CAN BE APPROVED AND/OR STAMPED BY A PROJECT ENGINEER, BUT THE ENGINEER OF RECORD MUST BE INFORMED.
  - A. IF THE TIE IN POINT MOVES TO A DIFFERENT SEGMENT OF PIPE THAN SHOWN
  - B. IF A CHANGE IN THE LOCATION OF VALVES IS REQUIRED
  - IF THERE IS ANY CHANGE TO WHAT IS SHOWN ON THE DRAWING WITHIN 50 FT OF A
  - PRESSURE REGULATING STATION, DISTRICT REGULATOR, OR GATE STATION D. IF A CHANGE IN PIPE SIZE, MATERIAL, FITTINGS, OR WALL THICKNESS IS REQUIRED.
- 2. MINOR CHANGES SUCH AS OFFSETS MAY NOT REQUIRE DRAWING CHANGES.
- 3. EXCAVATOR SHALL CALL DIGSAFE/CALL BEFORE YOU DIG (DIAL 811) AT LEAST 72 HOURS PRIOR TO CONSTRUCTION. SATURDAYS, SUNDAYS, AND HOLIDAYS ARE EXCLUDED FROM THE 72-HOUR TIME SPAN, NOT CONSIDERED BUSINESS WORKDAYS.
- 4. CONSTRUCTION DRAWINGS ARE BASED ON EVERSOURCE HISTORICAL DOCUMENTATION AND HAVE NOT BEEN FIELD VERIFIED. WHEN THE PIPE IS EXPOSED AND VARIANCES TO THE CERTIFIED DRAWINGS ARE FOUND, CONTACT GAS ENGINEERING TO DETERMINE PATH FORWARD.
- 5. ALL WORK SHALL BE PERFORMED PER EVERSOURCE, LOCAL, STATE, OSHA, AND FEDERAL REGULATIONS AND STANDARDS.
- 6. MATERIAL AND CONSTRUCTION SHALL CONFORM TO EVERSOURCE GAS STANDARDS.
- 7. THE LOCATIONS OF EXISTING UTILITIES AND UNDERGROUND STRUCTURES ARE APPROXIMATE AND MUST BE FIELD VERIFIED. ADDITIONAL UNDERGROUND FACILITIES MAY EXIST THAT ARE NOT SHOWN ON THESE DRAWINGS WHICH MAY REQUIRE ADDITIONAL OFFSETS IN THE PIPELINE.
- 8. WORK LOCATIONS SHOWN ON THE DRAWINGS ARE APPROXIMATE. EXACT LOCATIONS OF TIE-INS SHALL BE DETERMINED AT THE TIME OF CONSTRUCTION TO SUIT FIELD CONDITIONS AT THE SPECIFIC TIE-IN POINT. VERIFY LOCATIONS OF ALL EXISTING UTILITIES PRIOR TO BEGINNING ANY TIE-IN WORK.
- 9. ALL LIVE GAS WORK INCLUDING BUT NOT LIMITED TO TAPPING OF FITTINGS ON LIVE MAINS, STOPPING, MANIPULATING VALVE, ABANDONMENT, SHALL BE PERFORMED BY, OR AT THE DIRECTION AND UNDER THE DIRECT SUPERVISION OF EVERSOURCE GAS PERSONNEL AND IN ACCORDANCE WITH THE WRITTEN PROCEDURE. DRAWING CHANGES MAY ALSO REQUIRE A CHANGE TO THE PROCEDURE.
- 10. EXCAVATOR IS REQUIRED TO PROTECT EXISTING UTILITIES, STRUCTURES, LANDSCAPE FEATURES, SIGNAGE, CURBS, ETC. CARE SHOULD BE TAKEN NOT TO DISTURB OR DAMAGE SUCH ROADWAY, SIDEWALKS, AND GRASS DISTURBED SHALL BE RESTORED TO THE SATISFACTION OF THE CITY OR TOWN. PLANT BEDS WILL BE RELOCATED TO THEIR EXISTING REGULAR LOCATION.
- 11. IF THE PROJECT IS WITHIN 50 FEET OF A DISTRICT REGULATOR OR GATE STATION, ENSURE THAT A QUALIFIED I&R TECHNICIAN IS ON SITE.
- 12. ALL TRAFFIC CONTROL SHALL CONFORM TO THE LATEST EDITION OF THE MANUAL OF UNIFORM TRAFFIC CONTROL DEVICES (MUTCD), INCLUDING ALL REVISIONS AND ADDENDA. ALL TRAFFIC CONTROL DEVICES WILL BE SUPPLIED BY EXCAVATOR.
- 13. PROPERTY LINES, STRUCTURES AND EXISTING CONDITIONS DEPICTED ON PLANS ARE BASED ON EVERSOURCE GIS INFORMATION AND HAVE NOT BEEN VERIFIED BY LAND SURVEY UNLESS NOTED.
- 14. EXISTING SERVICES SHOWN ON PLAN ARE FOR INFORMATION ONLY. PROPOSED SERVICES ARE NOT SHOWN ON PLANS AND ARE TO BE INSTALLED PER EVERSOURCE CONSTRUCTION STANDARDS.
- 15. PROPOSED WORK SHALL BE PERFORMED AND COMPLETED IN COMPLIANCE WITH ALL PERMITS AND APPROVALS.
- 16. MAINS AND SERVICES SHALL BE PRESSURE TESTED IN ACCORDANCE WITH EVERSOURCE OM-205.
- 17. MAOP:

LP = 14" W.C.LIP = 35 PSIG IP = 60 PSIG HP = 90 PSIG

- 18. ALL WORK SHALL BE PERFORMED PER EVERSOURCE, LOCAL, STATE AND FEDERAL REGULATIONS AND STANDARDS.
- 19. ALL PIPE WILL BE INSTALLED WITH A MINIMUM DEPTH IN ACCORDANCE WITH EVERSOURCE STANDARDS
- 20. SQUEEZE OPERATIONS SHOULD BE COMPLETED IN ACCORDANCE WITH OM-233
- 21. ENSURE ALL SERVICES BEING TRANSFERRED TO A HIGHER PRESSURE SYSTEM HAVE UPGRADED PRESSURE REGULATORS INSTALLED PRIOR TO ACTIVATION.
- 22. ENSURE VALVES ON EXISTING MAIN, WHERE PROPOSED MAIN WILL BE INSERTED HAVE BEEN MADE INOPERABLE.
- 23. ADDITIONAL VALVES AND TEES THAT ARE INCLUDED IN THE SCHEDULE OF MATERIALS MAY BE INSTALLED TEMPORARILY WHEN NEEDED TO FACILITATE TIE-INS AND PURGES.
- 24. METFIT FITTINGS MAY BE SUBSTITUTED FOR ELECTROFUSION FITTINGS WHERE NEEDED.
- 25. HIGH VOLUME TAPPING TEES ARE NOT TO BE PRE-TAPPED UNLESS OTHERWISE NOTED.
- 26. DO NOT SCALE FROM DRAWINGS.

ISSUED FOR	
CONSTRUCTION	
08/17/2021	

SEALED BY: KUMAR No. 54771 SIGNATURE

SEALED ON: 08/22/2021 LICENSE EXPIRATION: **EN**Engineering 29 BARTLETT STREET MARLBOROUGH, MA 01752 TEL. (630) 353-4000 FAX (630) 535-7777 WWW.ENENGINEERING.COM

06/30/2022


FIELD VERIFY DIMENSIONS PRIOR TO PIPE FABRICATION


EK 08/17/2021

0 ISSUED FOR CONSTRUCTION 08/17/2021 LR/AB/EK NO. DESCRIPTION DATE DW/CK/AF **REVISION STATUS EVERS©URCE** 

ROCKDALE AVENUE MAIN RETIREMENT NEW BEDFORD, MASSACHUSETTS

GENERAL NOTES **SCALE: NOT TO SCALE** SHEET 2 OF 7 CHECKED BY / DATE AB 08/17/2021 SHEET NUMBER DRAWN BY / DATE MA-NEB-21-PIP-086-02 MANEB21PIP086R0

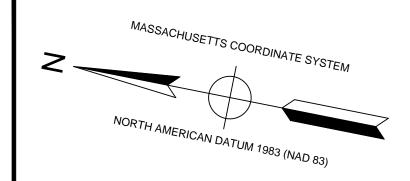

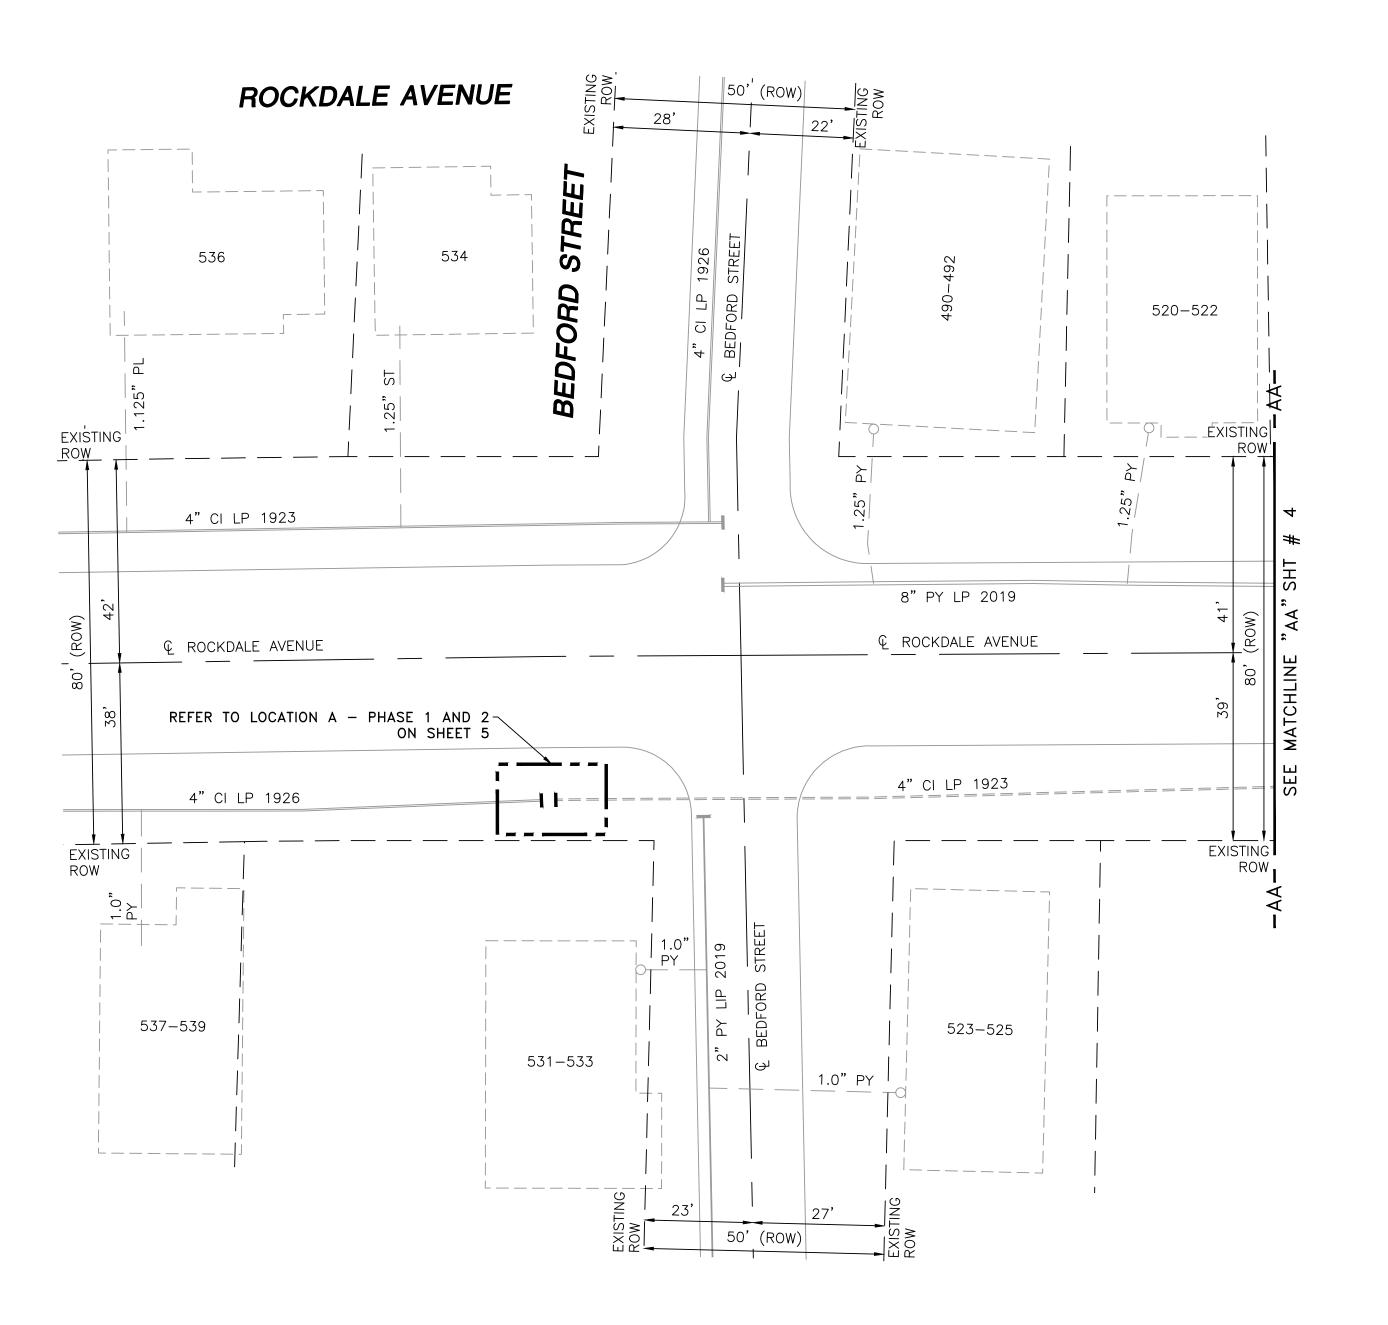

# Carroll St Bedford St

LOCUS PLAN NOT TO SCALE

DRAWING LEGEND						
$\rightarrow$	UTILITY POLE		EXISTING GAS MAIN			
*	LIGHT POLE	=======	RETIRED GAS MAIN			
	CATCH BASIN		PROPOSED GAS MAIN			
000	FIRE HYDRANT		EXISTING SERVICE			
U	UTILITY MANHOLE	_ — — –	RIGHT OF WAY			
E	ELECTRIC MANHOLE	—— Е ——	ELECTRIC			
T	TELEPHONE MANHOLE	— т —	TELEPHONE			
W	WATER MANHOLE	W	WATER			
	SANITARY MANHOLE	$\!$	SANITARY SEWER			
	STORM MANHOLE	<(<(<(<(	STORM SEWER			
$\triangleright$	EXISTING REDUCER	•	PROPOSED REDUCER			
1	EXISTING CAP	l	PROPOSED CAP			
$\otimes$	EXISTING VALVE	$\Theta$	PROPOSED VALVE			
	EXISTING COUPLING	\$	PROPOSED ANODE			


- NOTES:

  1. REFER TO GENERAL NOTES ON SHEET #2. CONTRACTOR TO POTHOLE EXISTING UTILITIES AT CROSSING
- LOCATIONS PRIOR TO CONSTRUCTION.

  HDPE, 4710, SDR 11 ELBOWS TO BE INSTALLED AS REQUIRED TO FACILITATE OFFSETS BASED ON FIELD CONDITIONS.

SIZE MATERIAL DESCRIPTION LENGTH RETIRE

ISSUED FOR CONSTRUCTION 08/17/2021

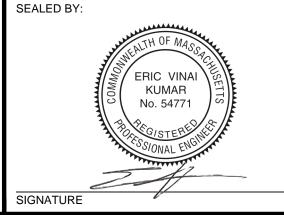

SEALED ON:	
	DESIGNED IN ACCORDANCE WITH TITLE 49-PART 192 OF MINIMUM FEDERAL SAFETY
	STANDARDS AND GPTC GUIDE FOR GAS TRANSMISSION AND DISTRIBUTION PIPING SYSTEMS, LATEST EDITION.
08/22/2021	STSTEMS. LATEST EDITION.
LICENSE EXPIRATION:	<b>EN</b> ©naineerina
	<b>EN</b> Engineering
	29 BARTLETT STREET MARLBOROUGH, MA 01752
	29 BARTLETT STREET

FIELD VERIFY DIMENSIONS PRIOR TO PIPE FABRICATION

### **EVERS\$\rightarrow\$URCE**

0 ISSUED FOR CONSTRUCTION

NO. DESCRIPTION

ROCKDALE AVENUE MAIN RETIREMENT NEW BEDFORD, MASSACHUSETTS INSTALLATION PLAN

**REVISION STATUS** 

08/17/2021 LR/AB/EK

DATE DW/CK/AP

SCALE:1"=20' (DO N	OT SCALE FROM DRAWII	NGS) SHEET 3	OF 7
DRAWN BY / DATE	CHECKED BY / DATE	SHEET NUMBER	REV. NO.
LR 08/06/2021	AB 08/17/2021		
APPROVED BY / DATE	MANER21PIP086R0	MA-NEB-21-PIP-086-03	0

