

SHEET INDEX

SITE PLAN, DRAWING LEGEND AND SHEET INDEX

GENERAL NOTES AND SCHEDULE OF MATERIALS

DESCRIPTION

INSTALLATION PLAN

INSTALLATION PLAN

INSTALLATION PLAN

INSTALLATION PLAN

INSTALLATION DETAIL #1


INSTALLATION DETAIL #2

INSTALLATION DETAIL #3

INSTALLATION DETAIL #4

SHEET NUMBER

BOURNE STREET AND SPOONER STREET MAIN RELAY NEW BEDFORD, MASSACHUSETTS ENE PROJECT #: 2000000.23 **EVERSOURCE PROJECT #: 1301031**

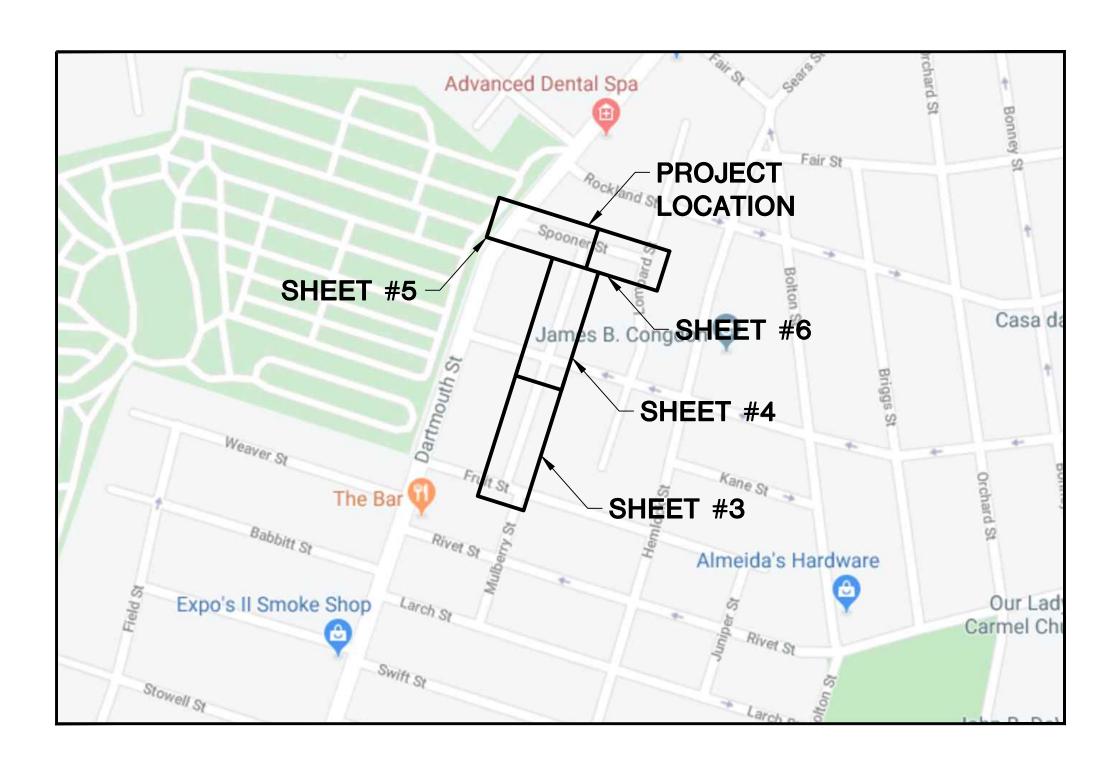

EVERSEURCE

ENERGY

SITE PLAN NEW BEDFORD, MASSACHUSETTS

(NOT TO SCALE)

SCOPE OF WORK

RELAY 860' OF 4" CI LP WITH 880' OF 4" PH LP ON SPOONER STREET FROM DARMOUTH STREET TO LOMBARD STREET AND ON BOURNE STREET FROM SPOONER STREET TO FRUIT STREET DUE TO DETERIORATING CONDITIONS.

ISSUED FOR CONSTRUCTION 02/06/20



02/10/2020 LICENSE EXPIRATION: **ENE**ngineering 29 BARTLETT STREET MARLBOROUGH, MA 01752 TEL. (630) 353-4000 FAX (630) 535-7777 WWW.ENENGINEERING.COM

06/30/2020

FIELD VERIFY DIMENSIONS PRIOR TO PIPE FABRICATION


Almeida's Hardw **LOCUS PLAN** NOT TO SCALE DRAWING LEGEND **UTILITY POLE EXISTING GAS MAIN** LIGHT POLE RETIRED GAS MAIN **CATCH BASIN** PROPOSED GAS MAIN FIRE HYDRANT **EXISTING SERVICE UTILITY MANHOLE** RIGHT OF WAY **ELECTRIC MANHOLI** ELECTRIC **TELEPHONE** TELEPHONE MANHOLE STORM MANHOLE STORM SEWER PROPOSED REDUCER **EXISTING REDUCER** PROPOSED CAP **EXISTING CAP EXISTING VALVE** PROPOSED VALVE PROPOSED COUPLING **EXISTING COUPLING** 0 ISSUED FOR CONSTRUCTION 02/06/2020 RT/AB NO. DESCRIPTION DATE DW/CK/AF **REVISION STATUS EVERSURCE** BOURNE STREET AND SPOONER STREET MAIN RELAY NEW BEDFORD, MASSACHUSETTS SITE PLAN, DRAWING LEGEND AND SHEET INDEX SCALE: NOT TO SCALE SHEET 1 OF 10 SHEET NUMBER MA-20-PIP-NEB-022-01 MA20PIPNEB022R0

- 1. MAINS AND SERVICES SHALL BE PRESSURE TESTED IN ACCORDANCE WITH EVERSOURCE OM-205. AT A MINIMUM TEST PRESSURE SHALL BE 90 PSIG FOR 4 HOURS. TEST MEDIUM SHALL BE NITROGEN OR
- 2. MAOP LP = 14" W.C.
- 3. CONTRACTOR TO LOCATE ALL UNDERGROUND FACILITIES PRIOR TO DIGGING.
- 4. BACKFILL WITH SAND WHERE PIPE TRENCH IS UNDER OR WITHIN 2' OF PAVEMENT, CURB, OR SIDEWALK.
- 5. ALL RIGHT-OF-WAY MUST BE STAKED BEFORE GAS MAIN CAN BE INSTALLED, IF INSTALLED IN OFF-STREET ALIGNMENT.
- 6. COORDINATE WITH EVERSOURCE GAS INSPECTOR FOR LOCATION OF UNDERGROUND UTILITIES PRIOR TO STARTING ANY EXCAVATION. EXERCISE CARE WHEN EXCAVATING NEAR EXISTING STRUCTURES.
- UTILITY LOCATIONS SHOWN ON PLANS ARE APPROXIMATE AND MAY NOT BE ALL INCLUSIVE. CONTRACTOR SHALL CALL 811 AND LOCAL GOVERNMENT AGENCIES PRIOR TO CONSTRUCTION FOR ALL UTILITY LOCATIONS.
- 8. ALL WORK SHALL BE PERFORMED PER EVERSOURCE, LOCAL, STATE AND FEDERAL REGULATIONS & STANDARDS.
- 9. CONTACT CITY OF NEW BEDFORD AND DEPARTMENT OF PUBLIC WORKS PRIOR TO COMMENCEMENT OF WORK AND PRIOR TO ANY PROPOSED ROAD CLOSURES.
- 10. CONTACT MASSACHUSETTS DEPARTMENT OF TRANSPORTATION WHEN REQUIRED.
- 11. ALL DISTURBED SOIL AND PAVEMENT SHALL BE RESTORED TO MATCH EXISTING CONDITION.
- 12. CONTACT PROJECT MANAGER PRIOR TO ANY FIELD CHANGES.
- 13. CONTRACTOR SHALL AVOID IMPACTING ANY AND ALL PRIVATE DRAINS AND DRIVEWAY CULVERTS.
- 14. ALL SEWER LATERALS THAT ARE CROSSED SHALL BE DOCUMENTED PRIOR TO AND AFTER CONSTRUCTION TO ENSURE NO DAMAGE WAS MADE TO EXISTING PIPES & STRUCTURES.
- 15. EXISTING GAS SERVICE LOCATIONS ARE APPROXIMATE & SHALL BE VERIFIED IN FIELD.
- 16. ALL PIPE TO BE INSTALLED WITH A MINIMUM DEPTH IN ACCORDANCE WITH EVERSOURCE STANDARDS.
- 17. ALL PROPOSED PIPE WILL BE INSTALLED VIA OPEN CUT/DIRECT BURY UNLESS OTHERWISE SPECIFIED.
- 18. THIS DOCUMENT REQUIRES A REVISION IF ANY OF THE FOLLOWING ARE REQUIRED;
 - 1) IF THE TIE IN POINT MOVES TO A DIFFERENT LOCATION THAN SHOWN.
 - 2) IF A CHANGE TO THE GAS FLOW PATH INCLUDING BUT NOT LIMITED TO THE LOCATION OR ORIENTATION OF TEES, BRANCHES, AND HOT TAP FITTING OR A CHANGE IN THE LOCATION OF VALES
 - 3) IF THE WORK IS WITHIN 50 FT OF A PRESSURE REGULATING STATION, DISTRICT REGULATOR OR GATE STATION AND ADDITIONAL OFFSETS ARE REQUIRED THAN WHAT IS SHOWN.
 - 4) A CHANGE IN PIPE SIZE, MATERIAL, OR WALL THICKNESS IS REQUIRED.
- 19. EXISTING CONDITIONS INCLUDING LOCATION, SIZE, MATERIAL, INTERNAL PRESSURE, RATINGS OF GAS FACILITIES ARE BASED OFF HISTORICAL DOCUMENTATION AND HAS NOT BEEN FIELD VERIFIED. WHEN THE PIPE IS EXPOSED THIS DRAWING OR PROCEDURE REQUIRES A REVISION IF GAS FACILITIES ARE FOUND TO MEET ANY OF THE FOLLOWING;
 - 1) PIPE IS OF A DIFFERENT MATERIAL, SIZE, WALL THICKNESS OR PRESSURE CLASS THAN SHOWN. 2) INTERNAL PRESSURE IS MEASURED AND IS FOUND NOT TO BE CONSISTENT WITH THE OPERATING
 - 3) IF THE GAS FLOW PATH INCLUDING BUT NOT LIMITED TO THE ORIENTATION OF TEES, BRANCHES,
 - AND HOT TAP FITTING OR THE LOCATION OF VALES IS NOT AS SHOWN.
 - 4) IF THE MAIN IS FOUND TO BE OVER 5'FROM WHERE IS IT IS DIMENSIONED. 5) IF MULTIPLE OR ADDITIONAL MAINS AND SERVICES ARE FOUND THAN WHAT IS SHOWN.
- 20. SQUEEZE LOCATIONS ARE SHOWN DIAGRAMMATICAL. SQUEEZE OPERATIONS SHOULD BE COMPLETED IN ACCORDANCE WITH OM-233.
- 21. MATERIAL AND CONSTRUCTION SHALL CONFORM TO EVERSOURCE GAS STANDARDS.
- 22. THE LOCATIONS OF EXISTING UTILITIES AND UNDERGROUND STRUCTURES ARE APPROXIMATE AND MUST BE FIELD VERIFIED. ADDITIONAL UNDERGROUND FACILITIES MAY EXIST THAT ARE NOT SHOWN ON THESE DRAWINGS WHICH MAY REQUIRE ADDITIONAL OFFSETS IN THE PIPELINE.
- 23. LOCATIONS SHOWN ON THE DRAWING ARE APPROXIMATE. EXACT LOCATIONS OF TIE-INS SHALL BE DETERMINED AT THE TIME OF CONSTRUCTION TO SUIT FIELD CONDITIONS. VERIFY LOCATIONS OF ALL EXISTING UTILITIES PRIOR TO BEGINNING ANY WORK.
- 24. ALL LIVE GAS WORK SHALL BE PERFORMED BY OR AT THE DIRECTION AND UNDER THE DIRECT SUPERVISION OF EVERSOURCE GAS PERSONNEL.
- 25. ROADWAY, SIDEWALKS AND GRASS DISTURBED SHALL BE RESTORED TO THE SATISFACTION OF THE CITY OR TOWN. PLANT BEDS TO BE RELOCATED TO EXISTING REGULATOR LOCATION.
- 26. SERVICES TO BE TIED INTO NEW MAIN.
- 27. ENSURE ALL SERVICES HAVE UPGRADED PRESSURE REGULATORS INSTALLED PRIOR TO ACTIVATION.
- 28. VENT STACKS TO BE SIZED PER EVERSOURCE STANDARD OM-225.

	BOURNE STREET & SPOONER STREET WAITN RELATS - SCHEDULE OF WATERIALS				
ITEM	QTY	SIZE	MAXIMO NO.	DESCRIPTION	MATERIAL
8	6 4" 501	501002	BALL VALVE, BUTT FUSION, IPS, HDPE 3408/4710, SDR 11, ASTM D2513, ASME B16.40. FULL PORT, 1/4 TURN,	ASTM D2513	
		301002	KEROTEST POLYBALL OR APPROVED EQUAL.	A3 LIVI D2312	
35	AS REQUIRED	4"	500855	COUPLING, ELECTROFUSION, IPS, HDPE 3408, ASTM D3350, ASTM F1055, COMPATIBLE FOR FUSION TO HDPE	ASTM D3350
33	AS REQUIRED	4	300833	3408/4710 PIPE. GFCP OR APPROVED EQUAL.	A3 11VI D3330
4.4	AC DECLUDED	411	F 4F2 44	ELBOW, 90 DEG, BUTT FUSION, IPS, HDPE 4710, SDR 11, ASTM D2513, ASTM D3350, ASTM D3261. PERFORMANCE	A CTN 4 D 2 E 4 2
44	AS REQUIRED	4"	545341	PIPE OR APPROVED EQUAL.	ASTM D2513
Ε0	AC DECLUDED	4"	E4E220	ELBOW, 45 DEG, BUTT FUSION, IPS, HDPE 4710, SDR 11, ASTM D2513, ASTM D3350, ASTM D3261. PERFORMANCE	A CTN 4 D2E42
50	AS REQUIRED	4"	545338	PIPE OR APPROVED EQUAL.	ASTM D2513
67	AC DEOLUDED	4"	E42E20	CAP, BUTT FUSION, IPS, HDPE 4710, SDR 11, ASTM D2513, ASTM D3350, ASTM D3261. PERFORMANCE PIPE OR	
67	AS REQUIRED	4	542538	APPROVED EQUAL.	
74	2	411	F.COC70	TEE, STRAIGHT, BUTT FUSION, IPS, HDPE 4710, SDR 11, ASTM D2513, ASTM D3350, ASTM D3261. PERFORMANCE	A CTN 4 D 2 E 4 2
74	3	3 4"	560679	PIPE OR APPROVED EQUAL.	ASTM D2513
100	1	4" X 1"	F.CO.701	TAPPING TEE, ELECTROFUSION, IPS X IPS, HDPE 3408/4710, SDR 11, ASTM D2513, ASTM D3350, ASTM D3261, ASTM	
106	1		4 X 1	560781	F1055. CENTRAL PLASTICS OR APPROVED EQUAL.
100	1	CII V 4II	F.CO70F	TAPPING TEE, ELECTROFUSION, IPS X IPS, HDPE 3408/4710, SDR 11, ASTM D2513, ASTM D3350, ASTM D3261, ASTM	A CTN 4 D 2 E 4 2
108	1 1	1 6" X 1" 560785	560785	F1055. CENTRAL PLASTICS OR APPROVED EQUAL.	ASTM D2513
120	Г	411.1/ 2"	F04204	HV TAPPING TEE, ELECTROFUSION, IPS X IPS, HDPE 3408/4710, SDR 11, ASTM D2513, ASTM D3350, ASTM D3261,	A CTN 4 D2E42
128	5	4" X 2"	584304	ASTM F1055. CENTRAL PLASTICS OR APPROVED EQUAL.	ASTM D2513
124	4	411	F70100	COUPLING, BOLTED MECHANICAL, IPS TO IPS, ASTM A-53 BODY, CONFORMS TO 49 CFR 192.283(b). SMITH-BLAIR	A CTN 4 A . F 2
134	4	4"	578189	MAXI-GRIP EZ OR APPROVED EQUAL.	ASTM A-53
152	4	4"	578128	END CAP, BOLTED MECHANICAL, CIP. SMITH-BLAIR MAXI-GRIP OR APPROVED EQUAL	
				BAND CLAMP, WITH WELDED 2" FNPT SERVICE OUTLET, 304L SS SINGLE SECTION BAND AND GAP BRIDGES, SS STUDS	
170	16	4" x 2"	543028	WITH TEFLON COATED HEX NUTS, COMPLETELY LINED WITH NITRILE RUBBER GASKET. MUELLER 540 SERVI-SEAL OR	
				APPROVED EQUAL. COMPLETE WITH PLUG.	
265	1,135'	4"	554008	PIPE, IPS, HDPE 3408/4710 SDR 11, ASTM D2513, ASTM D3350, PERFORMANCE PIPE OR APPROVED EQUAL	ASTM D2513
8A	6	4"		BOX, VALVE, PLASTIC, SNAP-ON, ADJ, W/CI NON-LOCKING LID	

BOURNE STREET & SPOONER STREET MAIN RELAYS - SCHEDULE OF MATERIALS

ISSUED FOR CONSTRUCTION 02/06/20

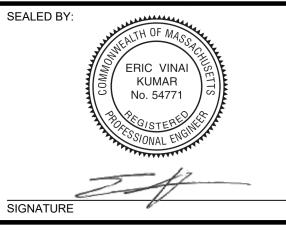

SEALED ON: DESIGNED IN ACCORDANCE WITH TITLE 49-PART 192 OF MINIMUM FEDERAL SAFETY STANDARDS AND GPTC GUIDE FOR GAS TRANSMISSION AND DISTRIBUTION PIPING SYSTEMS. LATEST EDITION. 02/10/2020 LICENSE EXPIRATION: **EN**Engineering

06/30/2020


29 BARTLETT STREET MARLBOROUGH, MA 01752 TEL. (630) 353-4000 FAX (630) 535-7777 WWW.ENENGINEERING.COM


FIELD VERIFY DIMENSIONS PRIOR TO PIPE FABRICATION

0 ISSUED FOR CONSTRUCTION 02/06/2020 RT/AB NO. DESCRIPTION DATE DW/CK/AF **REVISION STATUS EVERS©URCE**

BOURNE STREET AND SPOONER STREET MAIN RELAY NEW BEDFORD, MASSACHUSETTS GENERAL NOTES AND SCHEDULE OF MATERIALS

SCALE: NOT TO SCALE SHEET 2 OF 10 DRAWN BY / DATE DD 12/11/2019 CHECKED BY / DATE AB 02/06/2020 SHEET NUMBER MA-20-PIP-NEB-022-02 MA20PIPNEB022R0

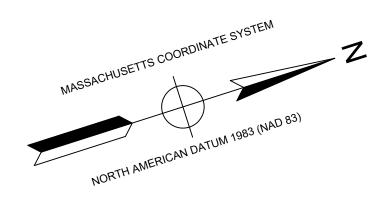

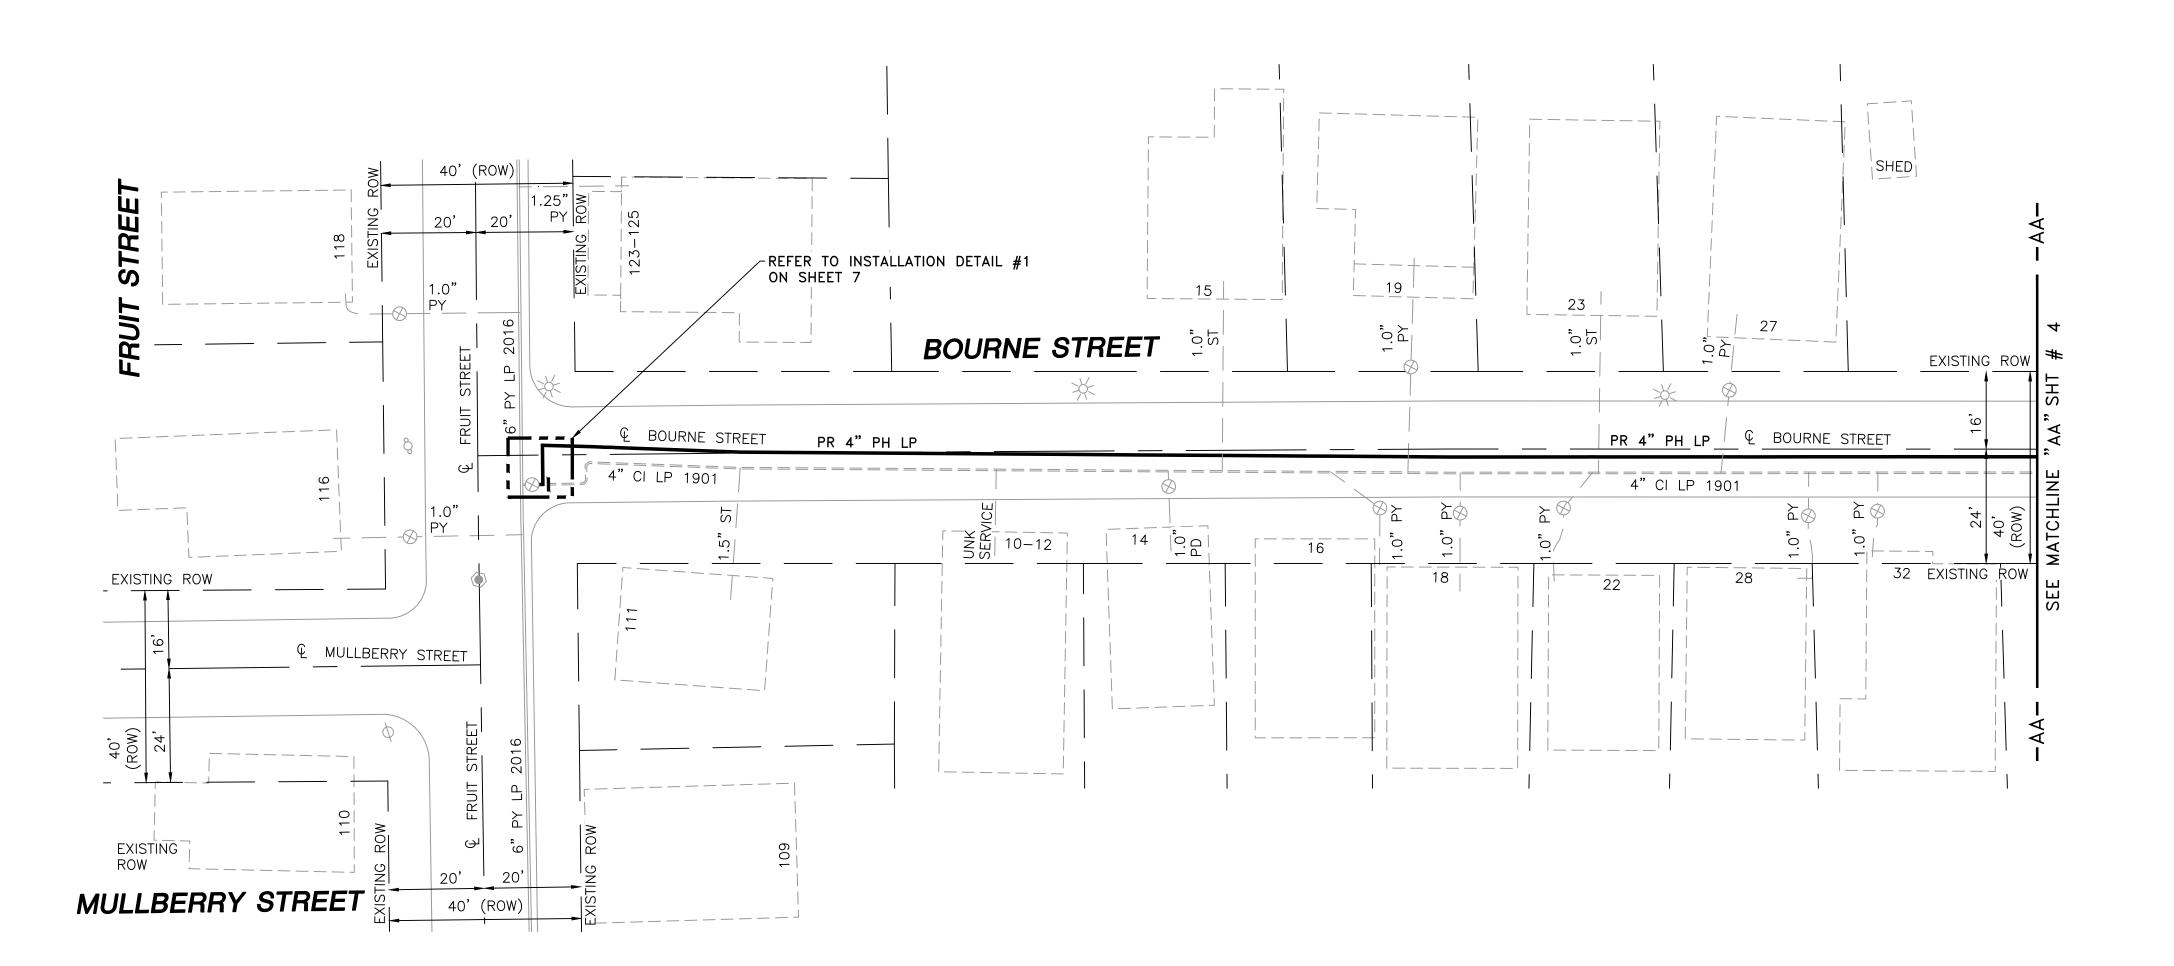

	F	ナ		Rocks	/ /i	Fair St
£			Spoone	Rockland St		
				Pulp		Bolton St
		h St	Jame	es B. Congo	don 💝	
eaver St		Dartmouth St			-	
	The Bar	France		ock St	Kane St	
Babbitt St		Rivet St	AS ALIBORAL SA	Hemlock	Almeida	a's Hardw
	01/5	N. Carlotte			4/	0

LOCUS PLAN NOT TO SCALE

DRAWING LEGEND				
\rightarrow	UTILITY POLE		EXISTING GAS MAIN	
*	LIGHT POLE	=======	RETIRED GAS MAIN	
	CATCH BASIN		PROPOSED GAS MAIN	
000	FIRE HYDRANT		EXISTING SERVICE	
\bigcirc	UTILITY MANHOLE	_ — — –	RIGHT OF WAY	
E	ELECTRIC MANHOLE	—— Е ——	ELECTRIC	
T	TELEPHONE MANHOLE	— т —	TELEPHONE	
W	WATER MANHOLE	W	WATER	
	SANITARY MANHOLE	<-<	SANITARY SEWER	
	STORM MANHOLE	<<-<<-	STORM SEWER	
•	EXISTING REDUCER	>	PROPOSED REDUCER	
1	EXISTING CAP	1	PROPOSED CAP	
\otimes	EXISTING VALVE	•	PROPOSED VALVE	
	EXISTING COUPLING		PROPOSED COUPLING	

0	ISSUED FOR CONSTRUCTION	02/06/2020	RT/AB
NO.	DESCRIPTION	DATE	DW/CK/A
	DEVISION STATUS		

REVISION STATUS

BOURNE STREET AND SPOONER STREET MAIN RELAY NEW BEDFORD, MASSACHUSETTS INSTALLATION PLAN

CALE:1"=20'		SHEET 3 (OF 10
DRAWN BY / DATE	CHECKED BY / DATE	SHEET NUMBER	REV. NO.
DD 12/11/2019	AB 02/06/2020		_
APPROVED BY / DATE	MA20PIPNEB022R0	MA-20-PIP-NEB-022-03	0


NOTES:

1. CONTRACTOR TO POTHOLE EXISTING UTILITIES
AT CROSSING LOCATIONS PRIOR TO CONSTRUCTION.

2. REFER TO GENERAL NOTES AND SCHEDULE OF MATERIALS ON SHEET #2.

LENGTH SIZE MATERIAL DESCRIPTION INSTALL PΗ 320' RETIRE CI 315'


ISSUED FOR CONSTRUCTION 02/06/20

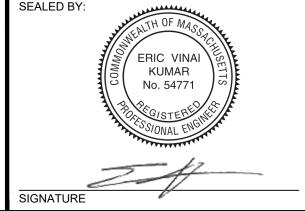


02/10/2020	DESIGNED IN ACCORDANCE WITH TITLE 49-PART 192 OF MINIMUM FEDERAL SAFET STANDARDS AND GPTC GUIDE FOR GAS TRANSMISSION AND DISTRIBUTION PIPIN SYSTEMS. LATEST EDITION.
ENSE PIRATION:	EN Engineering
	29 BARTLETT STREET MARLBOROUGH, MA 01752 TEL. (630) 353-4000

SEALED ON:

FIELD VERIFY DIMENSIONS PRIOR TO PIPE FABRICATION

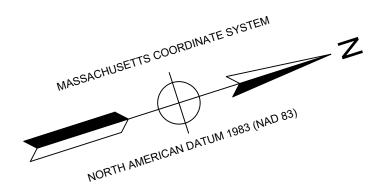

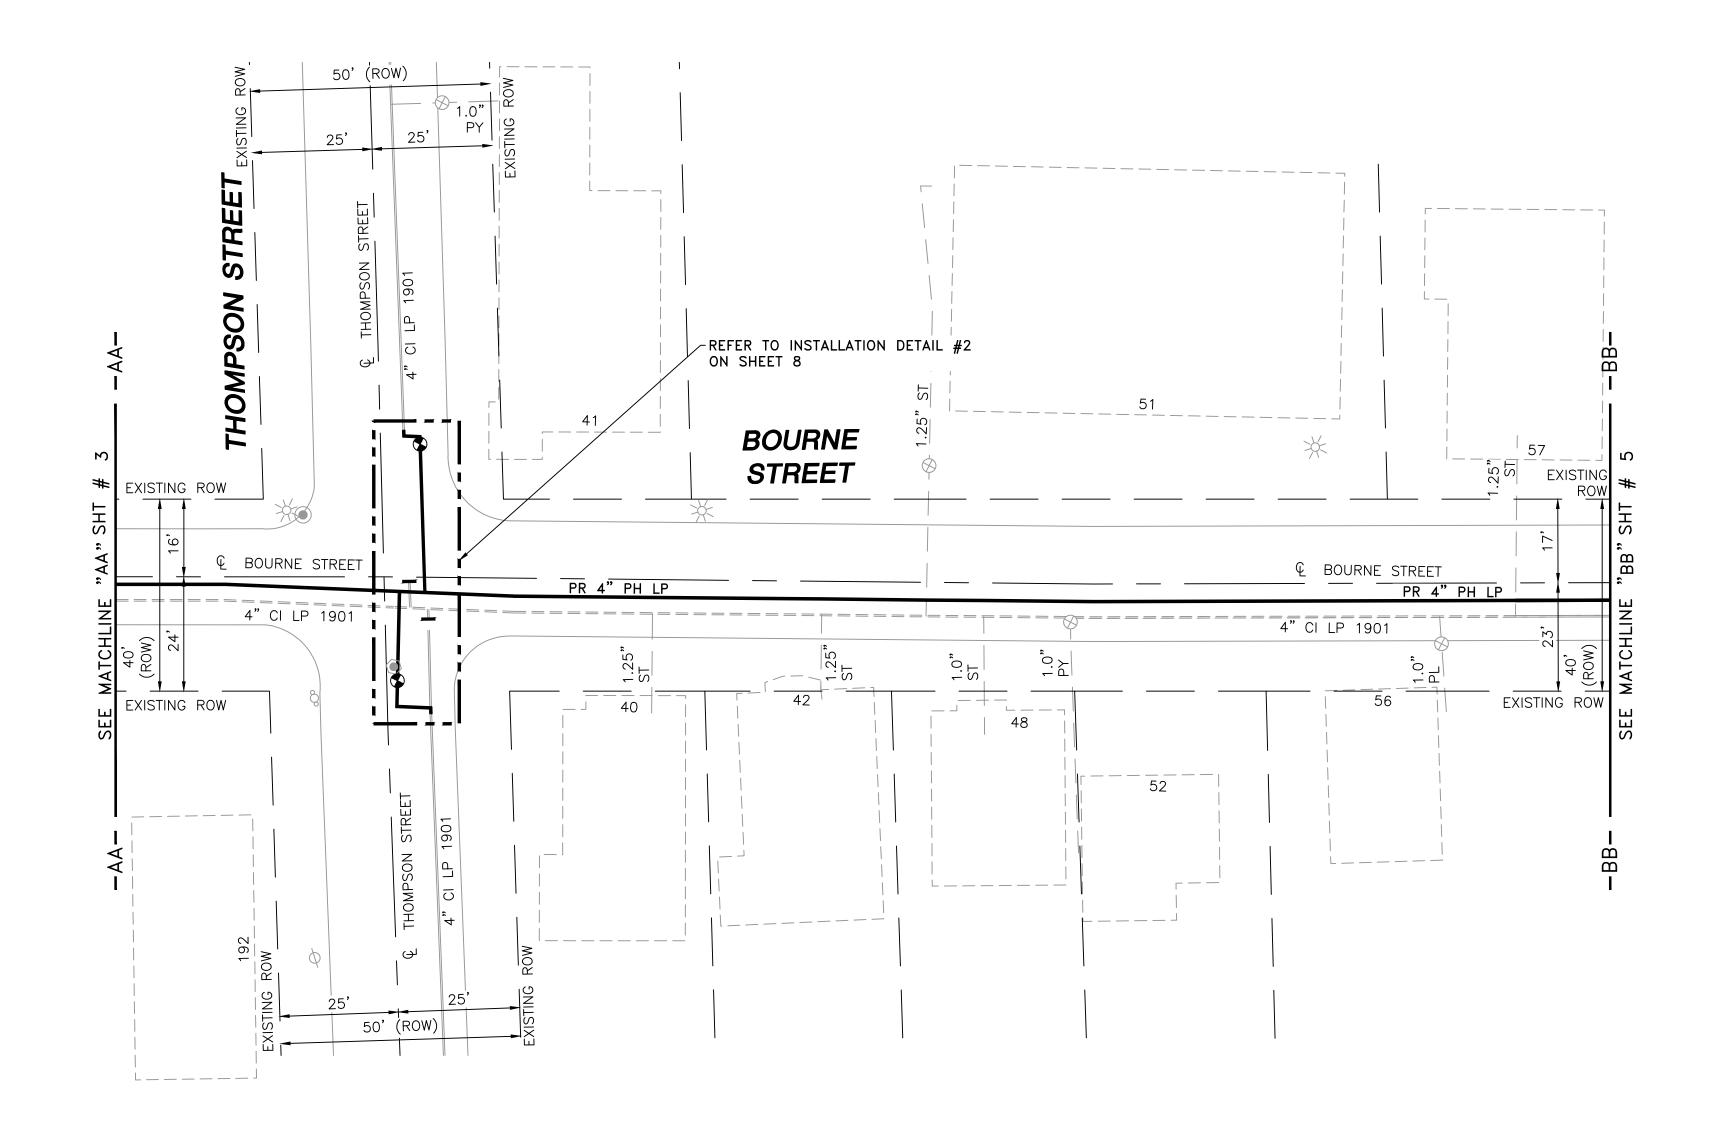

ie e	Babbitt St	The Bar Rivet St Rivet St River St Rive	Spooner St Spanner St Spooner St Spooner St Spanner St Spooner St Spanner St Spooner St Spooner St Spanner St Spooner Spooner St Spooner Sp	Bolton S
		₩	CUS PLAN OT TO SCALE	
		DRAWII	NG LEGEND	
	\rightarrow	UTILITY POLE		EXISTING GAS MAIN
	*	LIGHT POLE	=======	RETIRED GAS MAIN
		CATCH BASIN		PROPOSED GAS MA
	∞	FIRE HYDRANT		EXISTING SERVICE
	\bigcirc	UTILITY MANHOLE		RIGHT OF WAY
	E	ELECTRIC MANHOLE	—— Е ——	ELECTRIC
	T	TELEPHONE MANHOLE	— т —	TELEPHONE
	W	WATER MANHOLE	W	WATER
		SANITARY MANHOLE	<-<-	SANITARY SEWER
		STORM MANHOLE	-<<<<	STORM SEWER
	•	EXISTING REDUCER	>	PROPOSED REDUCI
	I	EXISTING CAP	l	PROPOSED CAP

EXISTING VALVE

EXISTING COUPLING

Almeida's Hardw

PROPOSED VALVE

PROPOSED COUPLING

PROPOSED REDUCER

PROPOSED GAS MAIN

0	ISSUED FOR CONSTRUCTION	02/06/2020	RT/AB
NO.	DESCRIPTION	DATE	DW/CK/AF
	REVISION STATUS		

EVERS©URCE

BOURNE STREET AND SPOONER STREET MAIN RELAY NEW BEDFORD, MASSACHUSETTS INSTALLATION PLAN

SCALE:1"=20' SHEET 4 OF 10 DRAWN BY / DATE DD 12/11/2019 APPROVED BY / DATE CHECKED BY / DATE AB 02/06/2020 SHEET NUMBER MA-20-PIP-NEB-022-04 MA20PIPNEB022R0


NOTES:

1. CONTRACTOR TO POTHOLE EXISTING UTILITIES
AT CROSSING LOCATIONS PRIOR TO CONSTRUCTION.

2. REFER TO GENERAL NOTES AND SCHEDULE OF MATERIALS ON SHEET #2.

LENGTH SIZE MATERIAL DESCRIPTION PH INSTALL 380' CI RETIRE 370'

ISSUED FOR CONSTRUCTION 02/06/20

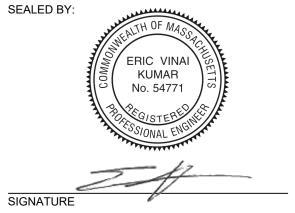


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CENSE (PIRATION:	EN Engineering
	29 BARTLETT STREET

SEALED ON:

06/30/2020

FIELD VERIFY DIMENSIONS PRIOR TO PIPE FABRICATION

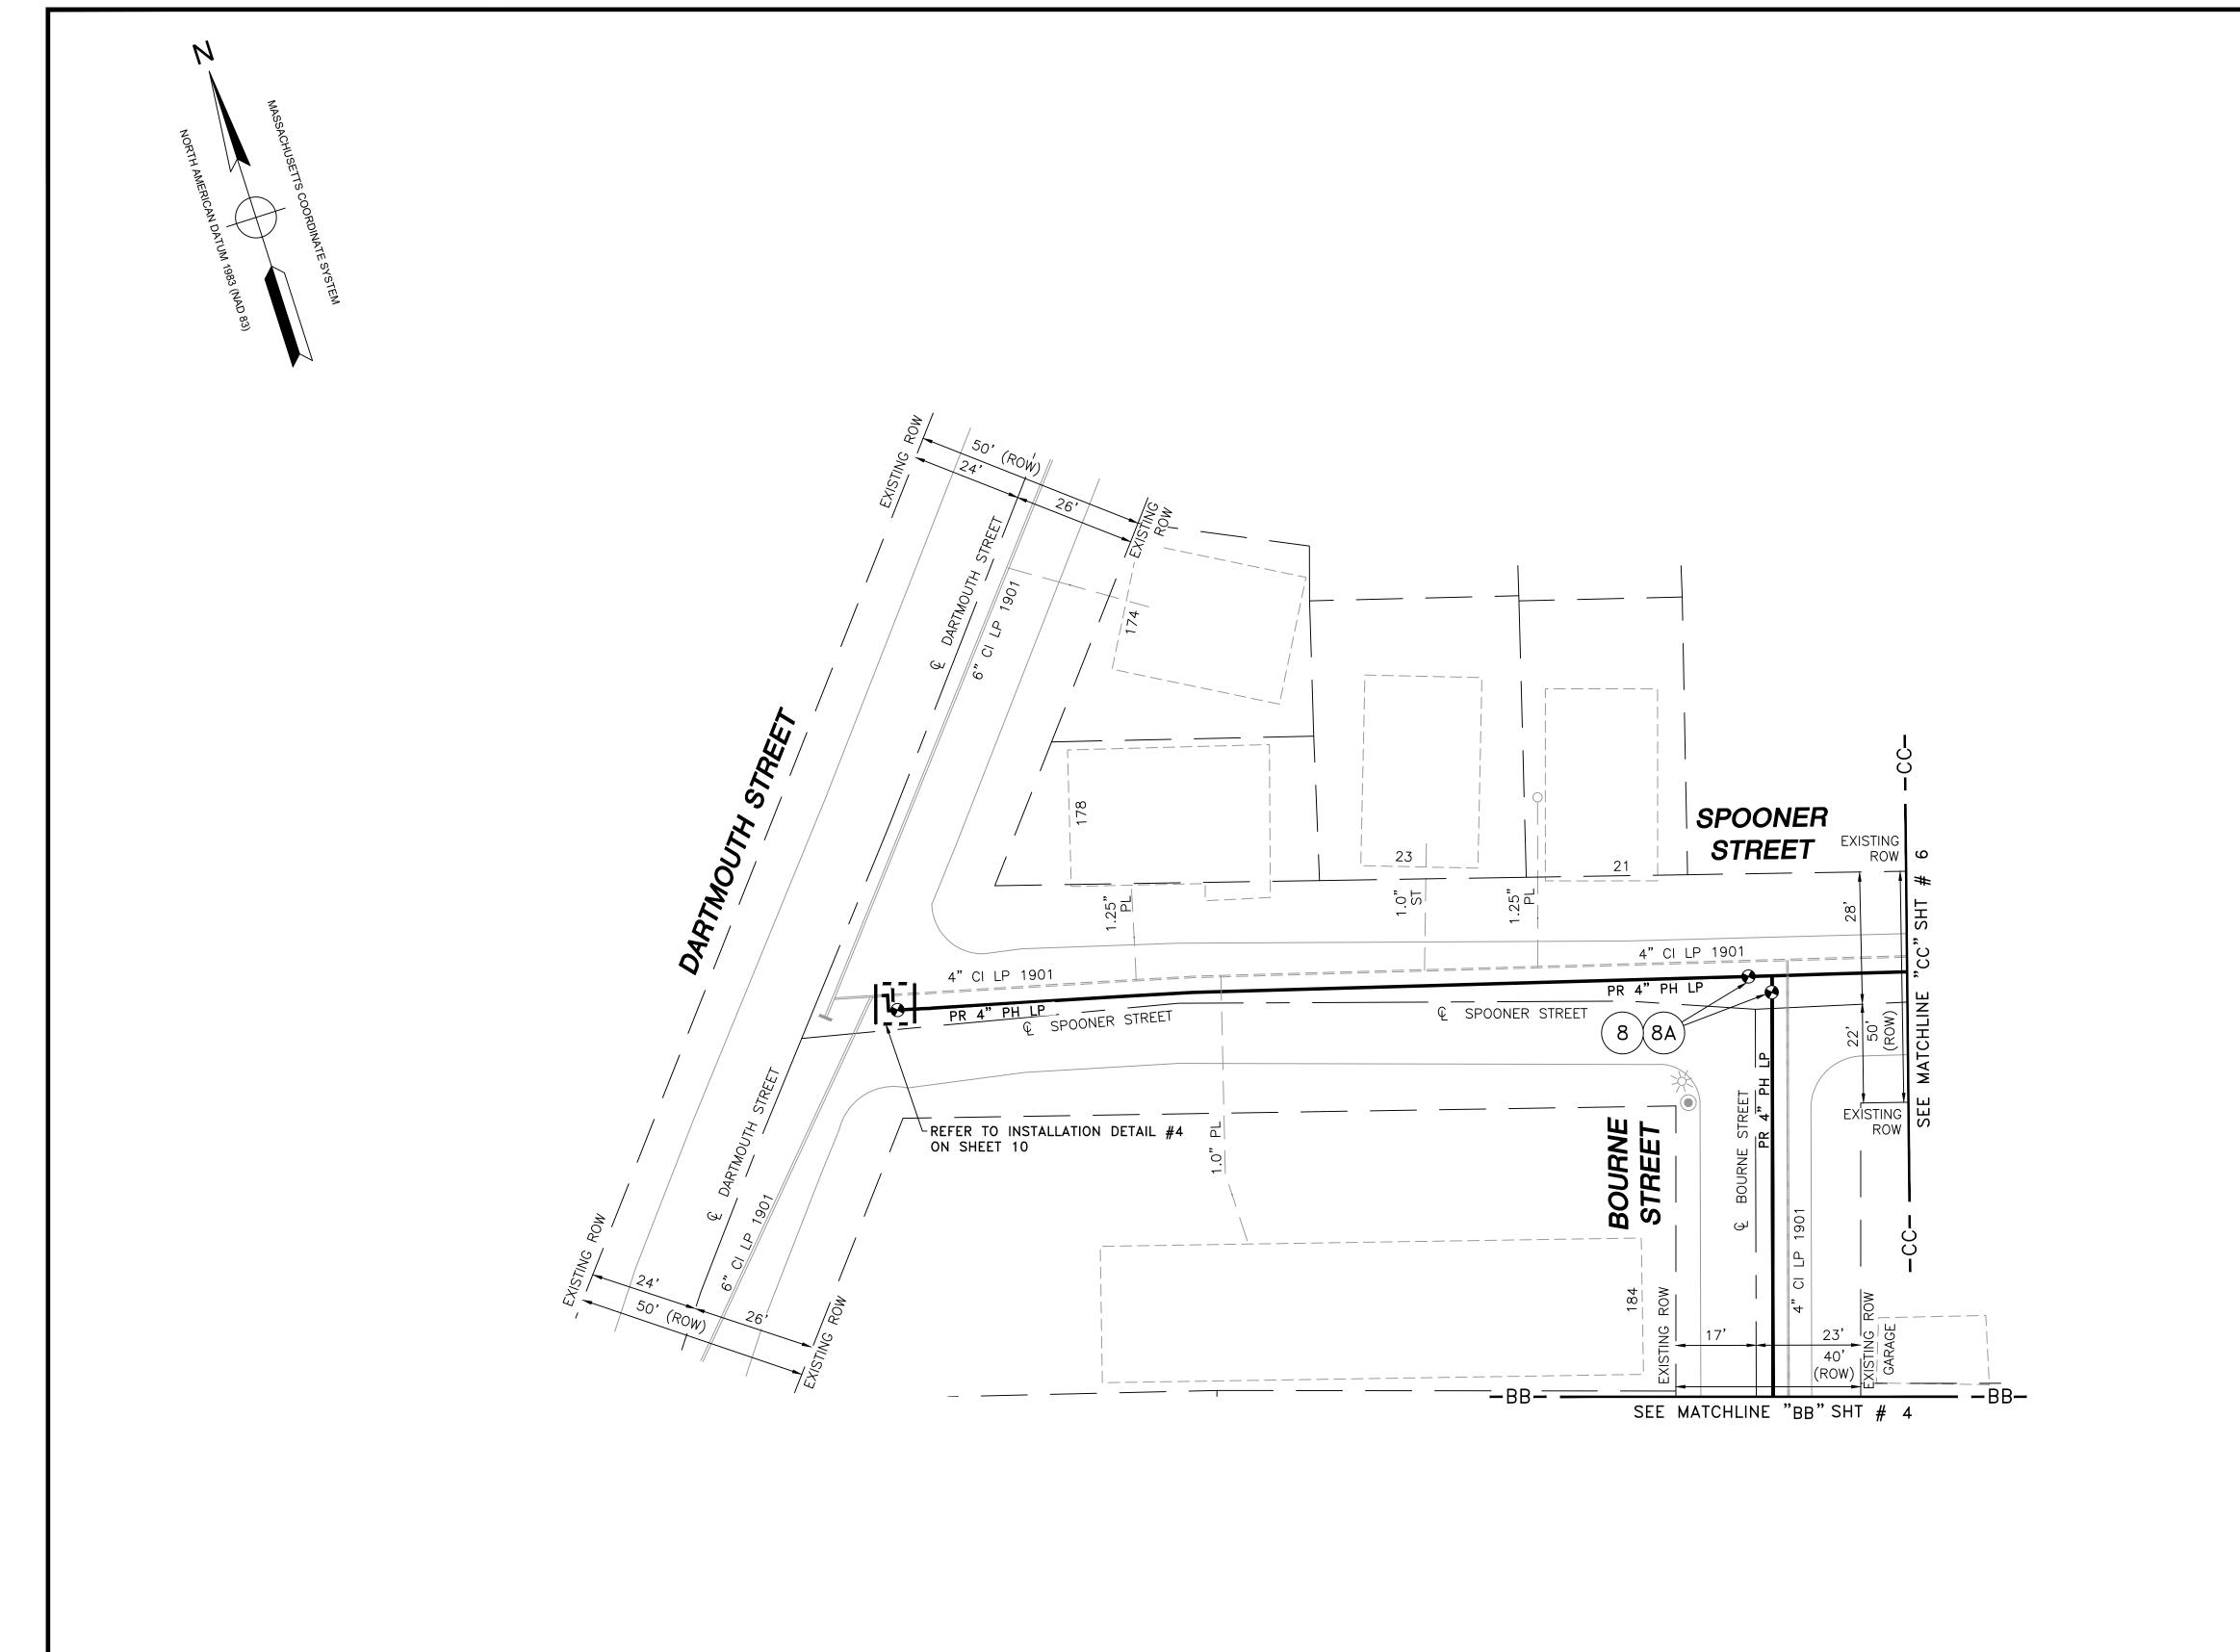


Paver St Babbitt St	The Bar Privet St. Rivet S	Spooner/st James B. Co	
	N	CUS PLAN OT TO SCALE	Almeida's
		·	
-	UTILITY POLE		EXISTING GAS
÷	UTILITY POLE LIGHT POLE		
			RETIRED GAS
*	LIGHT POLE		RETIRED GAS
*	LIGHT POLE CATCH BASIN		RETIRED GAS PROPOSED GA EXISTING SER
** 	LIGHT POLE CATCH BASIN FIRE HYDRANT		RETIRED GAS PROPOSED GA EXISTING SERV
** • • • • •	LIGHT POLE CATCH BASIN FIRE HYDRANT UTILITY MANHOLE	E	RETIRED GAS PROPOSED GA EXISTING SERV RIGHT OF WAY ELECTRIC
	LIGHT POLE CATCH BASIN FIRE HYDRANT UTILITY MANHOLE ELECTRIC MANHOLE	E	RETIRED GAS IN PROPOSED GAS IN EXISTING SERVING SERVIN
	LIGHT POLE CATCH BASIN FIRE HYDRANT UTILITY MANHOLE ELECTRIC MANHOLE TELEPHONE MANHOLE		RETIRED GAS PROPOSED GA EXISTING SERV RIGHT OF WAY ELECTRIC TELEPHONE WATER
	LIGHT POLE CATCH BASIN FIRE HYDRANT UTILITY MANHOLE ELECTRIC MANHOLE TELEPHONE MANHOLE WATER MANHOLE		RETIRED GAS IN PROPOSED GAS EXISTING SERVING SERVING SERVING SERVING SERVING SERVING TELECTRIC TELECTRIC TELECTRIC WATER
	LIGHT POLE CATCH BASIN FIRE HYDRANT UTILITY MANHOLE ELECTRIC MANHOLE TELEPHONE MANHOLE WATER MANHOLE SANITARY MANHOLE		RETIRED GAS PROPOSED GA EXISTING SERVING SERVING RIGHT OF WAY ELECTRIC TELEPHONE WATER SANITARY SEVEN
	LIGHT POLE CATCH BASIN FIRE HYDRANT UTILITY MANHOLE ELECTRIC MANHOLE TELEPHONE MANHOLE WATER MANHOLE SANITARY MANHOLE STORM MANHOLE		RETIRED GAS PROPOSED GA EXISTING SERV RIGHT OF WAY ELECTRIC TELEPHONE WATER SANITARY SEV
	LIGHT POLE CATCH BASIN FIRE HYDRANT UTILITY MANHOLE ELECTRIC MANHOLE TELEPHONE MANHOLE WATER MANHOLE SANITARY MANHOLE STORM MANHOLE EXISTING REDUCER	—————————————————————————————————————	RETIRED GAS PROPOSED GA EXISTING SERV RIGHT OF WAY ELECTRIC TELEPHONE WATER SANITARY SEV STORM SEWER PROPOSED RE

<u>Note</u>	<u>ES</u> :
1.	CONTRACTOR TO POTHOLE EXISTING UTILITIES
	AT CROSSING LOCATIONS PRIOR TO CONSTRUCTION.
2.	REFER TO GENERAL NOTES AND SCHEDULE OF
	MATERIALS ON SHEET #2.

LENGTH	SIZE	MATERIAL	DESCRIPTION
315'	4"	PH	INSTALL
315'	4"	CI	RETIRE

ISSUED FOR CONSTRUCTION 02/06/20

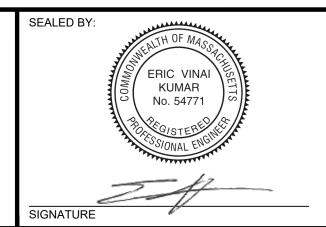

LICENSE EXPIRATION:	EN Engineering
02/10/2020	DESIGNED IN ACCORDANCE WITH TITLE 49-PART 192 OF MINIMUM FEDERAL SAFETY STANDARDS AND GPTC GUIDE FOR GAS TRANSMISSION AND DISTRIBUTION PIPING SYSTEMS. LATEST EDITION.
SEALED ON:	


06/30/2020


FIELD VERIFY DIMENSIONS
PRIOR TO PIPE FABRICATION

	FVFRS⊕URCI		
	REVISION STATUS		
NO.	DESCRIPTION	DATE	DW/CK/AP
0	ISSUED FOR CONSTRUCTION	02/06/2020	RT/AB

ENERGY
BOURNE STREET AND SPOONER STREET MAIN RELAY
NEW BEDFORD, MASSACHUSETTS
INSTALLATION PLAN

CALE:1"=20' SHEET 5 C					
DRAWN BY / DATE	CHECKED BY / DATE	SHEET NUMBER	REV. NO.		
DD 12/11/2019	AB 02/06/2020				
APPROVED BY / DATE	MA20PIPNEB022R0	MA-20-PIP-NEB-022-05	0		

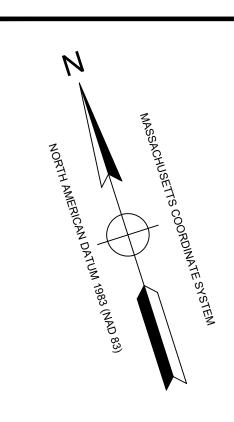

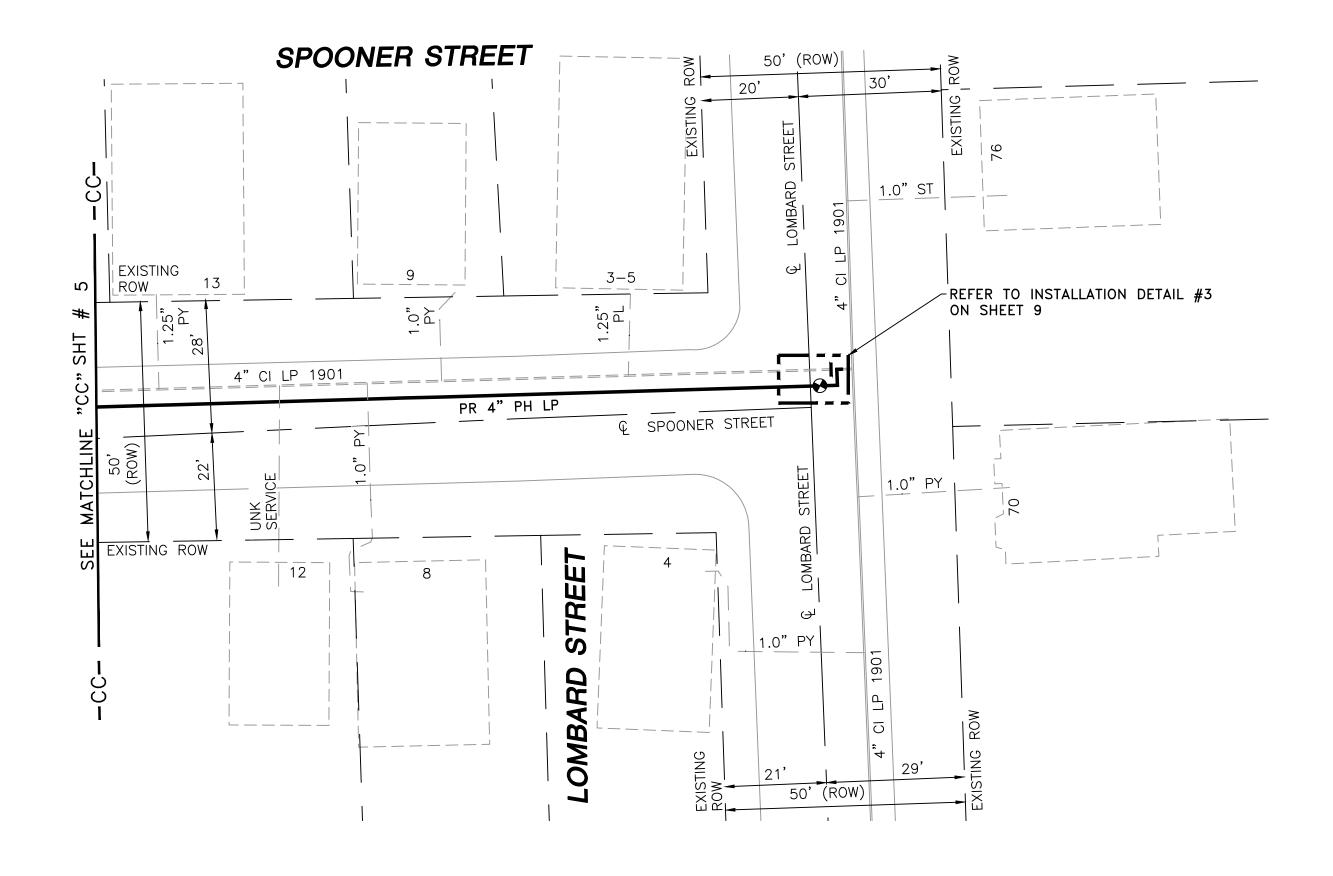

eaver St Babbitt St	The Bar Partmonth St. River St. Rive	James B. Con
	(I) ——	CUS PLAN T TO SCALE
	DRAWIN	NG LEGEND
$\overline{}$	UTILITY POLE	
*	LIGHT POLE	
	CATCH BASIN	
°()°	FIRE HYDRANT	
U	UTILITY MANHOLE	- — — -
E	ELECTRIC MANHOLE	—— Е
T	TELEPHONE MANHOLE	— т —
W	WATER MANHOLE	w
	SANITARY MANHOLE	<-<<-
	STORM MANHOLE	-<<
>	EXISTING REDUCER	•
l	EXISTING CAP	l
\otimes	EXISTING VALVE	Θ
-	EXISTING COUPLING	•

0	ISSUED FOR CONSTRUCTION	02/06/2020	RT/AB
NO.	DESCRIPTION	DATE	DW/CK/A
	DEV/ICIONI CTATLIC		

Almeida's Hardw

EXISTING GAS MAIN

RETIRED GAS MAIN

EXISTING SERVICE

RIGHT OF WAY

ELECTRIC

TELEPHONE

STORM SEWER

PROPOSED CAP

PROPOSED VALVE

PROPOSED COUPLING

PROPOSED REDUCER

WATER

PROPOSED GAS MAIN

REVISION STATUS

BOURNE STREET AND SPOONER STREET MAIN RELAY NEW BEDFORD, MASSACHUSETTS INSTALLATION PLAN

SCALE:1"=20' SHEET 6 OF 10 DRAWN BY / DATE DD 12/11/2019 APPROVED BY / DATE CHECKED BY / DATE AB 02/06/2020 SHEET NUMBER MA-20-PIP-NEB-022-06 MA20PIPNEB022R0


NOTES:

1. CONTRACTOR TO POTHOLE EXISTING UTILITIES
AT CROSSING LOCATIONS PRIOR TO CONSTRUCTION.

2. REFER TO GENERAL NOTES AND SCHEDULE OF MATERIALS ON SHEET #2.

LENGTH SIZE MATERIAL DESCRIPTION INSTALL PH 165' RETIRE CI 160'


ISSUED FOR CONSTRUCTION 02/06/20

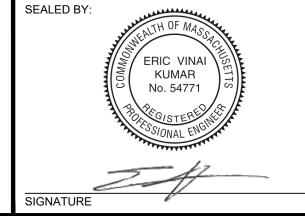


02/10/2020	DESIGNED IN ACCORDANCE WITH TITLE 49-PART 192 OF MINIMUM FEDERAL SAFETY STANDARDS AND GPTC GUIDE FOR GAS TRANSMISSION AND DISTRIBUTION PIPING SYSTEMS. LATEST EDITION.
LICENSE EXPIRATION:	EN Engineering
06/30/2020	29 BARTLETT STREET MARLBOROUGH, MA 01752 TEL. (630) 353-4000 FAX (630) 535-7777

SEALED ON:

FIELD VERIFY DIMENSIONS PRIOR TO PIPE FABRICATION FAX (630) 353-4000 FAX (630) 535-7777 WWW.ENENGINEERING.COM

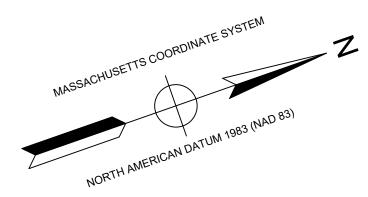

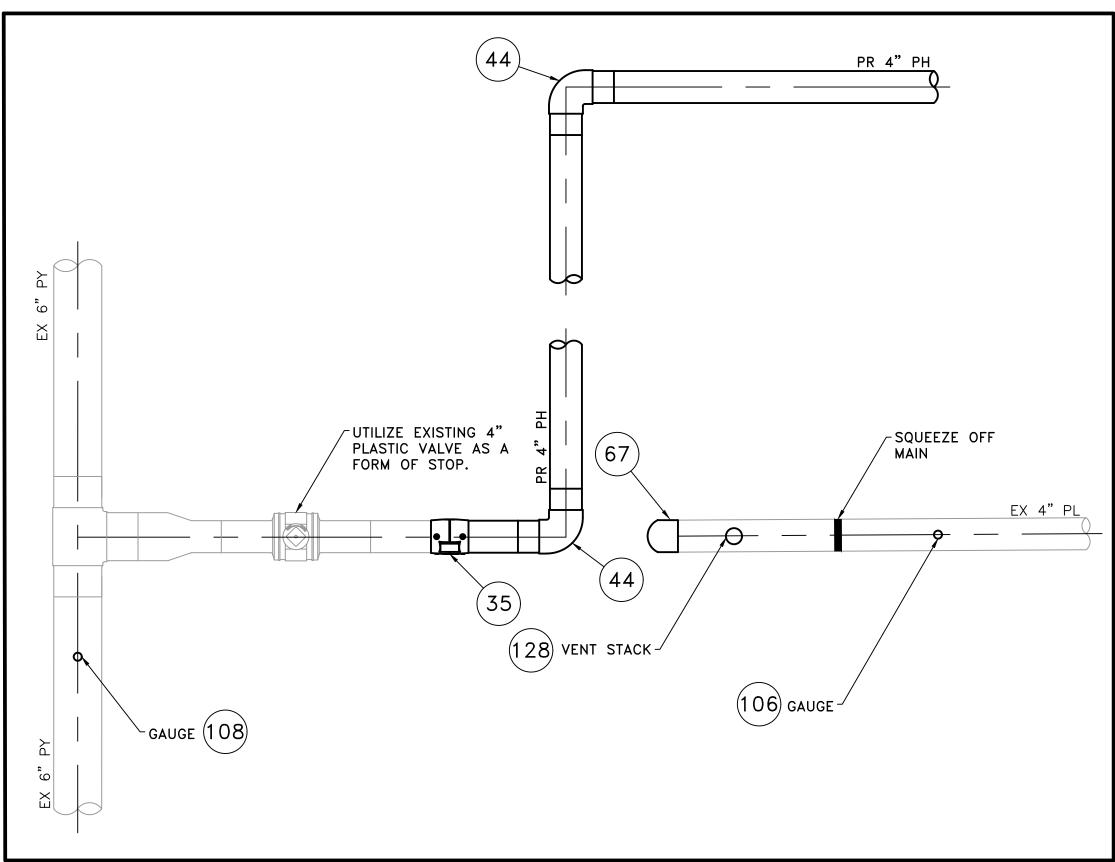

INSTALLATION DETAIL #1	

(SCALE: 1"=1") (REFER TO SHEET #3)

	BOURNE STREET & SPOONER STREET MAIN RELAYS - INSTALLATION DETAIL #1 - SCHEDULE OF MATERIALS					
ITEM	QTY	SIZE	MAXIMO NO.	DESCRIPTION	MATERIAL	
35	AS REQUIRED	4"	1 500255	COUPLING, ELECTROFUSION, IPS, HDPE 3408, ASTM D3350, ASTM F1055, COMPATIBLE FOR FUSION TO HDPE 3408/4710 PIPE. GFCP OR APPROVED EQUAL.	ASTM D3350	
44	AS REQUIRED	4"	1 545341	ELBOW, 90 DEG, BUTT FUSION, IPS, HDPE 4710, SDR 11, ASTM D2513, ASTM D3350, ASTM D3261. PERFORMANCE PIPE OR APPROVED EQUAL.	ASTM D2513	
50	AS REQUIRED	4"	1 545338	ELBOW, 45 DEG, BUTT FUSION, IPS, HDPE 4710, SDR 11, ASTM D2513, ASTM D3350, ASTM D3261. PERFORMANCE PIPE OR APPROVED EQUAL.	ASTM D2513	
67	AS REQUIRED	4"	1 542538	CAP, BUTT FUSION, IPS, HDPE 4710, SDR 11, ASTM D2513, ASTM D3350, ASTM D3261. PERFORMANCE PIPE OR APPROVED EQUAL.		
106	1	4" X 1"	560781	TAPPING TEE, ELECTROFUSION, IPS X IPS, HDPE 3408/4710, SDR 11, ASTM D2513, ASTM D3350, ASTM D3261, ASTM F1055. CENTRAL PLASTICS OR APPROVED EQUAL.		
108	1	6" X 1"	560785	TAPPING TEE, ELECTROFUSION, IPS X IPS, HDPE 3408/4710, SDR 11, ASTM D2513, ASTM D3350, ASTM D3261, ASTM F1055. CENTRAL PLASTICS OR APPROVED EQUAL.	ASTM D2513	
128	1	4" X 2"	1 584304	HV TAPPING TEE, ELECTROFUSION, IPS X IPS, HDPE 3408/4710, SDR 11, ASTM D2513, ASTM D3350, ASTM D3261, ASTM F1055. CENTRAL PLASTICS OR APPROVED EQUAL.	ASTM D2513	

STANDARD DRAWING NOTES:

- 1. IF ANY OF THE FOLLOWING OCCUR A DRAWING REVISION IS REQUIRED AND MUST BE APPROVED AND/OR STAMPED BY THE ENGINEER OF RECORD. CHANGES CAN BE APPROVED AND/OR STAMPED BY A PROJECT ENGINEER, BUT THE ENGINEER OF RECORD MUST BE INFORMED:
 - A. IF THE TIE IN POINT MOVES TO A DIFFERENT SEGMENT OF PIPE THAN
 - B. IF A CHANGE IN THE LOCATION OF VALVES IS REQUIRED
 - C. IF THERE IS ANY CHANGE TO WHAT IS SHOWN ON THE DRAWING WITHIN 50 FEET OF A PRESSURE REGULATING STATION, DISTRICT REGULATOR, OR GATE STATION
- 2. IF A CHANGE IN PIPE SIZE, MATERIAL, FITTINGS, OR WALL THICKNESS IS
- 3. MINOR CHANGES SUCH AS OFFSETS MAY NOT REQUIRE DRAWING CHANGES.
- 4. EXCAVATOR SHALL CALL DIGSAFE / CALL BEFORE YOU DIG (DIAL 811) AT LEAST 72 HOURS PRIOR TO CONSTRUCTION. SATURDAYS, SUNDAYS, AND HOLIDAYS ARE EXCLUDED FROM THE 72-HOUR TIME SPAN, NOT CONSIDERED BUSINESS WORKDAYS.
- 5. CONSTRUCTION DRAWINGS ARE BASED ON HISTORICAL DOCUMENTATION AND HAVE NOT BEEN FIELD VERIFIED. WHEN THE PIPE IS EXPOSED AND VARIANCES TO THE CERTIFIED DRAWINGS ARE FOUND, CONTACT GAS ENGINEERING TO DETERMINE PATH FORWARD.
- 6. ALL WORK SHALL BE PERFORMED PER EVERSOURCE, LOCAL, STATE, OSHA, AND FEDERAL REGULATIONS AND STANDARDS.
- 7. MATERIAL AND CONSTRUCTION SHALL CONFORM TO EVERSOURCE GAS STANDARDS.
- 8. THE LOCATIONS OF EXISTING UTILITIES AND UNDERGROUND STRUCTURES ARE APPROXIMATE AND MUST BE FIELD VERIFIED. ADDITIONAL UNDERGROUND FACILITIES MAY EXIST THAT ARE NOT SHOWN ON THESE DRAWINGS WHICH MAY REQUIRE ADDITIONAL OFFSETS IN THE PIPELINE.
- 9. LOCATIONS SHOWN ON THE DRAWINGS ARE APPROXIMATE. EXACT LOCATIONS OF INS SHALL BE DETERMINED AT THE TIME OF CONSTRUCTION TO SUIT FIELD CONDITIONS ON THE SPECIFIC TIE-IN POINT. VERIFY LOCATIONS OF ALL EXISTING UTILITIES PRIOR TO BEGINNING ANY TIE IN WORK.
- 10. ALL LIVE GAS WORK INCLUDING BUT NOT LIMITED TO TAPPING OF FITTINGS ON LIVE MAINS, STOPPING, MANIPULATING VALVE, ABANDONMENT, SHALL BE PERFORMED BY, OR AT THE DIRECTION AND UNDER THE DIRECT SUPERVISION OF EVERSOURCE GAS PERSONNEL AND IN ACCORDANCE WITH THE WRITTEN PROCEDURE. DRAWING CHANGES MAY ALSO REQUIRE A CHANGE TO THE PROCEDURE.
- 11. EXCAVATOR IS REQUIRED TO PROTECT EXISTING UTILITIES, STRUCTURES, LANDSCAPES FEATURES, SIGNAGE, CURBS, ETC. CARE SHOULD BE TAKEN NOT TO DISTURB OR DAMAGE SUCH ITEMS. ROADWAY, SIDEWALKS, AND GRASS DISTURBED SHALL BE RESTORED TO THE SATISFACTION OF THE CITY OR TOWN. PLANT BEDS WILL BE RELOCATED TO THEIR EXISTING REGULAR LOCATION.
- 12. IF THE PROJECT IS WITHIN 50 FEET OF A DISTRICT REGULATOR OR GATE STATION, ENSURE THAT A QUALIFIED I&R TECHNICIAN IS ON SITE.
- 13. ALL TRAFFIC CONTROL SHALL CONFORM TO THE LATEST EDITION OF THE MANUAL OF UNIFORM TRAFFIC CONTROL DEVICES (MUTCD), INCLUDING ALL REVISIONS AND ADDENDA. ALL TRAFFIC CONTROL DEVICES WILL BE SUPPLIED BY EXCAVATOR.
- 14. PROPERTY LINES AND STRUCTURES DEPICTED ON PLANS ARE BASED ON GIS INFORMATION AND HAVE NOT BEEN VERIFIED BY LAND SURVEY UNLESS NOTED.
- 15. ANY ADDITIONAL NOTES MUST BE REVIEWED AND APPROVED BY GAS ENGINEERING.

0 ISSUED FOR CONSTRUCTION 02/06/2020 RT/AB NO. DESCRIPTION DATE DW/CK/AF **REVISION STATUS**


EVERSURCE

MA20PIPNEB022R0

BOURNE STREET AND SPOONER STREET MAIN RELAY NEW BEDFORD, MASSACHUSETTS INSTALLATION DETAIL #1 AND SCHEDULE OF MATERIALS

SCALE: 1"=1' SHEET 7 OF 10 DRAWN BY / DATE DD 12/11/2019 APPROVED BY / DATE SHEET NUMBER CHECKED BY / DATE AB 02/06/2020 MA-20-PIP-NEB-022-07

ISSUED FOR CONSTRUCTION 02/06/20

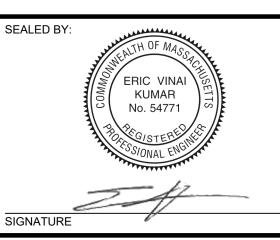


SEALED ON: 02/10/2020

ENEngineering 29 BARTLETT STREET MARLBOROUGH, MA 01752 TEL. (630) 353-4000 FAX (630) 535-7777 WWW.ENENGINEERING.COM


FIELD VERIFY DIMENSIONS

PRIOR TO PIPE FABRICATION

LICENSE EXPIRATION: 06/30/2020

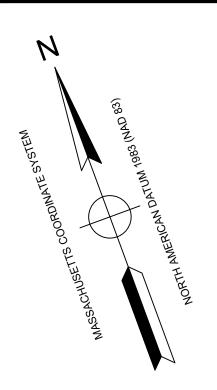


	BOURNE STREET & SPOONER STREET MAIN RELAYS - INSTALLATION DETAIL #2 - SCHEDULE OF MATERIALS						
ITEM	QTY	SIZE	MAXIMO NO.	DESCRIPTION	MATERIAL		
8	2	4"	501002	BALL VALVE, BUTT FUSION, IPS, HDPE 3408/4710, SDR 11, ASTM D2513, ASME B16.40. FULL PORT, 1/4 TURN, KEROTEST POLYBALL OR APPROVED EQUAL.	ASTM D2513		
35	AS REQUIRED	4"	500855	COUPLING, ELECTROFUSION, IPS, HDPE 3408, ASTM D3350, ASTM F1055, COMPATIBLE FOR FUSION TO HDPE 3408/4710 PIPE. GFCP OR APPROVED EQUAL.	ASTM D3350		
44	AS REQUIRED	4"	545341	ELBOW, 90 DEG, BUTT FUSION, IPS, HDPE 4710, SDR 11, ASTM D2513, ASTM D3350, ASTM D3261. PERFORMANCE PIPE OR APPROVED EQUAL.	ASTM D2513		
50	AS REQUIRED	4"	545338	ELBOW, 45 DEG, BUTT FUSION, IPS, HDPE 4710, SDR 11, ASTM D2513, ASTM D3350, ASTM D3261. PERFORMANCE PIPE OR APPROVED EQUAL.	ASTM D2513		
67	AS REQUIRED	4"	542538	CAP, BUTT FUSION, IPS, HDPE 4710, SDR 11, ASTM D2513, ASTM D3350, ASTM D3261. PERFORMANCE PIPE OR APPROVED EQUAL.			
74	2	4"	560679	TEE, STRAIGHT, BUTT FUSION, IPS, HDPE 4710, SDR 11, ASTM D2513, ASTM D3350, ASTM D3261. PERFORMANCE PIPE OR APPROVED EQUAL.	ASTM D2513		
128	2	4" X 2"	584304	HV TAPPING TEE, ELECTROFUSION, IPS X IPS, HDPE 3408/4710, SDR 11, ASTM D2513, ASTM D3350, ASTM D3261, ASTM F1055. CENTRAL PLASTICS OR APPROVED EQUAL.	ASTM D2513		
134	2	4"	578189	COUPLING, BOLTED MECHANICAL, IPS TO IPS, ASTM A-53 BODY, CONFORMS TO 49 CFR 192.283(b). SMITH-BLAIR MAXI-GRIP EZ OR APPROVED EQUAL.	ASTM A-53		
152	2	4"	578128	END CAP, BOLTED MECHANICAL, CIP. SMITH-BLAIR MAXI-GRIP OR APPROVED EQUAL			
170	8	4" x 2"	543028	BAND CLAMP, WITH WELDED 2" FNPT SERVICE OUTLET, 304L SS SINGLE SECTION BAND AND GAP BRIDGES, SS STUDS WITH TEFLON COATED HEX NUTS, COMPLETELY LINED WITH NITRILE RUBBER GASKET. MUELLER 540 SERVI-SEAL OR APPROVED EQUAL. COMPLETE WITH PLUG.			
8A	1	4"		BOX, VALVE, PLASTIC, SNAP-ON, ADJ, W/CI NON-LOCKING LID			

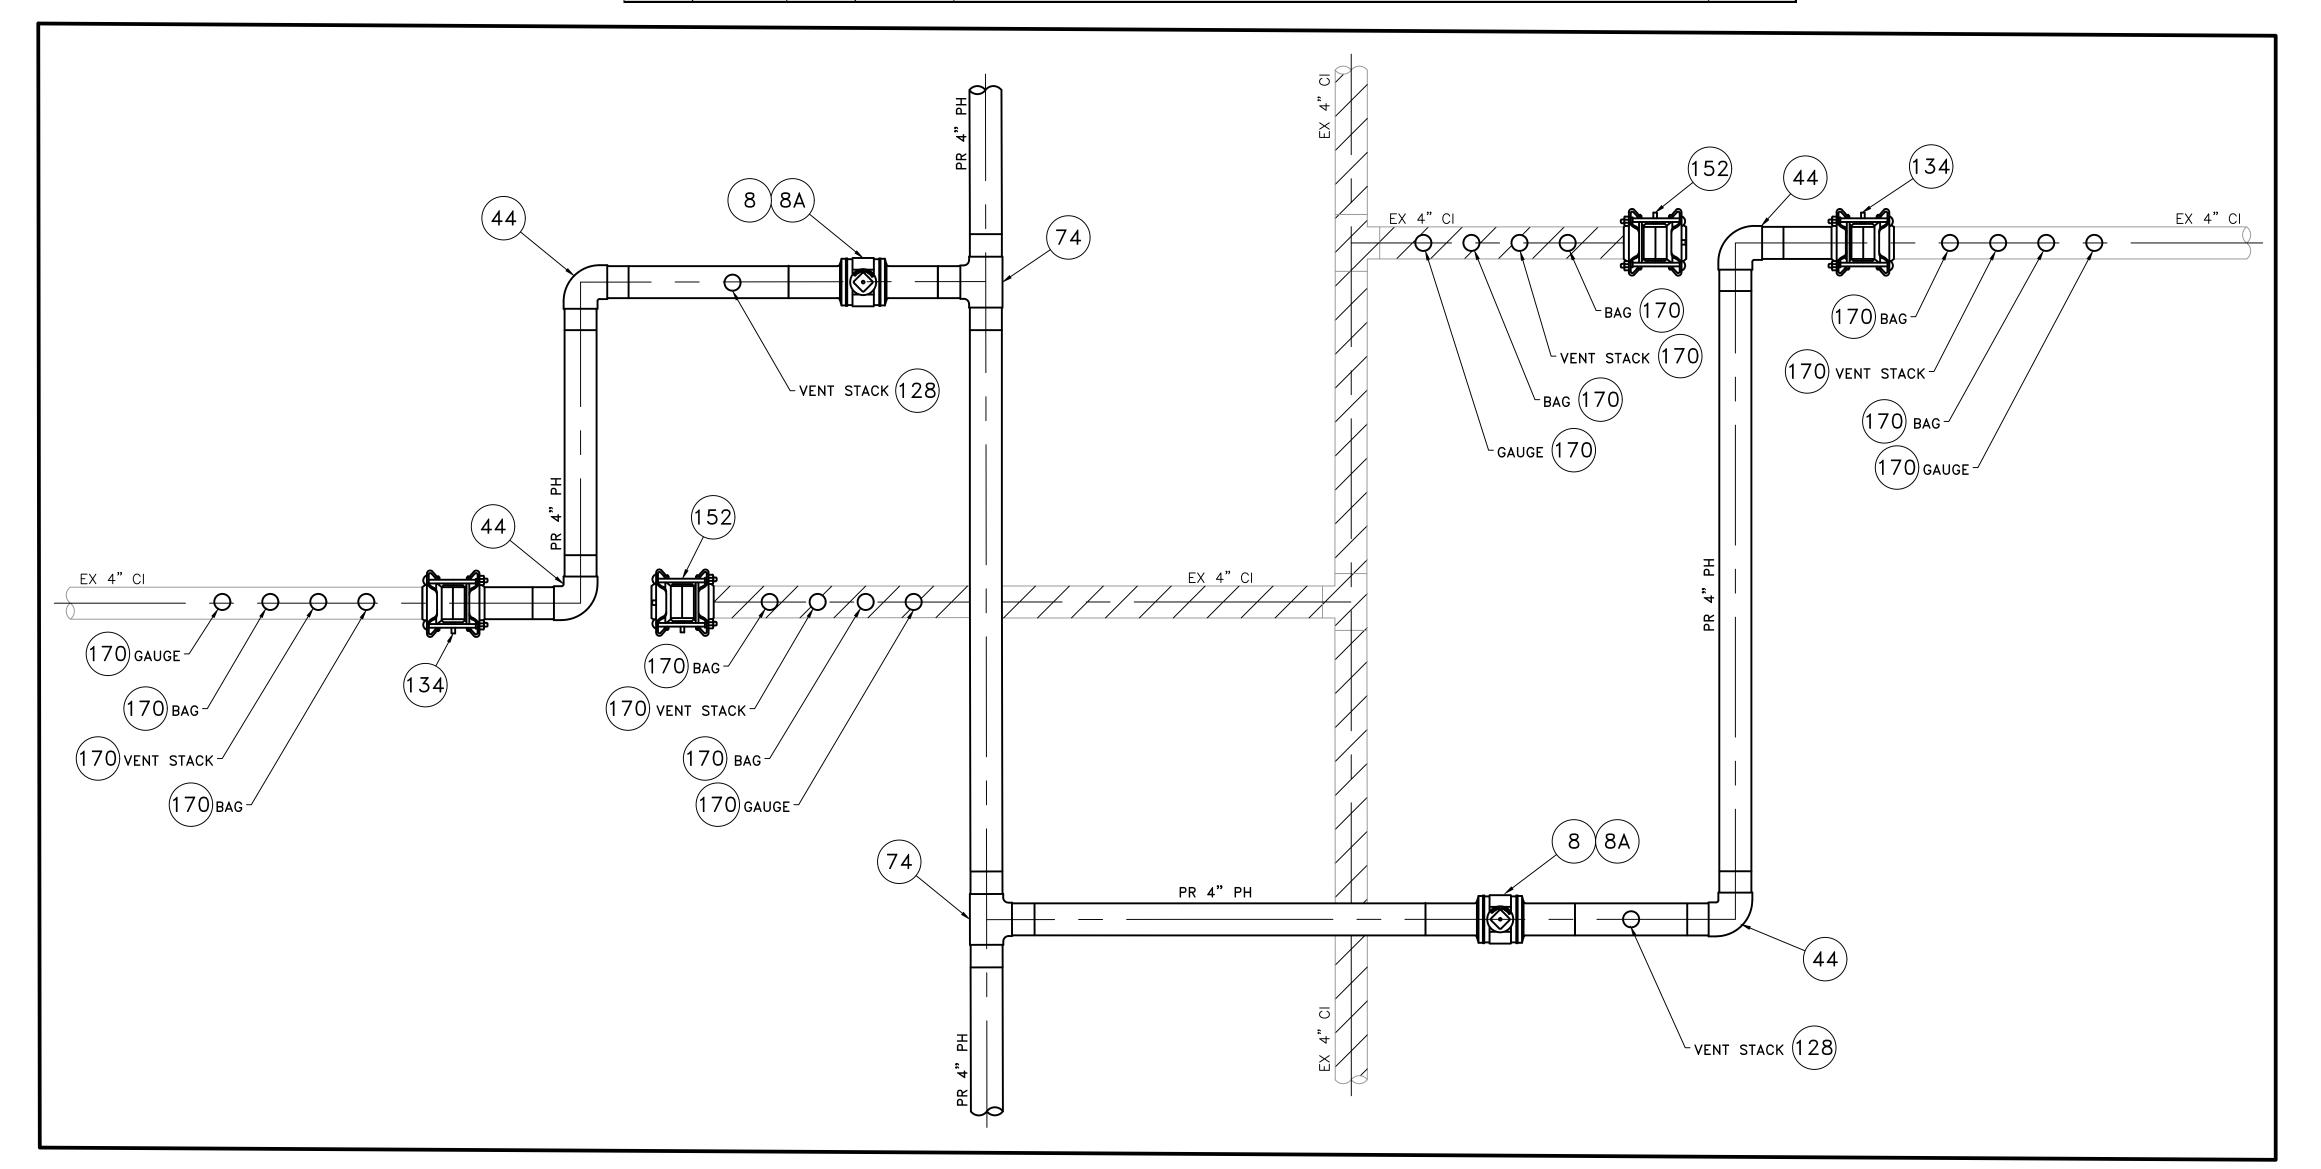

INSTALLATION DETAIL #2

(SCALE: 1"=1') (REFER TO SHEET #4)

ISSUED FOR CONSTRUCTION 02/06/20

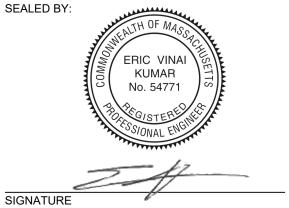

SEALED ON: 02/10/2020 LICENSE EXPIRATION: **ENE**ngineering

FIELD VERIFY DIMENSIONS PRIOR TO PIPE FABRICATION

STANDARD DRAWING NOTES:

- 1. IF ANY OF THE FOLLOWING OCCUR A DRAWING REVISION IS REQUIRED AND MUST BE APPROVED AND/OR STAMPED BY THE ENGINEER OF RECORD. CHANGES CAN BE APPROVED AND/OR STAMPED BY A PROJECT ENGINEER, BUT THE ENGINEER OF RECORD MUST BE INFORMED:
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 - B. IF A CHANGE IN THE LOCATION OF VALVES IS REQUIRED
 - C. IF THERE IS ANY CHANGE TO WHAT IS SHOWN ON THE DRAWING WITHIN 50 FEET OF A PRESSURE REGULATING STATION, DISTRICT REGULATOR, OR GATE STATION
- 2. IF A CHANGE IN PIPE SIZE, MATERIAL, FITTINGS, OR WALL THICKNESS IS REQUIRED.
- 3. MINOR CHANGES SUCH AS OFFSETS MAY NOT REQUIRE DRAWING CHANGES.
- 4. EXCAVATOR SHALL CALL DIGSAFE / CALL BEFORE YOU DIG (DIAL 811) AT LEAST 72 HOURS PRIOR TO CONSTRUCTION. SATURDAYS, SUNDAYS, AND HOLIDAYS ARE EXCLUDED FROM THE 72-HOUR TIME SPAN, NOT CONSIDERED BUSINESS WORKDAYS.
- 5. CONSTRUCTION DRAWINGS ARE BASED ON HISTORICAL DOCUMENTATION AND HAVE NOT BEEN FIELD VERIFIED. WHEN THE PIPE IS EXPOSED AND VARIANCES TO THE CERTIFIED DRAWINGS ARE FOUND, CONTACT GAS ENGINEERING TO DETERMINE PATH FORWARD.
- 6. ALL WORK SHALL BE PERFORMED PER EVERSOURCE, LOCAL, STATE, OSHA, AND FEDERAL REGULATIONS AND STANDARDS.
- 7. MATERIAL AND CONSTRUCTION SHALL CONFORM TO EVERSOURCE GAS STANDARDS.
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- 9. LOCATIONS SHOWN ON THE DRAWINGS ARE APPROXIMATE. EXACT LOCATIONS OF INS SHALL BE DETERMINED AT THE TIME OF CONSTRUCTION TO SUIT FIELD CONDITIONS ON THE SPECIFIC TIE-IN POINT. VERIFY LOCATIONS OF ALL EXISTING UTILITIES PRIOR TO BEGINNING ANY TIE IN WORK.
- 10. ALL LIVE GAS WORK INCLUDING BUT NOT LIMITED TO TAPPING OF FITTINGS ON LIVE MAINS, STOPPING, MANIPULATING VALVE, ABANDONMENT, SHALL BE PERFORMED BY, OR AT THE DIRECTION AND UNDER THE DIRECT SUPERVISION OF EVERSOURCE GAS PERSONNEL AND IN ACCORDANCE WITH THE WRITTEN PROCEDURE. DRAWING CHANGES MAY ALSO REQUIRE A CHANGE TO THE PROCEDURE.
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- 12. IF THE PROJECT IS WITHIN 50 FEET OF A DISTRICT REGULATOR OR GATE STATION, ENSURE THAT A QUALIFIED I&R TECHNICIAN IS ON SITE.
- 13. ALL TRAFFIC CONTROL SHALL CONFORM TO THE LATEST EDITION OF THE MANUAL OF UNIFORM TRAFFIC CONTROL DEVICES (MUTCD), INCLUDING ALL REVISIONS AND ADDENDA. ALL TRAFFIC CONTROL DEVICES WILL BE SUPPLIED BY EXCAVATOR.
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- 15. ANY ADDITIONAL NOTES MUST BE REVIEWED AND APPROVED BY GAS ENGINEERING.

	ISSUED FOR CONSTRUCTION	02/06/2020	RT/AB
١.	DESCRIPTION	DATE	DW/CK/AP
	REVISION STATUS		

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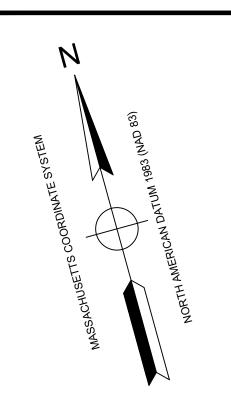
BOURNE STREET AND SPOONER STREET MAIN RELAY NEW BEDFORD, MASSACHUSETTS INSTALLATION DETAIL #2 AND SCHEDULE OF MATERIALS


MA-20-PIP-NEB-022-08

SCALE: 1"=1' SHEET 8 OF 10 DRAWN BY / DATE DD 12/11/2019 APPROVED BY / DATE SHEET NUMBER CHECKED BY / DATE AB 02/06/2020

1. REFER TO GENERAL NOTES ON SHEET #2.

29 BARTLETT STREET MARLBOROUGH, MA 01752 TEL. (630) 353-4000 FAX (630) 535-7777 WWW.ENENGINEERING.COM 06/30/2020



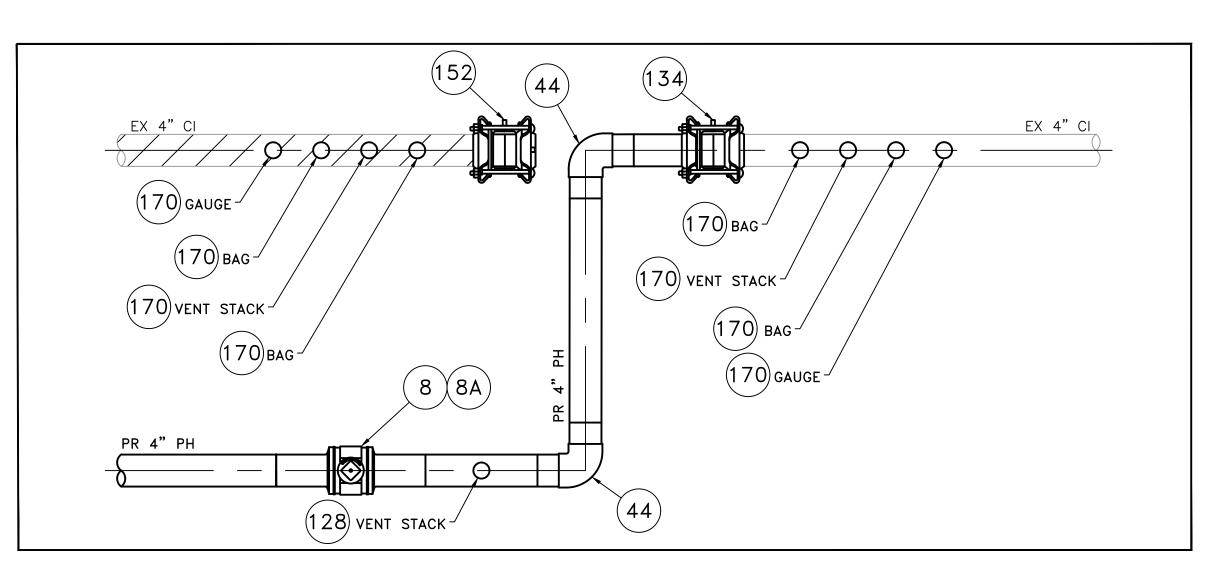

ITEM	QTY	SIZE	MAXIMO NO.	DESCRIPTION	MATERIAL
8	1	4"	501002	BALL VALVE, BUTT FUSION, IPS, HDPE 3408/4710, SDR 11, ASTM D2513, ASME B16.40. FULL PORT, 1/4 TURN, KEROTEST POLYBALL OR APPROVED EQUAL.	ASTM D2513
35	AS REQUIRED	4"	500855	COUPLING, ELECTROFUSION, IPS, HDPE 3408, ASTM D3350, ASTM F1055, COMPATIBLE FOR FUSION TO HDPE 3408/4710 PIPE. GFCP OR APPROVED EQUAL.	ASTM D335
44	AS REQUIRED	4"	545341	ELBOW, 90 DEG, BUTT FUSION, IPS, HDPE 4710, SDR 11, ASTM D2513, ASTM D3350, ASTM D3261. PERFORMANCE PIPE OR APPROVED EQUAL.	ASTM D251
50	AS REQUIRED	4"	545338	ELBOW, 45 DEG, BUTT FUSION, IPS, HDPE 4710, SDR 11, ASTM D2513, ASTM D3350, ASTM D3261. PERFORMANCE PIPE OR APPROVED EQUAL.	ASTM D251
67	AS REQUIRED	4"	542538	CAP, BUTT FUSION, IPS, HDPE 4710, SDR 11, ASTM D2513, ASTM D3350, ASTM D3261. PERFORMANCE PIPE OR APPROVED EQUAL.	
128	1	4" X 2"	584304	HV TAPPING TEE, ELECTROFUSION, IPS X IPS, HDPE 3408/4710, SDR 11, ASTM D2513, ASTM D3350, ASTM D3261, ASTM F1055. CENTRAL PLASTICS OR APPROVED EQUAL.	ASTM D251
134	1	4"	578189	COUPLING, BOLTED MECHANICAL, IPS TO IPS, ASTM A-53 BODY, CONFORMS TO 49 CFR 192.283(b). SMITH-BLAIR MAXI-GRIP EZ OR APPROVED EQUAL.	ASTM A-53
152	1	4"	578128	END CAP, BOLTED MECHANICAL, CIP. SMITH-BLAIR MAXI-GRIP OR APPROVED EQUAL	
170	4	4" x 2"	543028	BAND CLAMP, WITH WELDED 2" FNPT SERVICE OUTLET, 304L SS SINGLE SECTION BAND AND GAP BRIDGES, SS STUDS WITH TEFLON COATED HEX NUTS, COMPLETELY LINED WITH NITRILE RUBBER GASKET. MUELLER 540 SERVI-SEAL OR APPROVED EQUAL. COMPLETE WITH PLUG.	
8A	1	4"		BOX, VALVE, PLASTIC, SNAP-ON, ADJ, W/CI NON-LOCKING LID	

INSTALLATION DETAIL #3

(SCALE: 1"=1') (REFER TO SHEET #6)

STANDARD DRAWING NOTES:

- 1. IF ANY OF THE FOLLOWING OCCUR A DRAWING REVISION IS REQUIRED AND MUST BE APPROVED AND/OR STAMPED BY THE ENGINEER OF RECORD. CHANGES CAN BE APPROVED AND/OR STAMPED BY A PROJECT ENGINEER, BUT THE ENGINEER OF RECORD MUST BE INFORMED:
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- B. IF A CHANGE IN THE LOCATION OF VALVES IS REQUIRED
- C. IF THERE IS ANY CHANGE TO WHAT IS SHOWN ON THE DRAWING WITHIN 50 FEET OF A PRESSURE REGULATING STATION, DISTRICT REGULATOR, OR GATE STATION
- 2. IF A CHANGE IN PIPE SIZE, MATERIAL, FITTINGS, OR WALL THICKNESS IS REQUIRED.
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- 4. EXCAVATOR SHALL CALL DIGSAFE / CALL BEFORE YOU DIG (DIAL 811) AT LEAST 72 HOURS PRIOR TO CONSTRUCTION. SATURDAYS, SUNDAYS, AND HOLIDAYS ARE EXCLUDED FROM THE 72-HOUR TIME SPAN, NOT CONSIDERED BUSINESS WORKDAYS.
- 5. CONSTRUCTION DRAWINGS ARE BASED ON HISTORICAL DOCUMENTATION AND HAVE NOT BEEN FIELD VERIFIED. WHEN THE PIPE IS EXPOSED AND VARIANCES TO THE CERTIFIED DRAWINGS ARE FOUND, CONTACT GAS ENGINEERING TO DETERMINE PATH FORWARD.
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- 9. LOCATIONS SHOWN ON THE DRAWINGS ARE APPROXIMATE. EXACT LOCATIONS OF INS SHALL BE DETERMINED AT THE TIME OF CONSTRUCTION TO SUIT FIELD CONDITIONS ON THE SPECIFIC TIE-IN POINT. VERIFY LOCATIONS OF ALL EXISTING UTILITIES PRIOR TO BEGINNING ANY TIE IN WORK.
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- 12. IF THE PROJECT IS WITHIN 50 FEET OF A DISTRICT REGULATOR OR GATE STATION, ENSURE THAT A QUALIFIED I&R TECHNICIAN IS ON SITE.
- 13. ALL TRAFFIC CONTROL SHALL CONFORM TO THE LATEST EDITION OF THE MANUAL OF UNIFORM TRAFFIC CONTROL DEVICES (MUTCD), INCLUDING ALL REVISIONS AND ADDENDA. ALL TRAFFIC CONTROL DEVICES WILL BE SUPPLIED BY EXCAVATOR.
- 14. PROPERTY LINES AND STRUCTURES DEPICTED ON PLANS ARE BASED ON GIS INFORMATION AND HAVE NOT BEEN VERIFIED BY LAND SURVEY UNLESS NOTED.
- 15. ANY ADDITIONAL NOTES MUST BE REVIEWED AND APPROVED BY GAS ENGINEERING.

0 ISSUED FOR CONSTRUCTION 02/06/2020 RT/AB NO. DESCRIPTION DATE DW/CK/AF **REVISION STATUS**

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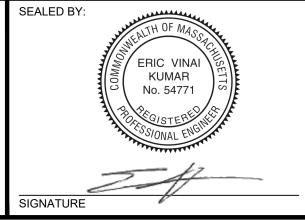
MA20PIPNEB022R0

BOURNE STREET AND SPOONER STREET MAIN RELAY NEW BEDFORD, MASSACHUSETTS

MA-20-PIP-NEB-022-09

PRIOR TO PIPE FABRICATION INSTALLATION DETAIL #3 AND SCHEDULE OF MATERIALS SHEET 9 OF 10 SCALE: 1"=1' DRAWN BY / DATE DD 12/11/2019 APPROVED BY / DATE SHEET NUMBER CHECKED BY / DATE AB 02/06/2020


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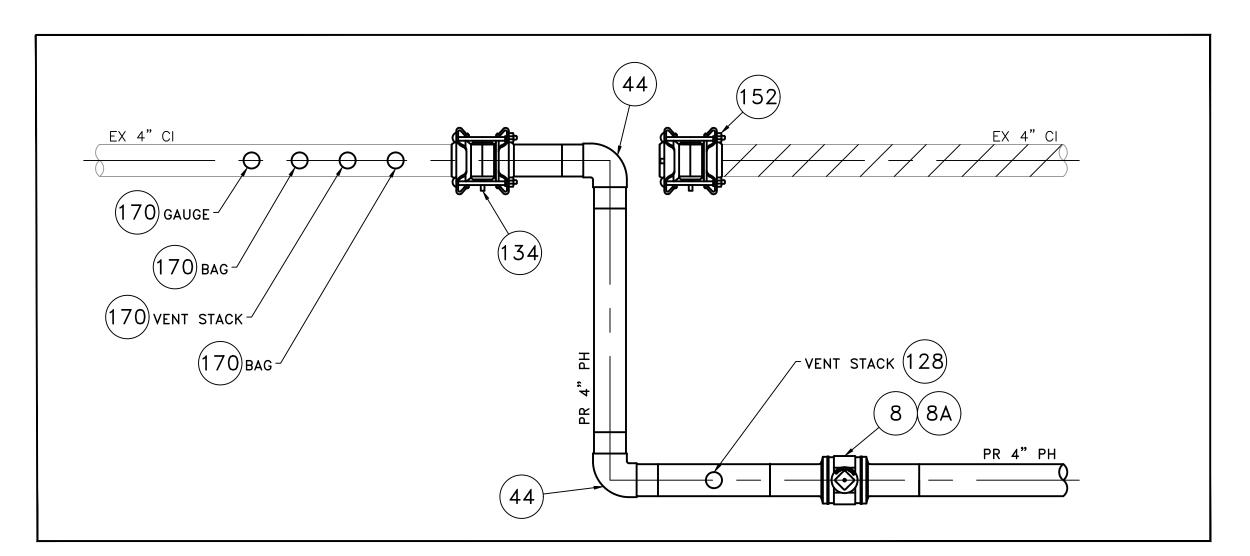


SEALED ON: 02/10/2020 LICENSE EXPIRATION: **EN**Engineering

29 BARTLETT STREET MARLBOROUGH, MA 01752 TEL. (630) 353-4000 FAX (630) 535-7777 WWW.ENENGINEERING.COM 06/30/2020

FIELD VERIFY DIMENSIONS



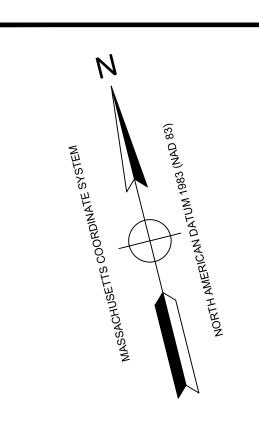

BOURNE STREET & SPOONER STREET MAIN RELAYS - INSTALLATION DETAIL #4 - SCHEDULE OF MATERIALS						
ITEM	QTY	SIZE	MAXIMO NO.	DESCRIPTION	MATERIAL	
8	1	4"	I 501002	BALL VALVE, BUTT FUSION, IPS, HDPE 3408/4710, SDR 11, ASTM D2513, ASME B16.40. FULL PORT, 1/4 TURN, KEROTEST POLYBALL OR APPROVED EQUAL.	ASTM D2513	
35	AS REQUIRED	4"	500855	COUPLING, ELECTROFUSION, IPS, HDPE 3408, ASTM D3350, ASTM F1055, COMPATIBLE FOR FUSION TO HDPE 3408/4710 PIPE. GFCP OR APPROVED EQUAL.	ASTM D3350	
44	AS REQUIRED	4"	545341	ELBOW, 90 DEG, BUTT FUSION, IPS, HDPE 4710, SDR 11, ASTM D2513, ASTM D3350, ASTM D3261. PERFORMANCE PIPE OR APPROVED EQUAL.	ASTM D2513	
50	AS REQUIRED	4"	545338	ELBOW, 45 DEG, BUTT FUSION, IPS, HDPE 4710, SDR 11, ASTM D2513, ASTM D3350, ASTM D3261. PERFORMANCE PIPE OR APPROVED EQUAL.	ASTM D2513	
67	AS REQIURED	4"	542538	CAP, BUTT FUSION, IPS, HDPE 4710, SDR 11, ASTM D2513, ASTM D3350, ASTM D3261. PERFORMANCE PIPE OR APPROVED EQUAL.		
128	1	4" X 2"	1 584304	HV TAPPING TEE, ELECTROFUSION, IPS X IPS, HDPE 3408/4710, SDR 11, ASTM D2513, ASTM D3350, ASTM D3261, ASTM F1055. CENTRAL PLASTICS OR APPROVED EQUAL.	ASTM D2513	
134	1	4"	578189	COUPLING, BOLTED MECHANICAL, IPS TO IPS, ASTM A-53 BODY, CONFORMS TO 49 CFR 192.283(b). SMITH-BLAIR MAXI-GRIP EZ OR APPROVED EQUAL.	ASTM A-53	
152	1	4"	578128	END CAP, BOLTED MECHANICAL, CIP. SMITH-BLAIR MAXI-GRIP OR APPROVED EQUAL		
170	4	4" x 2"	543028	BAND CLAMP, WITH WELDED 2" FNPT SERVICE OUTLET, 304L SS SINGLE SECTION BAND AND GAP BRIDGES, SS STUDS WITH TEFLON COATED HEX NUTS, COMPLETELY LINED WITH NITRILE RUBBER GASKET. MUELLER 540 SERVI-SEAL OR APPROVED EQUAL. COMPLETE WITH PLUG.		
8A	1	4"		BOX, VALVE, PLASTIC, SNAP-ON, ADJ, W/CI NON-LOCKING LID		

INSTALLATION DETAIL #4

(SCALE: 1"=1") (REFER TO SHEET #5)

STANDARD DRAWING NOTES:

- 1. IF ANY OF THE FOLLOWING OCCUR A DRAWING REVISION IS REQUIRED AND MUST BE APPROVED AND/OR STAMPED BY THE ENGINEER OF RECORD. CHANGES CAN BE APPROVED AND/OR STAMPED BY A PROJECT ENGINEER, BUT THE ENGINEER OF RECORD MUST BE INFORMED:
 - A. IF THE TIE IN POINT MOVES TO A DIFFERENT SEGMENT OF PIPE THAN
 - B. IF A CHANGE IN THE LOCATION OF VALVES IS REQUIRED
 - C. IF THERE IS ANY CHANGE TO WHAT IS SHOWN ON THE DRAWING WITHIN 50 FEET OF A PRESSURE REGULATING STATION, DISTRICT REGULATOR, OR GATE STATION
- 2. IF A CHANGE IN PIPE SIZE, MATERIAL, FITTINGS, OR WALL THICKNESS IS REQUIRED.
- 3. MINOR CHANGES SUCH AS OFFSETS MAY NOT REQUIRE DRAWING CHANGES.
- 4. EXCAVATOR SHALL CALL DIGSAFE / CALL BEFORE YOU DIG (DIAL 811) AT LEAST 72 HOURS PRIOR TO CONSTRUCTION. SATURDAYS, SUNDAYS, AND HOLIDAYS ARE EXCLUDED FROM THE 72-HOUR TIME SPAN, NOT CONSIDERED BUSINESS WORKDAYS.
- 5. CONSTRUCTION DRAWINGS ARE BASED ON HISTORICAL DOCUMENTATION AND HAVE NOT BEEN FIELD VERIFIED. WHEN THE PIPE IS EXPOSED AND VARIANCES TO THE CERTIFIED DRAWINGS ARE FOUND, CONTACT GAS ENGINEERING TO DETERMINE PATH FORWARD.
- 6. ALL WORK SHALL BE PERFORMED PER EVERSOURCE, LOCAL, STATE, OSHA, AND FEDERAL REGULATIONS AND STANDARDS.
- 7. MATERIAL AND CONSTRUCTION SHALL CONFORM TO EVERSOURCE GAS STANDARDS.
- 8. THE LOCATIONS OF EXISTING UTILITIES AND UNDERGROUND STRUCTURES ARE APPROXIMATE AND MUST BE FIELD VERIFIED. ADDITIONAL UNDERGROUND FACILITIES MAY EXIST THAT ARE NOT SHOWN ON THESE DRAWINGS WHICH MAY REQUIRE ADDITIONAL OFFSETS IN THE PIPELINE.
- 9. LOCATIONS SHOWN ON THE DRAWINGS ARE APPROXIMATE. EXACT LOCATIONS OF INS SHALL BE DETERMINED AT THE TIME OF CONSTRUCTION TO SUIT FIELD CONDITIONS ON THE SPECIFIC TIE-IN POINT. VERIFY LOCATIONS OF ALL EXISTING UTILITIES PRIOR TO BEGINNING ANY TIE IN WORK.
- 10. ALL LIVE GAS WORK INCLUDING BUT NOT LIMITED TO TAPPING OF FITTINGS ON LIVE MAINS, STOPPING, MANIPULATING VALVE, ABANDONMENT, SHALL BE PERFORMED BY, OR AT THE DIRECTION AND UNDER THE DIRECT SUPERVISION OF EVERSOURCE GAS PERSONNEL AND IN ACCORDANCE WITH THE WRITTEN PROCEDURE. DRAWING CHANGES MAY ALSO REQUIRE A CHANGE TO THE PROCEDURE.
- 11. EXCAVATOR IS REQUIRED TO PROTECT EXISTING UTILITIES, STRUCTURES, LANDSCAPES FEATURES, SIGNAGE, CURBS, ETC. CARE SHOULD BE TAKEN NOT TO DISTURB OR DAMAGE SUCH ITEMS. ROADWAY, SIDEWALKS, AND GRASS DISTURBED SHALL BE RESTORED TO THE SATISFACTION OF THE CITY OR TOWN. PLANT BEDS WILL BE RELOCATED TO THEIR EXISTING REGULAR LOCATION.
- 12. IF THE PROJECT IS WITHIN 50 FEET OF A DISTRICT REGULATOR OR GATE STATION, ENSURE THAT A QUALIFIED I&R TECHNICIAN IS ON SITE.
- 13. ALL TRAFFIC CONTROL SHALL CONFORM TO THE LATEST EDITION OF THE MANUAL OF UNIFORM TRAFFIC CONTROL DEVICES (MUTCD), INCLUDING ALL REVISIONS AND ADDENDA. ALL TRAFFIC CONTROL DEVICES WILL BE SUPPLIED BY EXCAVATOR.
- 14. PROPERTY LINES AND STRUCTURES DEPICTED ON PLANS ARE BASED ON GIS INFORMATION AND HAVE NOT BEEN VERIFIED BY LAND SURVEY UNLESS NOTED.
- 15. ANY ADDITIONAL NOTES MUST BE REVIEWED AND APPROVED BY GAS ENGINEERING.

0 ISSUED FOR CONSTRUCTION 02/06/2020 RT/AB NO. DESCRIPTION DATE DW/CK/AF **REVISION STATUS**


EVERSURCE

BOURNE STREET AND SPOONER STREET MAIN RELAY

NEW BEDFORD, MASSACHUSETTS INSTALLATION DETAIL #4 AND SCHEDULE OF MATERIALS

SHEET 10 OF 10 SCALE: 1"=1' DRAWN BY / DATE DD 12/11/2019 APPROVED BY / DATE SHEET NUMBER CHECKED BY / DATE AB 02/06/2020 MA-20-PIP-NEB-022-10 MA20PIPNEB022R0

ISSUED FOR CONSTRUCTION 02/06/20

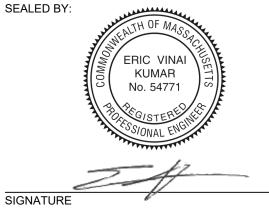

SEALED ON: 02/10/2020

FIELD VERIFY DIMENSIONS PRIOR TO PIPE FABRICATION **EN**Engineering

LICENSE EXPIRATION: 06/30/2020

29 BARTLETT STREET MARLBOROUGH, MA 01752 TEL. (630) 353-4000 FAX (630) 535-7777 WWW.ENENGINEERING.COM

1. REFER TO GENERAL NOTES ON SHEET #2.