

EVERSEURCE

ENERGY


SCOTT STREET, COUNTY STREET, AND COVE ROAD MAIN RELAY INSTALLATION OF 1560' OF 8" AND 1090' OF 2" PH LIP GAS MAIN SCOTT STREET, COUNTY STREET, AND COVE ROAD NEW BEDFORD, MASSACHUSETTS ENE PROJECT #: 2005881.41

EVERSOURCE PROJECT #:

SCOTT STREET (CRAPO STREET TO COUNTY STREET): 4338500

COUNTY STREET AND COVE ROAD (#1245 COVE ROAD TO #1130 COUNTY STREET): 4521740 COVE ROAD (CRAPO STREET TO #1245 COVE ROAD AND COUNTY STREET TO MARGIN STREET): 4434603

COUNTY STREET (COVE ROAD TO SCOTT STREET): 4541701

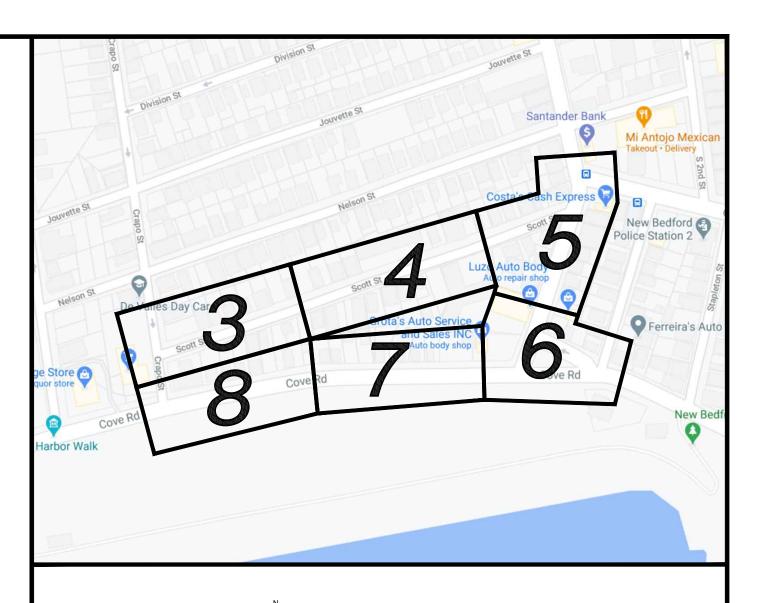

LOCUS PLAN

NOT TO SCALE

REFER TO LOCATION B - PHASE 1 AND 2 ON SHEET 10 NELSON STREET 1" PL LIP 1995 NELSON STREET	COVE STREET
NELSO 1 1 1 1 1 1 1 1 1	4" CI LP 1901
SCOTT STREET A" PD LP 1989 A" PD LP 1989	
REFER TO LOCATION A - PHASE 1 AND 2	
ON SHEET 9	
REFER TO LOCATIONS C AND D - PHASE 1 AND 2 ON SHEETS 11 AND 12	
SW SHEIS II AND 12	
PR 8" PH LIP	8" PH LIP
8" BS LIP 1923 REFER TO LOCATIONS E AND F - PHASE 1 AND 2 REFER TO LOCATION G ON SHEET 15	2" PY LIP 2015
ON SHEETS 13 AND 14	199)

SHEET HADEX					
SHEET NUMBER	DESCRIPTION				
1	SITE PLAN, LOCUS PLAN AND SHEET INDEX				
2	GENERAL NOTES AND WORK ORDER KEY MAP				
3	INSTALLATION PLAN				
4	INSTALLATION PLAN				
5	INSTALLATION PLAN				
6	INSTALLATION PLAN				
7	INSTALLATION PLAN				
8	INSTALLATION PLAN				
9	LOCATION A - PHASE 1, 2 AND SCHEDULE OF MATERIALS				
10	LOCATION B - PHASE 1, 2 AND SCHEDULE OF MATERIALS				
11	LOCATION C AND SCHEDULE OF MATERIALS				
12	LOCATION D - PHASE 1, 2 AND SCHEDULE OF MATERIALS				
13	LOCATION E - PHASE 1, 2 AND SCHEDULE OF MATERIALS				
14	LOCATION F - PHASE 1, 2 AND SCHEDULE OF MATERIALS				
15	LOCATION G AND SCHEDULE OF MATERIALS				
16	STANDARD CORROSION DETAILS				
<u> </u>					

SITE PLAN

NEW BEDFORD, MASSACHUSETTS (SCALE: 1"=60') (DO NOT SCALE FROM DRAWINGS)

ISSUED FOR REVIEW 01/05/2021 SEALED BY:

SEALED ON:

DA9-1
SIGNATURE

SEALED ON:

LICENSE EXPIRATION:

DESIGNED IN ACCORDANCE WITH TITLE
49-PART 192 OF MINIMUM FEDERAL SAFETY
STANDARDS AND GPTC GUIDE FOR GAS
TRANSMISSION AND DISTRIBUTION PIPING
SYSTEMS. LATEST EDITION.

ENGINEERING

29 BARTLETT STREET
MARLBOROUGH, MA 01752
TEL. (630) 353-4000
FAX (630) 535-7777
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REVISION STATUS

EVERSEURCE

ENERGY

A ISSUED FOR REVIEW

NO. DESCRIPTION

FIELD VERIFY DIMENSIONS

PRIOR TO PIPE FABRICATION

SCOTT STREET, COUNTY STREET, AND COVE ROAD MAIN RELAY
NEW BEDFORD, MASSACHUSETTS
SITE PLAN, LOCUS PLAN AND SHEET INDEX

01/05/2021 ZS/AB

DW/CK/AI

DATE


GENERAL NOTES


- 1. IF ANY OF THE FOLLOWING OCCUR A DRAWING REVISION IS REQUIRED AND MUST BE APPROVED AND/OR STAMPED BY THE ENGINEER OF RECORD. CHANGES CAN BE APPROVED AND/OR STAMPED BY A PROJECT ENGINEER, BUT THE ENGINEER OF RECORD MUST BE INFORMED.
 - A. IF THE TIE IN POINT MOVES TO A DIFFERENT SEGMENT OF PIPE THAN SHOWN
 - B. IF A CHANGE IN THE LOCATION OF VALVES IS REQUIRED
 - C. IF THERE IS ANY CHANGE TO WHAT IS SHOWN ON THE DRAWING WITHIN 50 FT OF A
 - PRESSURE REGULATING STATION, DISTRICT REGULATOR, OR GATE STATION

 D. IF A CHANGE IN PIPE SIZE, MATERIAL, FITTINGS, OR WALL THICKNESS IS REQUIRED.
- 2. MINOR CHANGES SUCH AS OFFSETS MAY NOT REQUIRE DRAWING CHANGES.
- 3. EXCAVATOR SHALL CALL DIGSAFE/CALL BEFORE YOU DIG (DIAL 811) AT LEAST 72 HOURS PRIOR TO CONSTRUCTION. SATURDAYS, SUNDAYS, AND HOLIDAYS ARE EXCLUDED FROM THE 72-HOUR TIME SPAN, NOT CONSIDERED BUSINESS WORKDAYS.
- 4. CONSTRUCTION DRAWINGS ARE BASED ON EVERSOURCE HISTORICAL DOCUMENTATION AND HAVE NOT BEEN FIELD VERIFIED. WHEN THE PIPE IS EXPOSED AND VARIANCES TO THE CERTIFIED DRAWINGS ARE FOUND, CONTACT GAS ENGINEERING TO DETERMINE PATH FORWARD.
- 5. ALL WORK SHALL BE PERFORMED PER EVERSOURCE, LOCAL, STATE, OSHA, AND FEDERAL REGULATIONS AND STANDARDS.
- 6. MATERIAL AND CONSTRUCTION SHALL CONFORM TO EVERSOURCE GAS STANDARDS.
- 7. THE LOCATIONS OF EXISTING UTILITIES AND UNDERGROUND STRUCTURES ARE APPROXIMATE AND MUST BE FIELD VERIFIED. ADDITIONAL UNDERGROUND FACILITIES MAY EXIST THAT ARE NOT SHOWN ON THESE DRAWINGS WHICH MAY REQUIRE ADDITIONAL OFFSETS IN THE PIPELINE.
- 8. WORK LOCATIONS SHOWN ON THE DRAWINGS ARE APPROXIMATE. EXACT LOCATIONS OF TIE-INS SHALL BE DETERMINED AT THE TIME OF CONSTRUCTION TO SUIT FIELD CONDITIONS AT THE SPECIFIC TIE-IN POINT. VERIFY LOCATIONS OF ALL EXISTING UTILITIES PRIOR TO BEGINNING ANY TIE-IN WORK.
- 9. ALL LIVE GAS WORK INCLUDING BUT NOT LIMITED TO TAPPING OF FITTINGS ON LIVE MAINS, STOPPING, MANIPULATING VALVE, ABANDONMENT, SHALL BE PERFORMED BY, OR AT THE DIRECTION AND UNDER THE DIRECT SUPERVISION OF EVERSOURCE GAS PERSONNEL AND IN ACCORDANCE WITH THE WRITTEN PROCEDURE. DRAWING CHANGES MAY ALSO REQUIRE A CHANGE TO THE PROCEDURE.
- 10. EXCAVATOR IS REQUIRED TO PROTECT EXISTING UTILITIES, STRUCTURES, LANDSCAPE FEATURES, SIGNAGE, CURBS, ETC. CARE SHOULD BE TAKEN NOT TO DISTURB OR DAMAGE SUCH ROADWAY, SIDEWALKS, AND GRASS DISTURBED SHALL BE RESTORED TO THE SATISFACTION OF THE CITY OR TOWN. PLANT BEDS WILL BE RELOCATED TO THEIR EXISTING REGULAR LOCATION.
- 11. IF THE PROJECT IS WITHIN 50 FEET OF A DISTRICT REGULATOR OR GATE STATION, ENSURE THAT A QUALIFIED I&R TECHNICIAN IS ON SITE.
- 12. ALL TRAFFIC CONTROL SHALL CONFORM TO THE LATEST EDITION OF THE MANUAL OF UNIFORM TRAFFIC CONTROL DEVICES (MUTCD), INCLUDING ALL REVISIONS AND ADDENDA. ALL TRAFFIC CONTROL DEVICES WILL BE SUPPLIED BY EXCAVATOR.
- 13. PROPERTY LINES, STRUCTURES AND EXISTING CONDITIONS DEPICTED ON PLANS ARE BASED ON EVERSOURCE GIS INFORMATION AND HAVE NOT BEEN VERIFIED BY LAND SURVEY UNLESS NOTED.
- 14. EXISTING SERVICES SHOWN ON PLAN ARE FOR INFORMATION ONLY. PROPOSED SERVICES ARE NOT SHOWN ON PLANS AND ARE TO BE INSTALLED PER EVERSOURCE CONSTRUCTION STANDARDS.
- 15. PROPOSED WORK SHALL BE PERFORMED AND COMPLETED IN COMPLIANCE WITH ALL PERMITS AND APPROVALS.
- 16. MAINS AND SERVICES SHALL BE PRESSURE TESTED IN ACCORDANCE WITH EVERSOURCE OM-205.
- 17. MAOP:

LP = 14" W.C. LIP = 35 PSIG IP = 60 PSIG HP = 90 PSIG

- 18. ALL WORK SHALL BE PERFORMED PER EVERSOURCE, LOCAL, STATE AND FEDERAL REGULATIONS AND STANDARDS.
- 19. ALL PIPE WILL BE INSTALLED WITH A MINIMUM DEPTH IN ACCORDANCE WITH EVERSOURCE STANDARDS
- 20. SQUEEZE OPERATIONS SHOULD BE COMPLETED IN ACCORDANCE WITH OM-233
- 21. ENSURE ALL SERVICES BEING TRANSFERRED TO A HIGHER PRESSURE SYSTEM HAVE UPGRADED PRESSURE REGULATORS INSTALLED PRIOR TO ACTIVATION.
- 22. ENSURE VALVES ON EXISTING MAIN, WHERE PROPOSED MAIN WILL BE INSERTED HAVE BEEN MADE INOPERABLE.
- 23. ADDITIONAL VALVES AND TEES THAT ARE INCLUDED IN THE SCHEDULE OF MATERIALS MAY BE INSTALLED TEMPORARILY WHEN NEEDED TO FACILITATE TIE-INS AND PURGES.
- 24. METFIT FITTINGS MAY BE SUBSTITUTED FOR ELECTROFUSION FITTINGS WHERE NEEDED.
- 25. DO NOT SCALE FROM DRAWINGS.

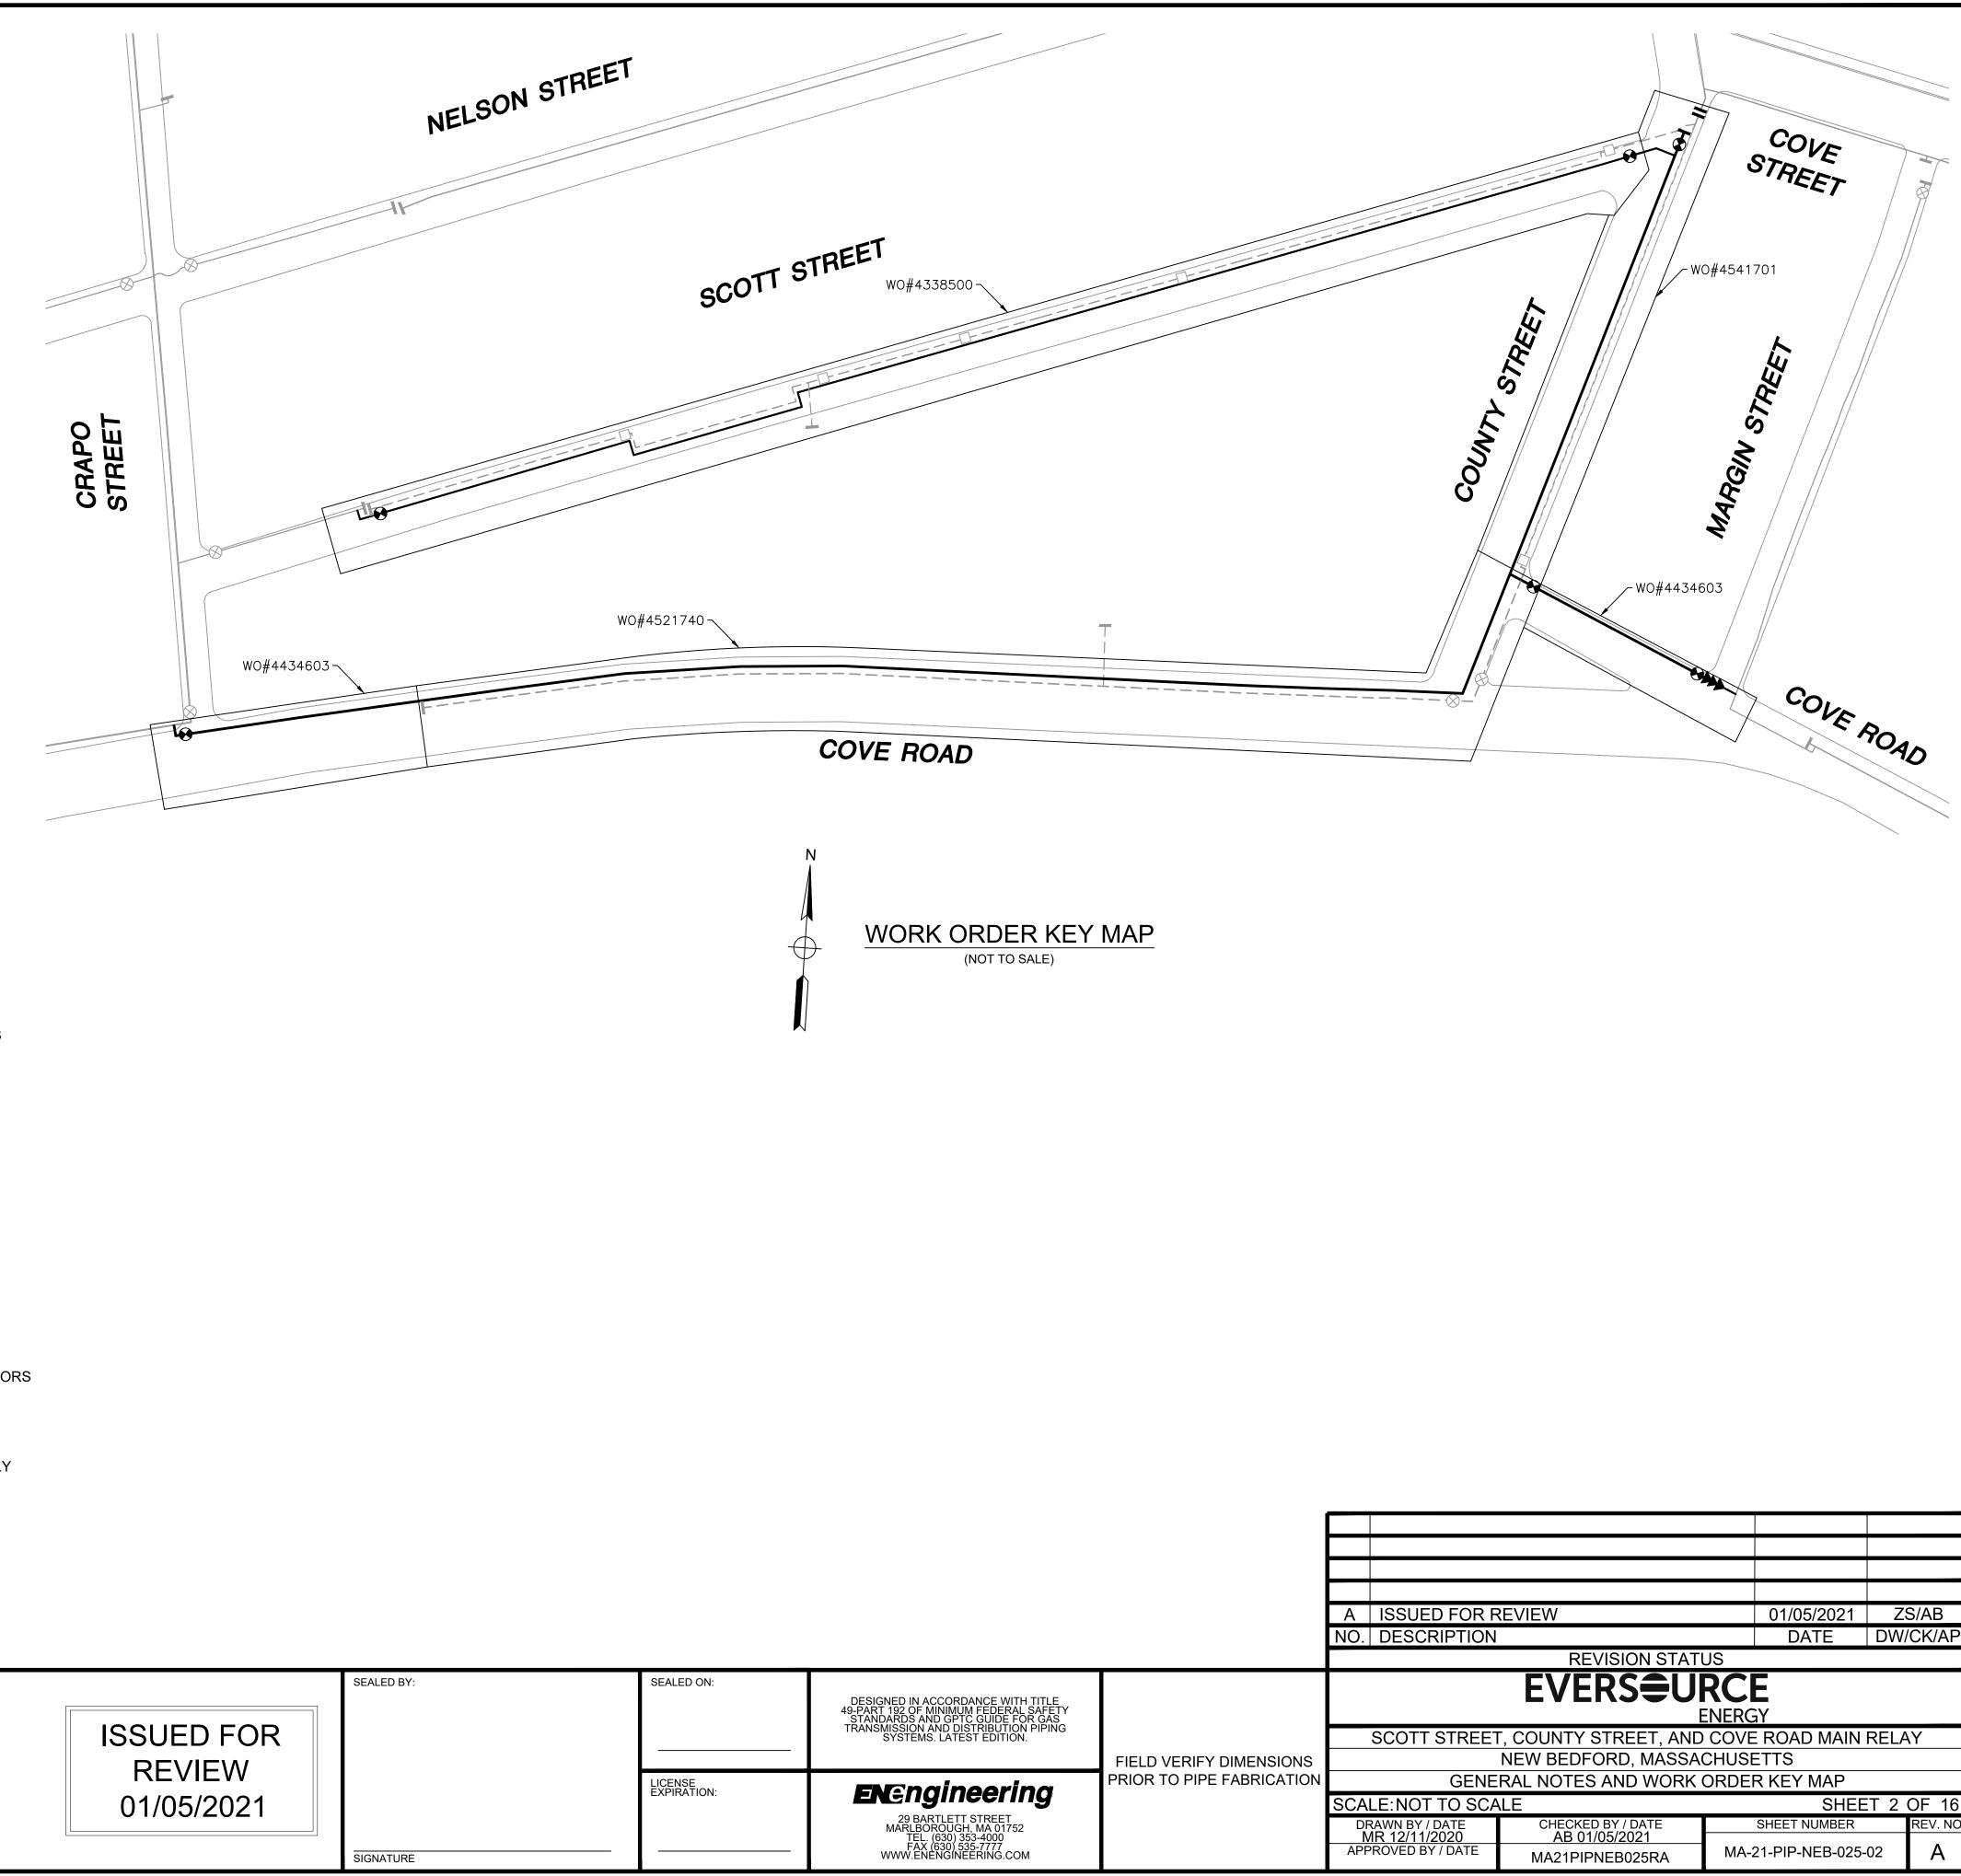

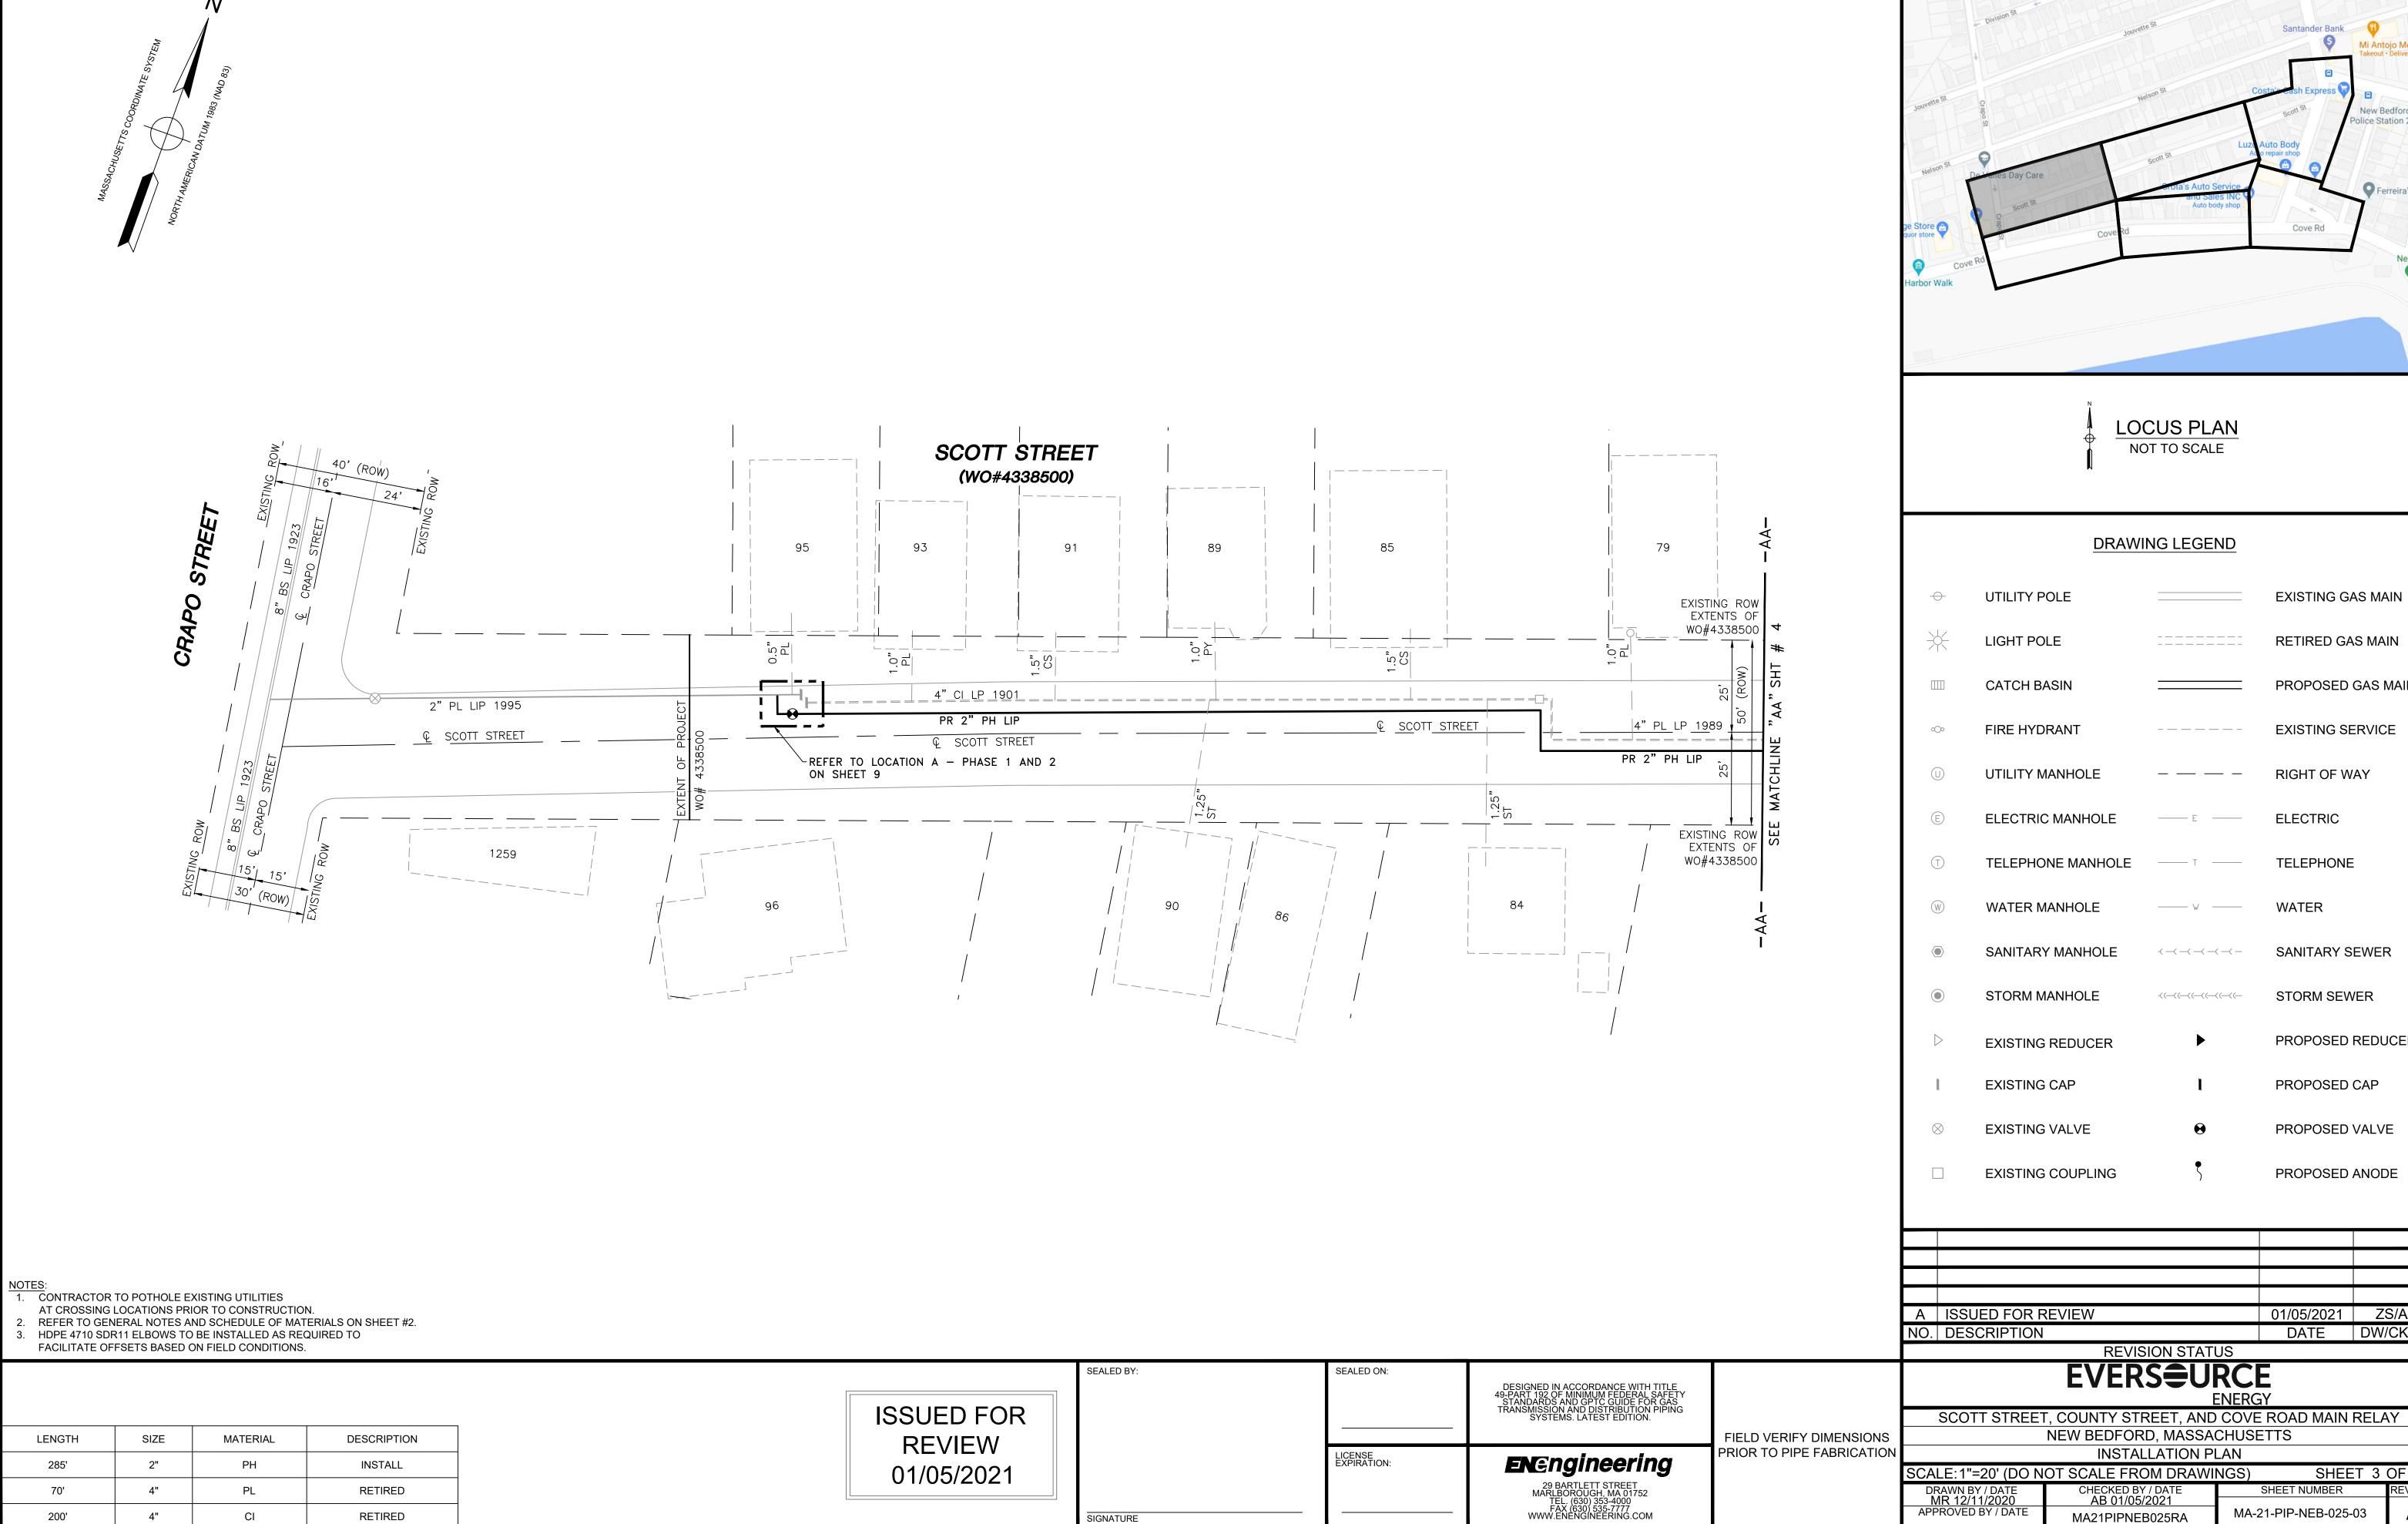

SIGNATURE

RETIRED

200'

New Bedford Police Station 2

EXISTING GAS MAIN

RETIRED GAS MAIN

PROPOSED GAS MAIN

EXISTING SERVICE

RIGHT OF WAY

ELECTRIC

TELEPHONE

SANITARY SEWER

STORM SEWER

PROPOSED CAP

PROPOSED VALVE

PROPOSED ANODE

01/05/2021 ZS/AB

DATE DW/CK/AP

SHEET 3 OF 16


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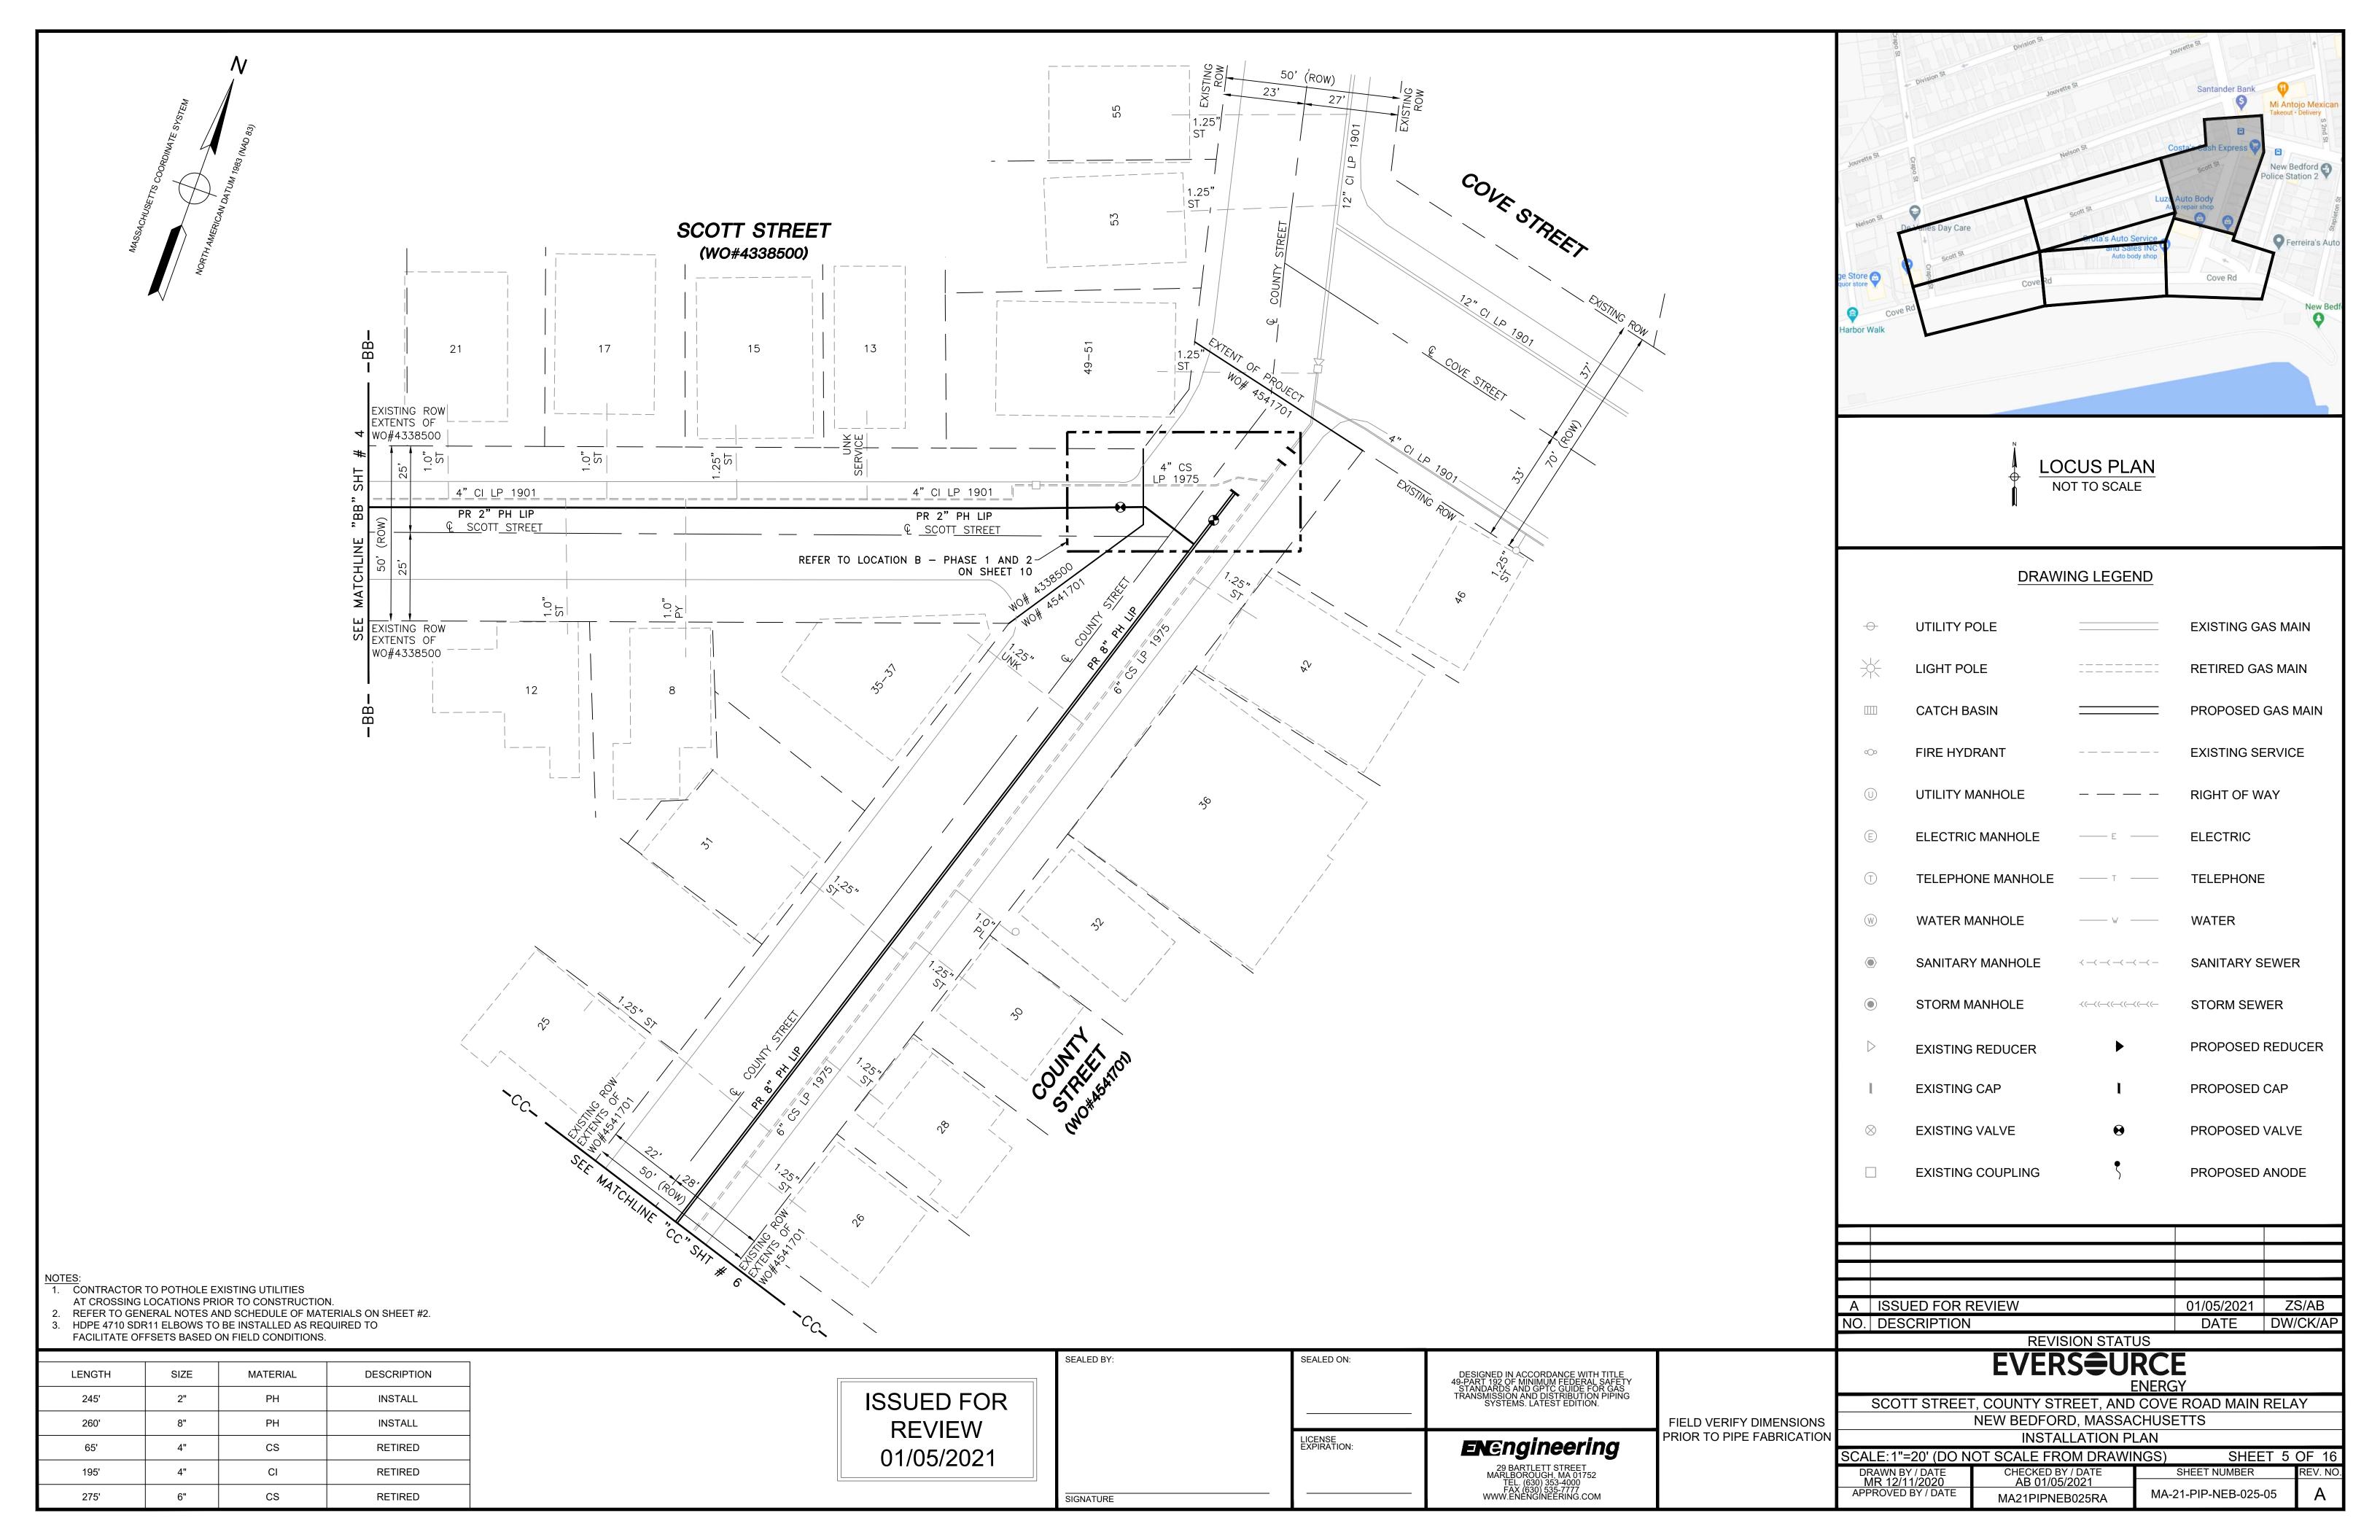
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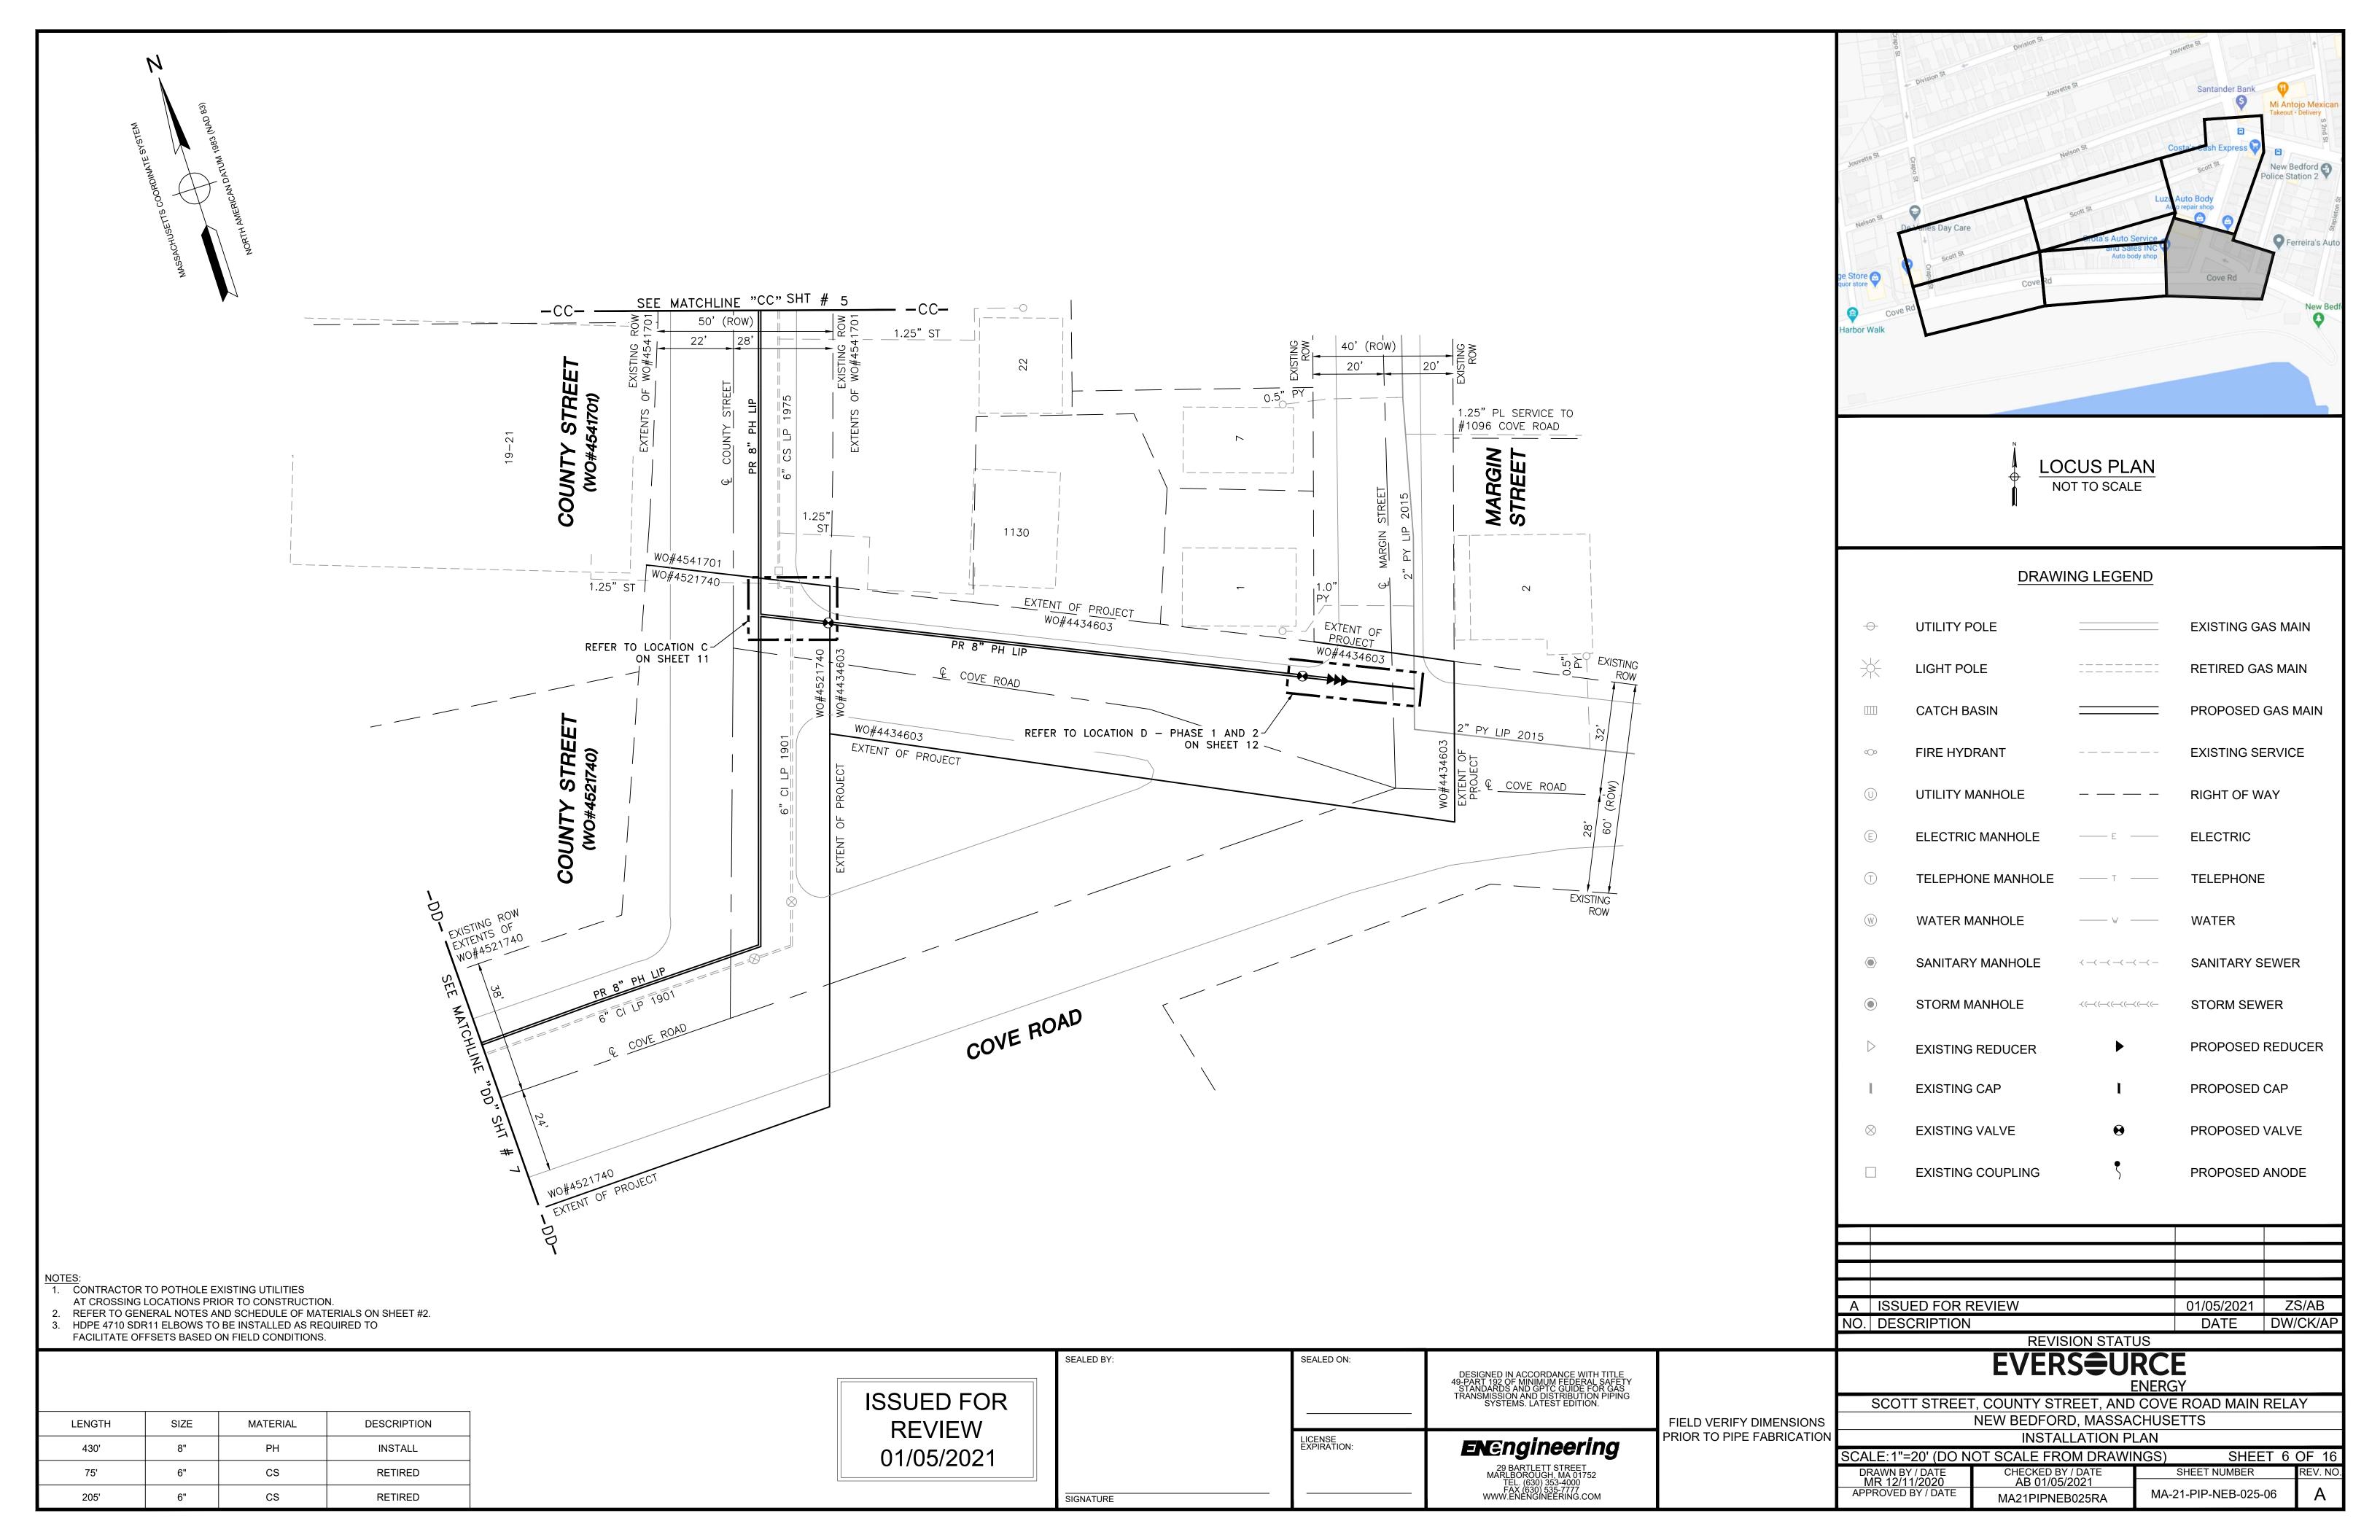
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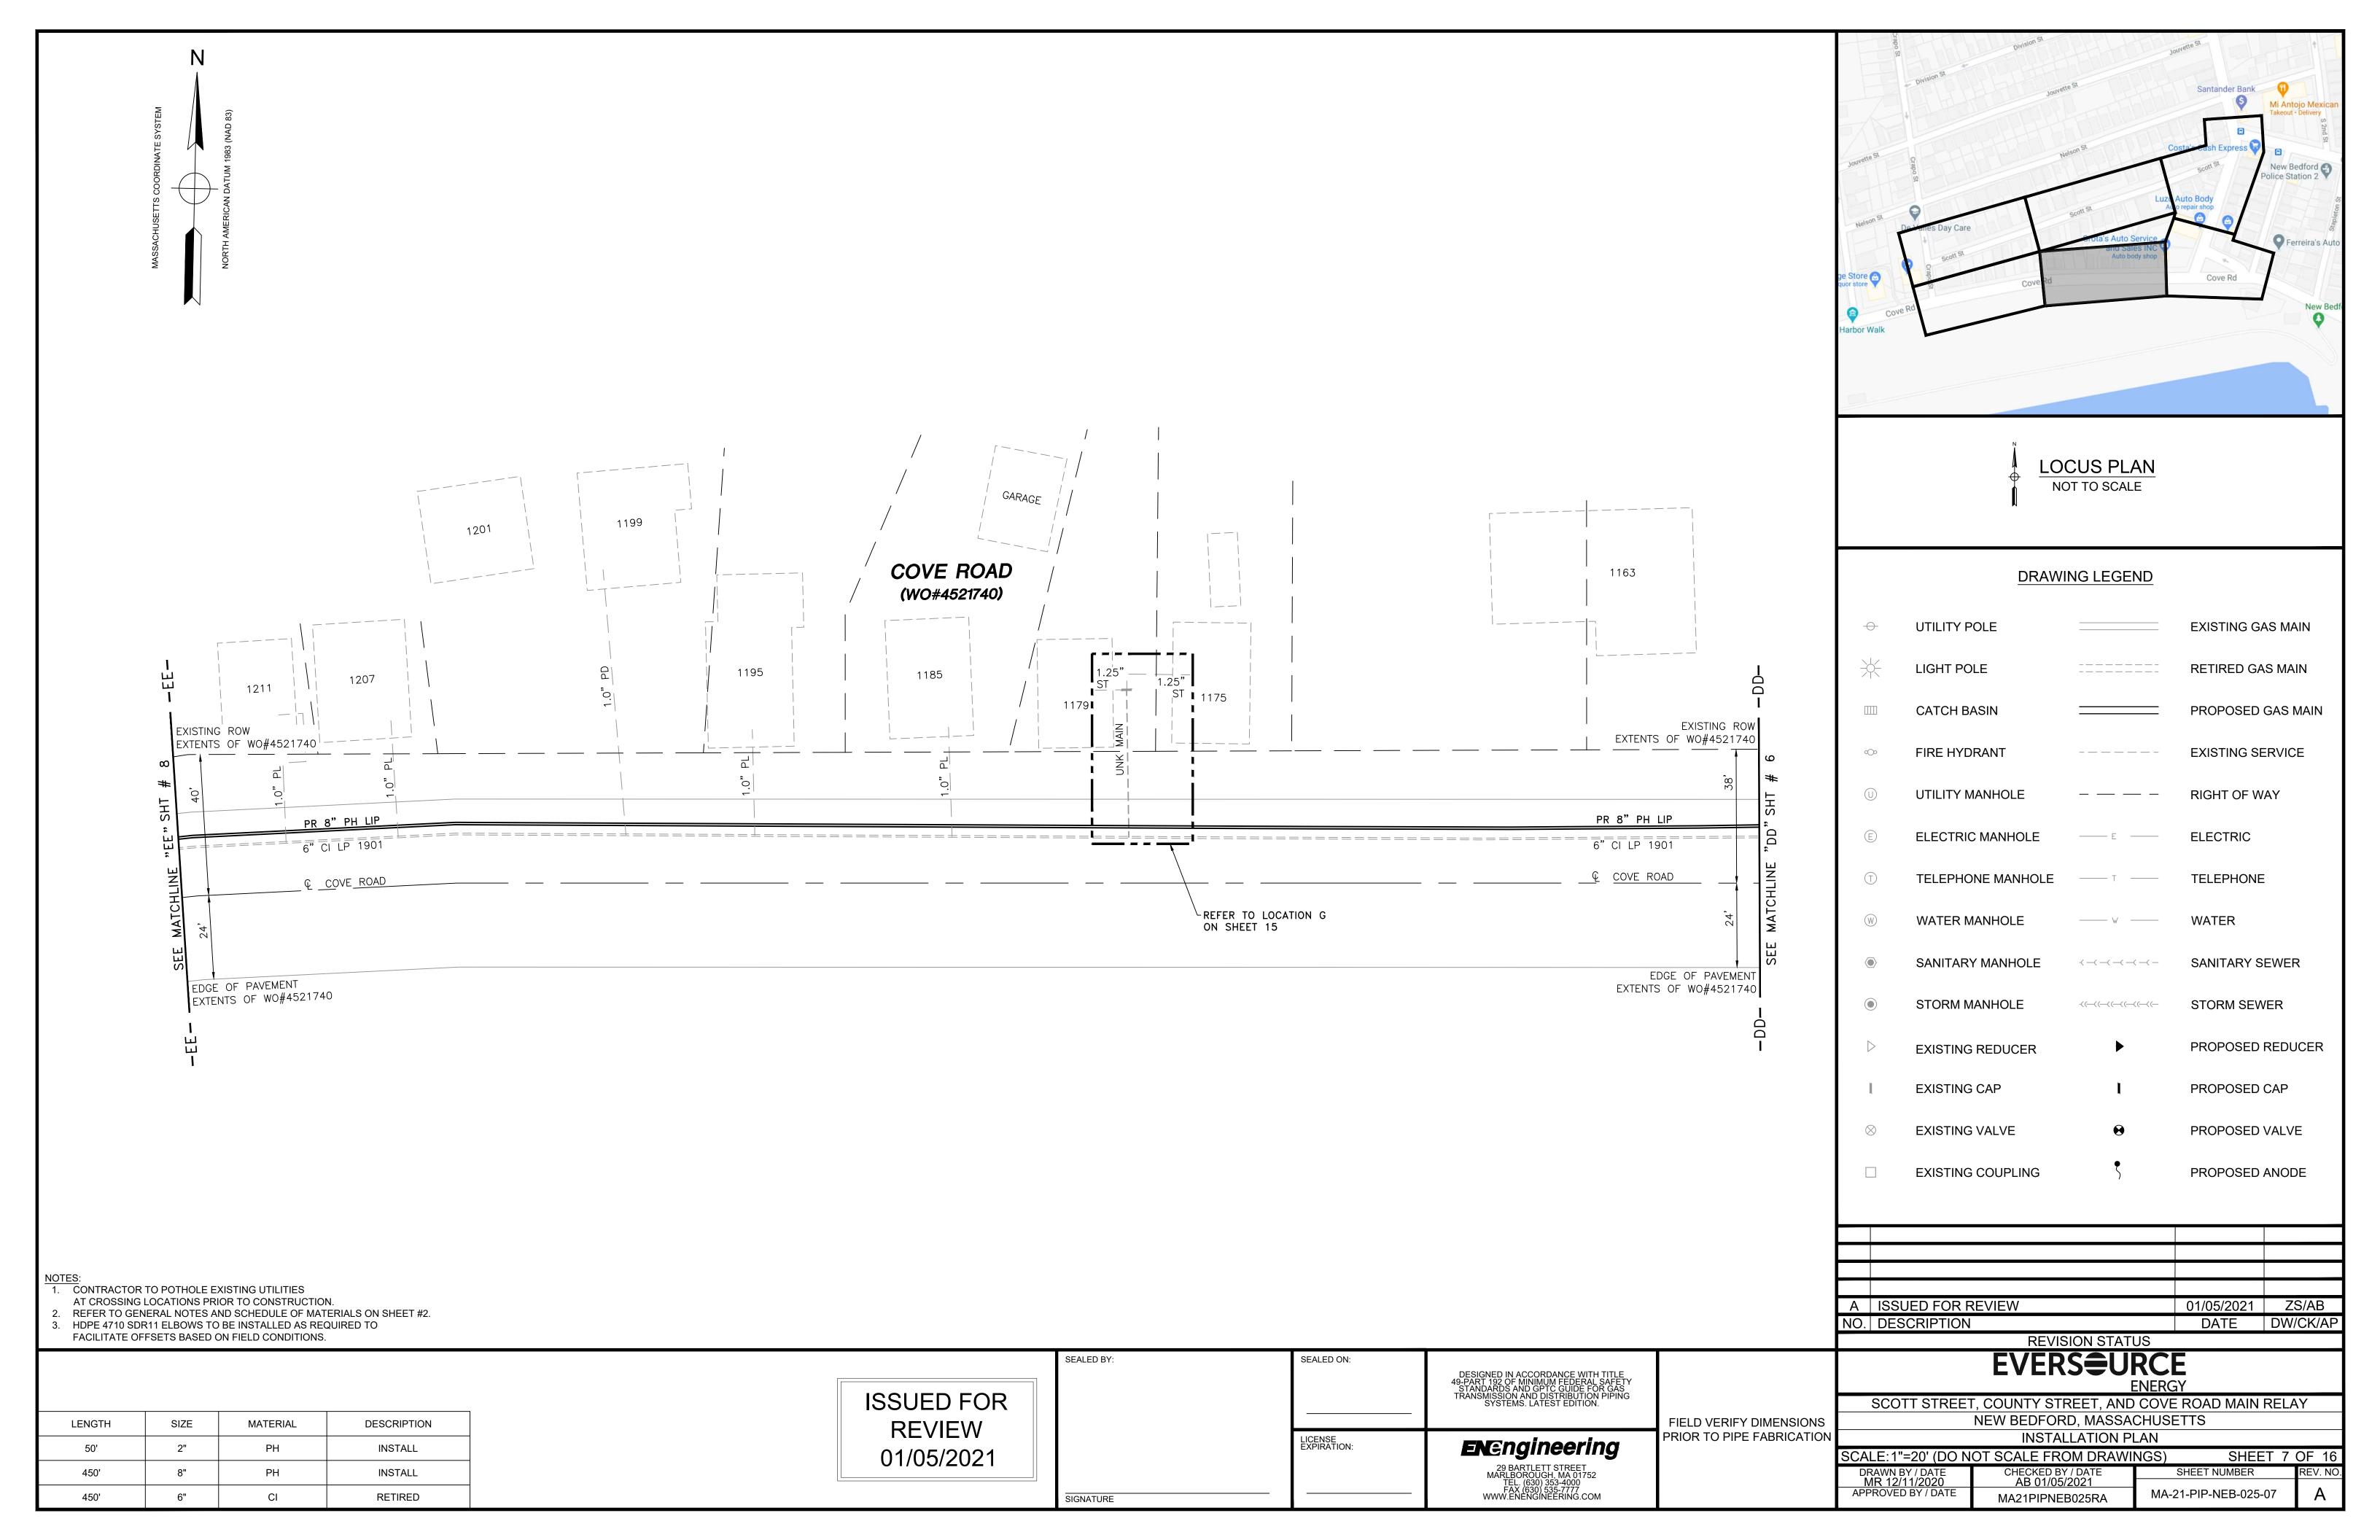
PROPOSED REDUCER


WATER








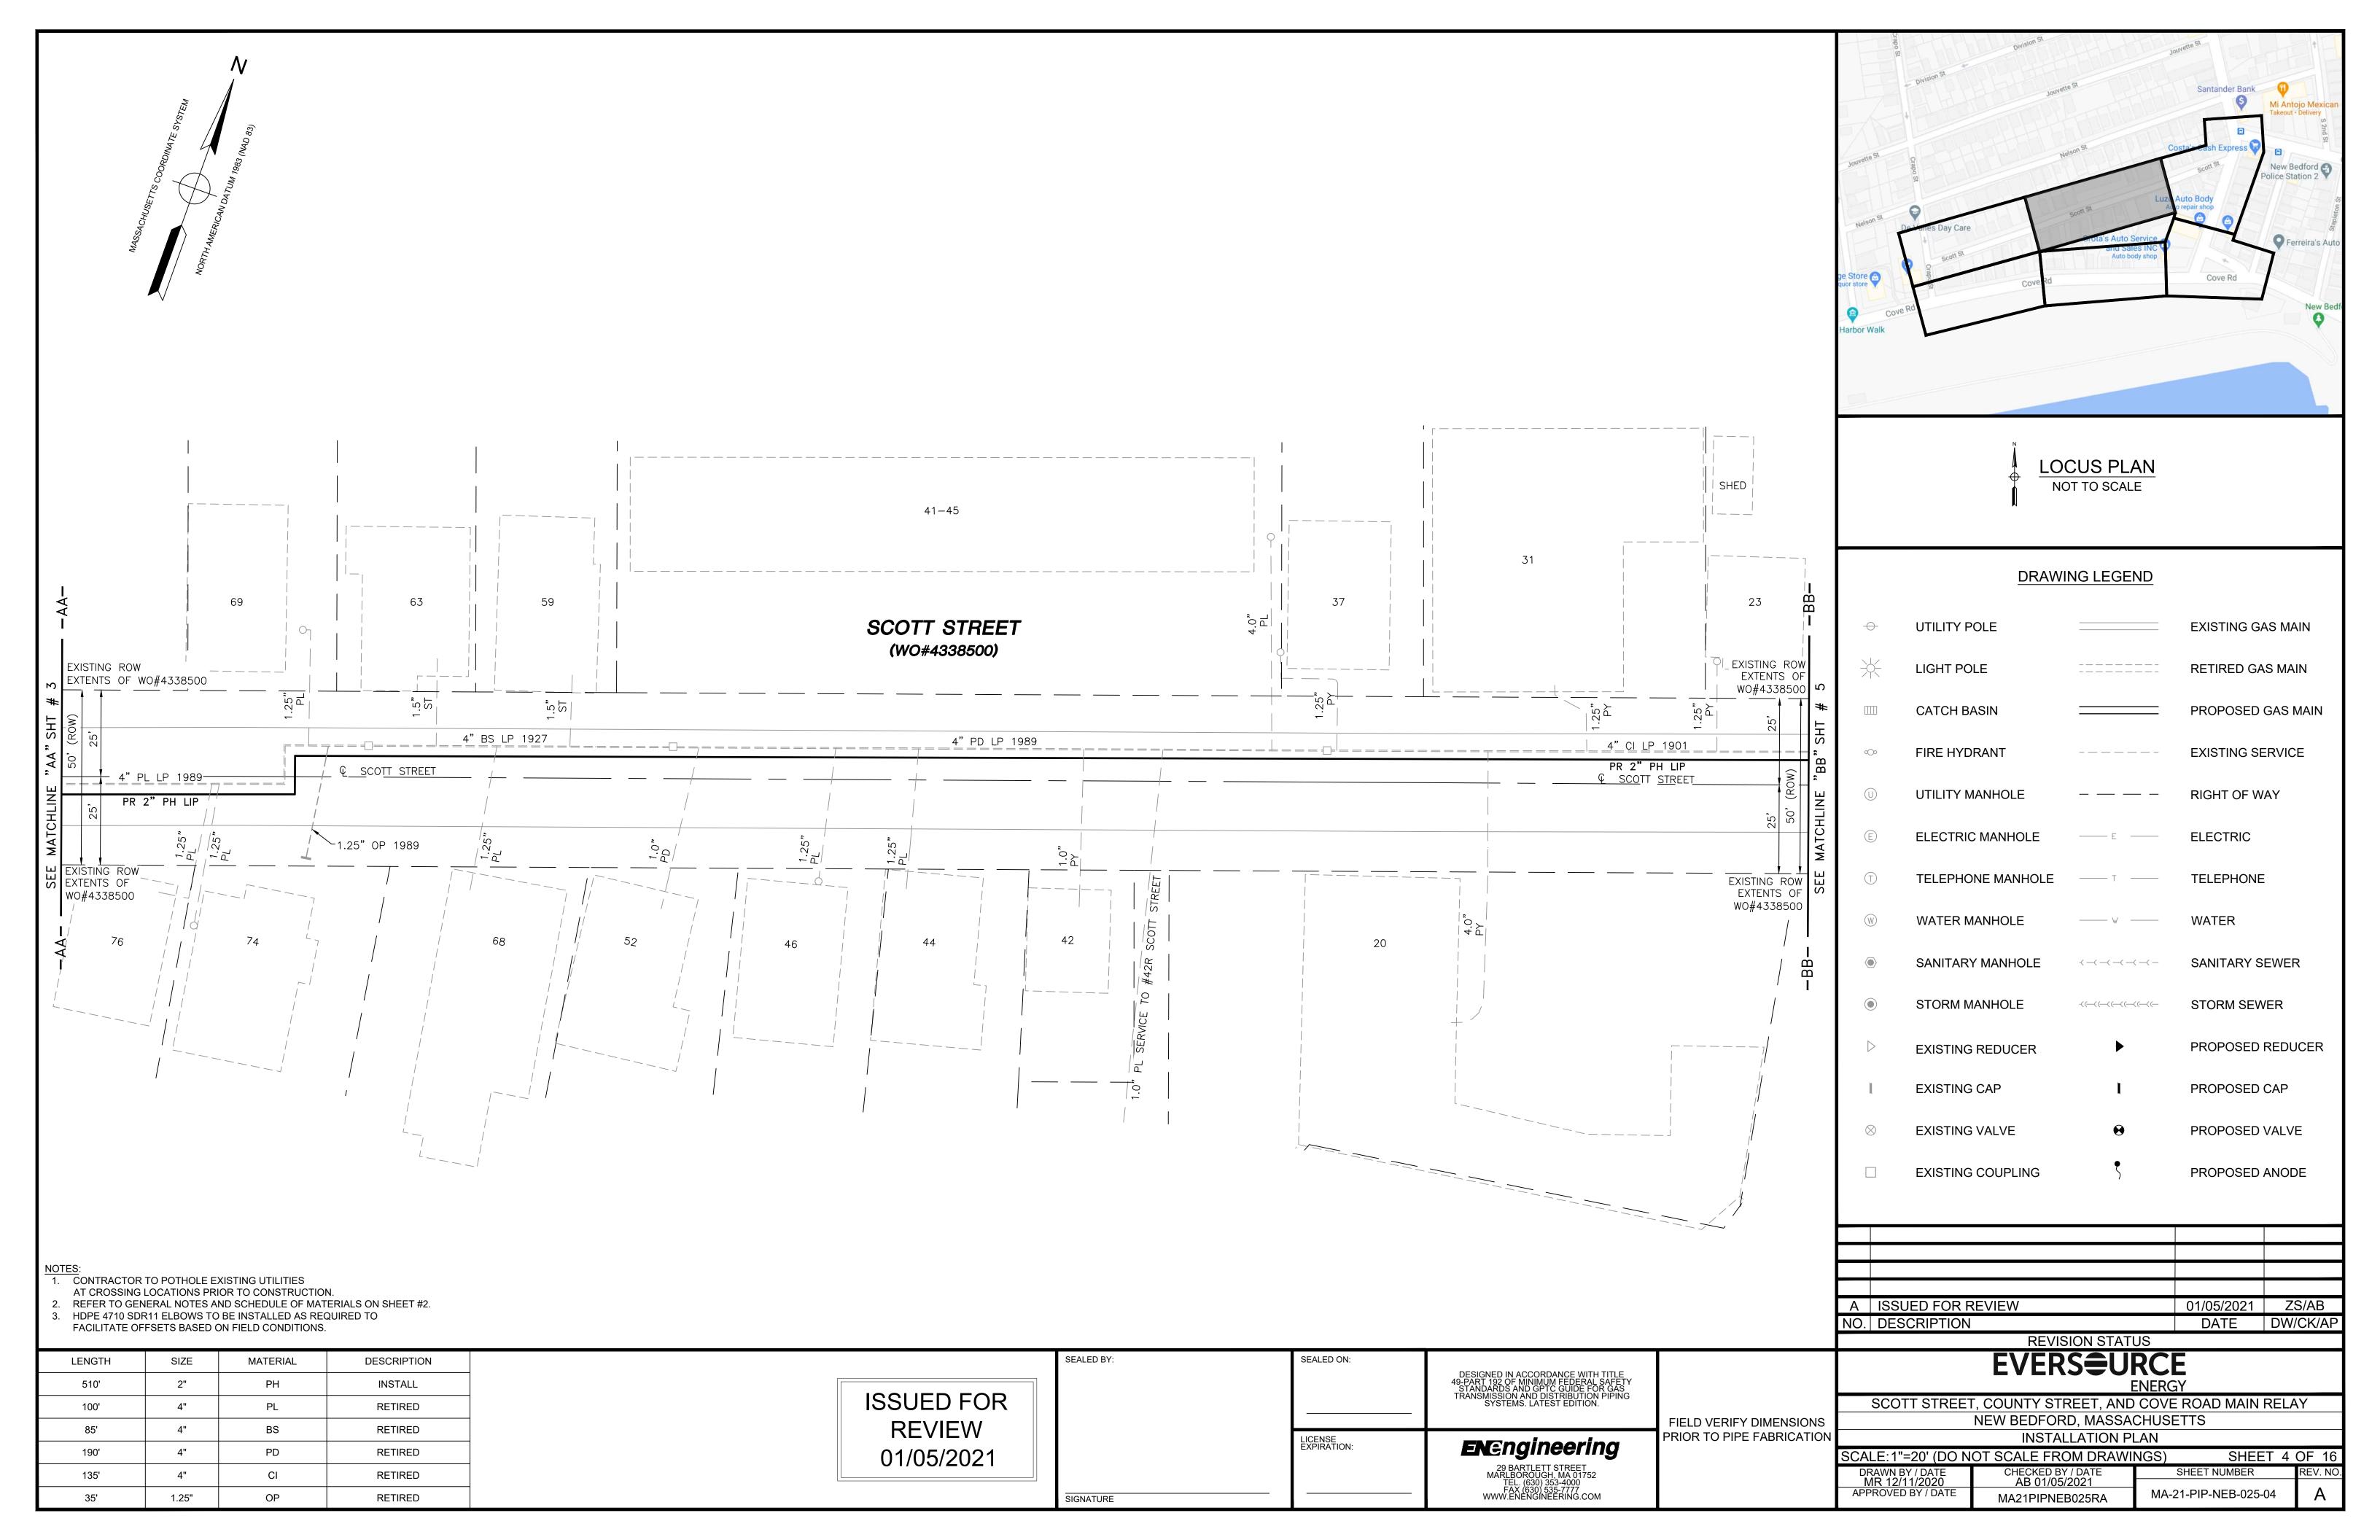

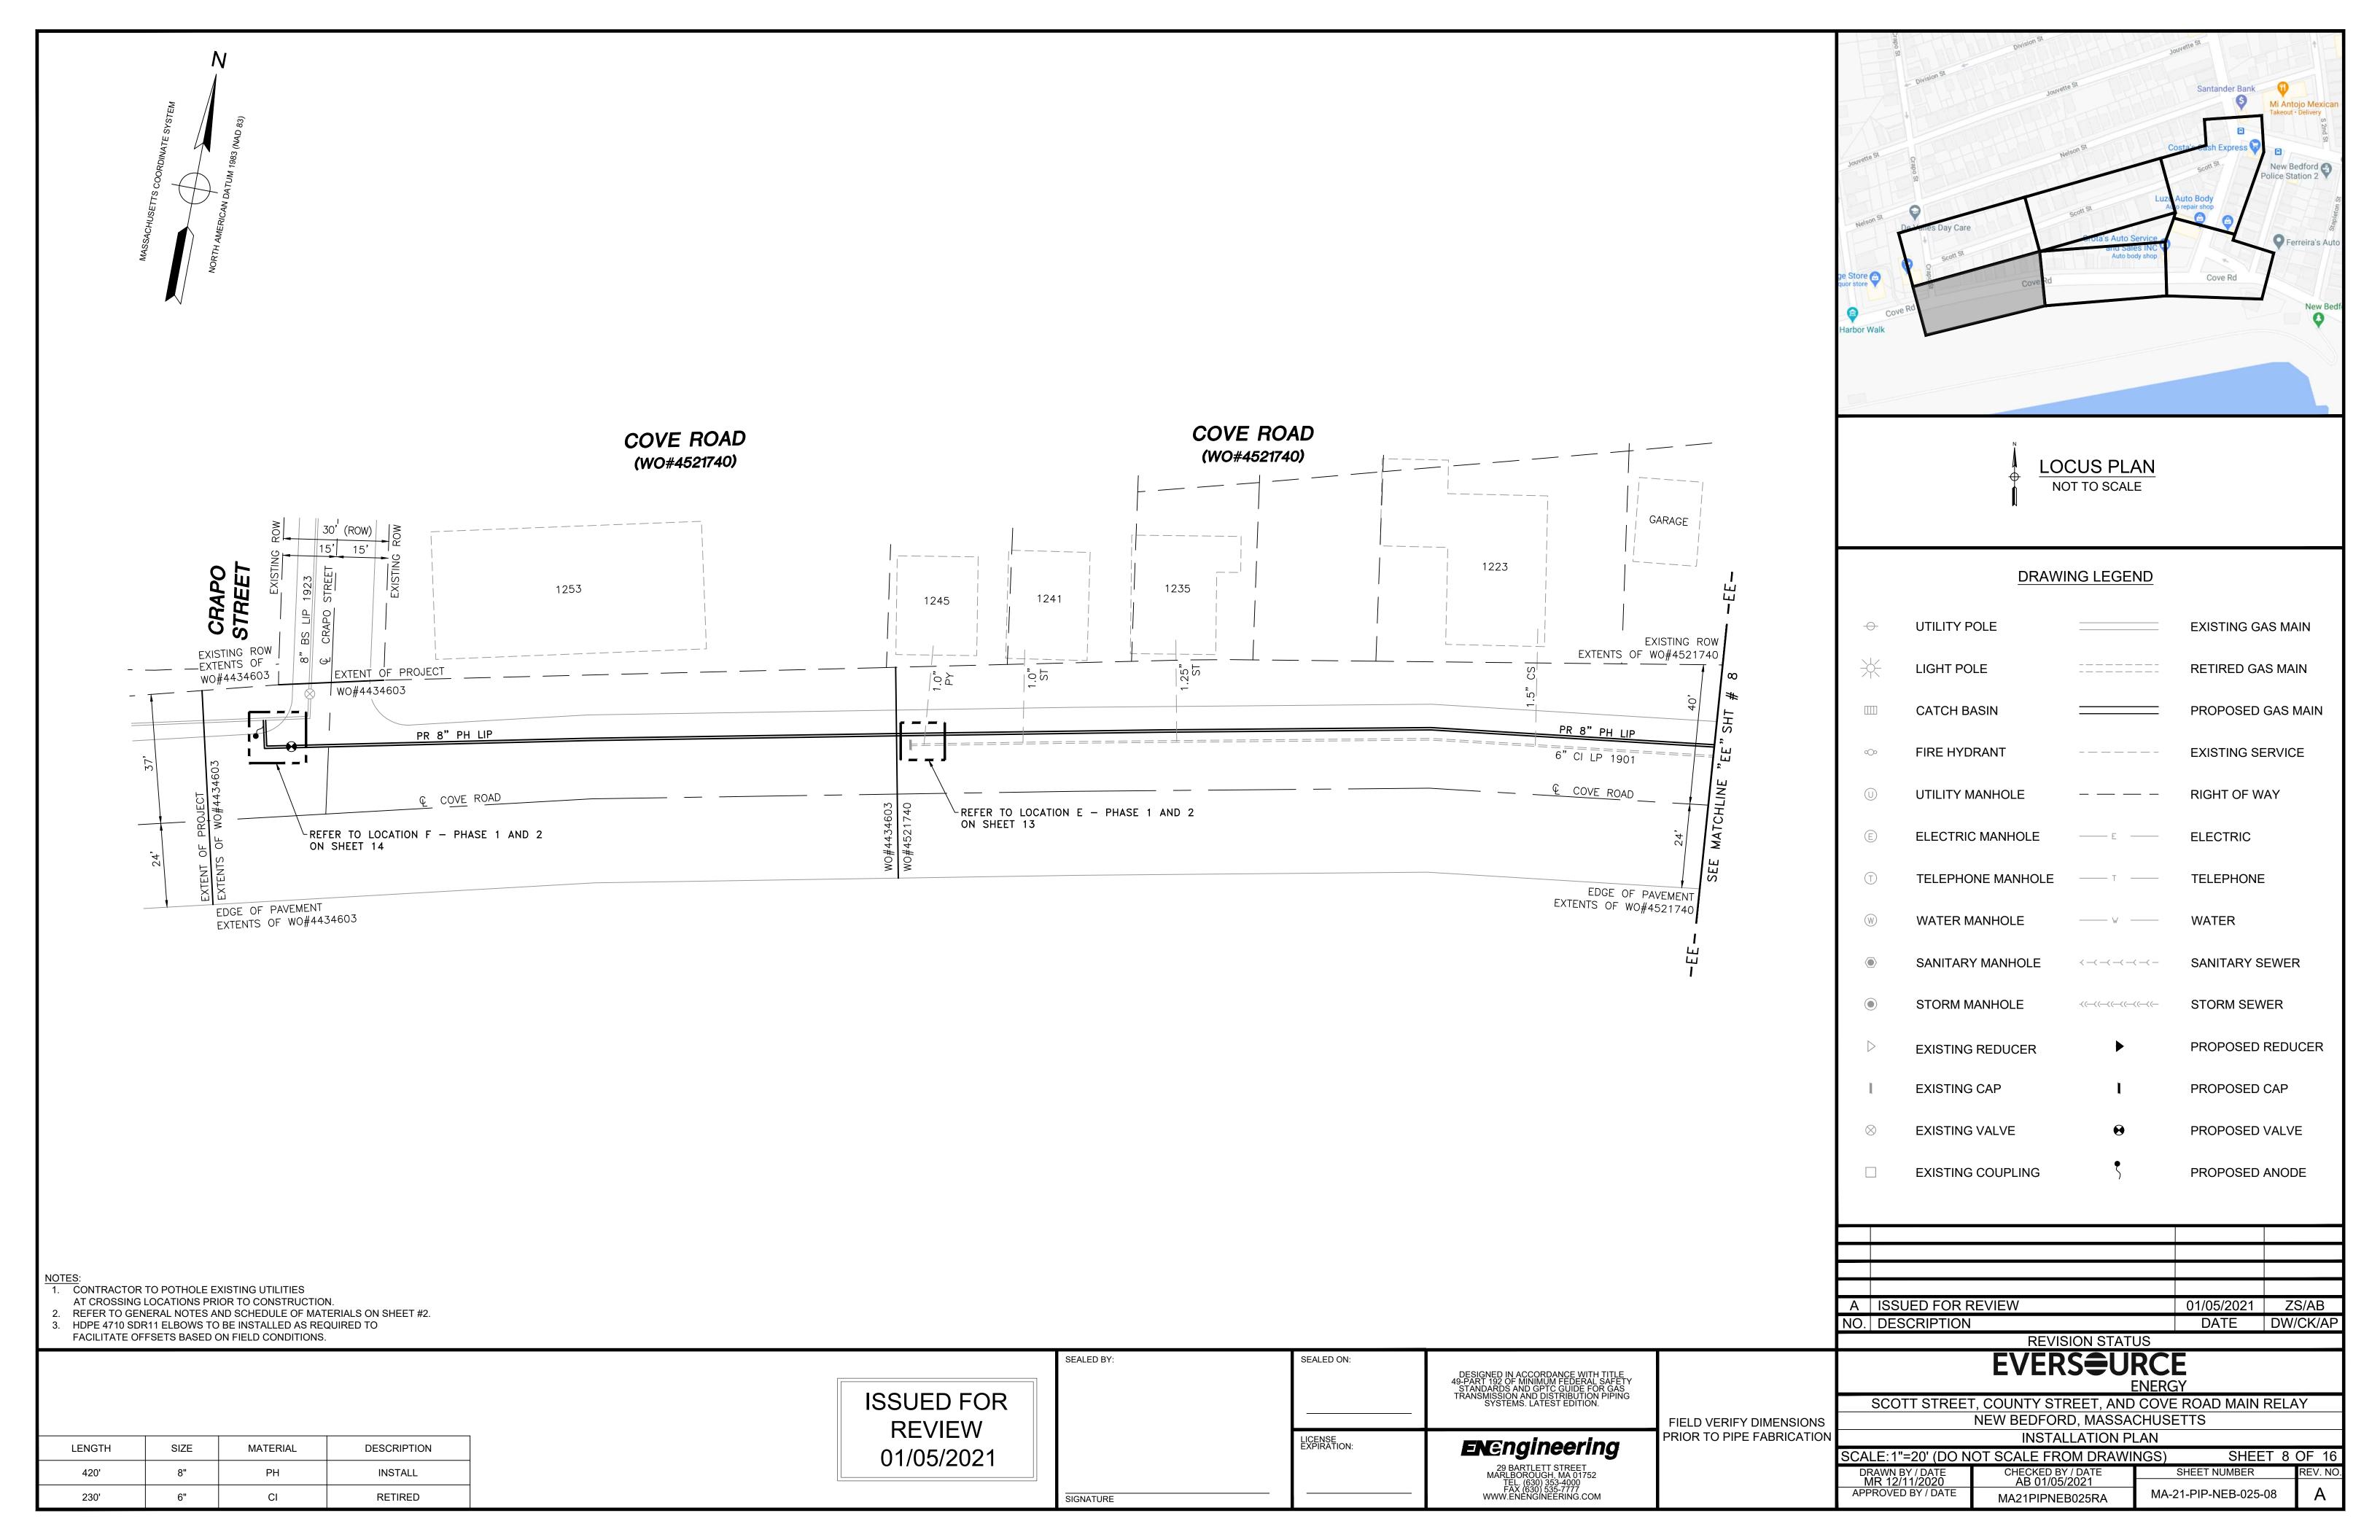

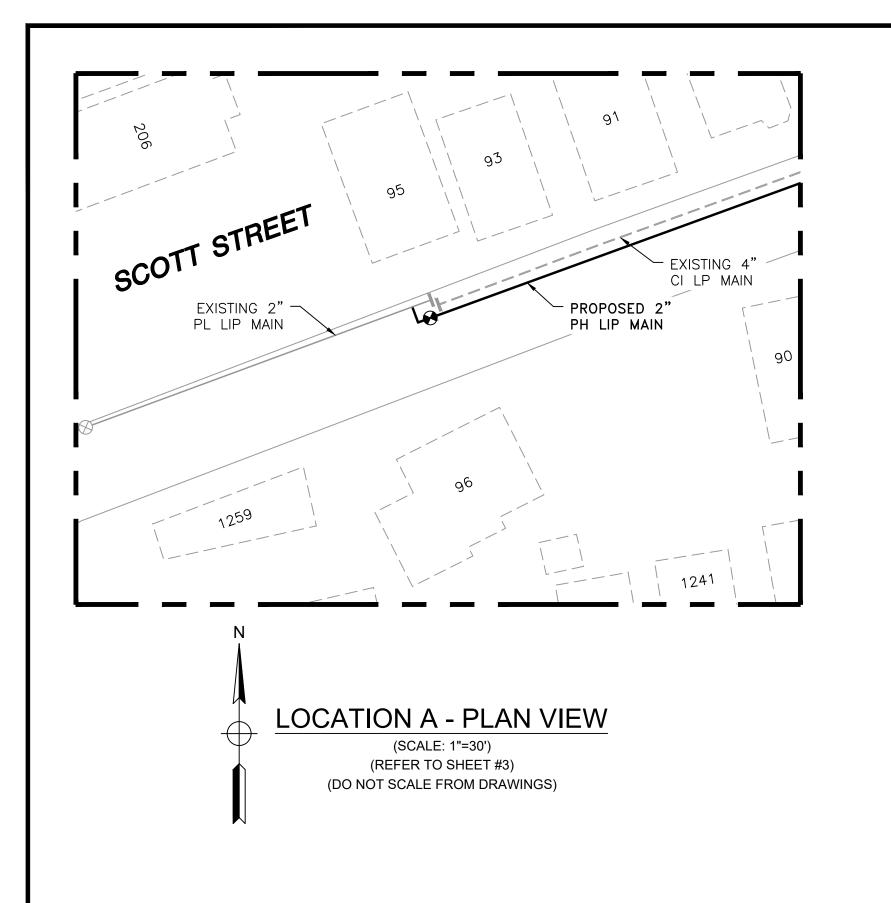



ITEM

6A

91

104

127

170

256

263

270

QTY

AS REQUIRED

20'

AS REQUIRED

SIZE MAXIMO NO.

2"

2" X 1/2"

2" X 1"

2" X 2"

4" x 2"

2"

1/2"

562087

500866


560779

584303

543028

554025

542609

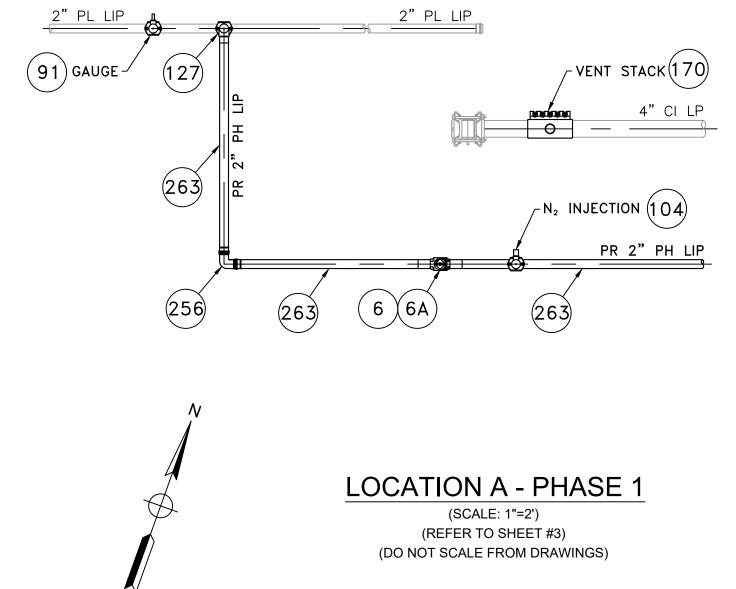

LOCATION A - PHASE 2 (SCALE: 1"=2') (REFER TO SHEET #3) (DO NOT SCALE FROM DRAWINGS)

Α	ISSUED FOR REVIEW	01/05/2021	ZS/AB
NO.	DESCRIPTION	DATE	DW/CK/AP
	REVISION STATUS		

MATERIAL

ASTM D2513

PLASTIC

ASTM D2513

ASTM D2513

ASTM D2513

ASTM D2513

ASTM D2513

ISSUED FOR REVIEW 01/05/2021

SEALED BY:

SIGNATURE

SEALED ON: LICENSE EXPIRATION: **EN**Engineering

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FIELD VERIFY DIMENSIONS PRIOR TO PIPE FABRICATION

PR 2" PH LIP

SCOTT STREET, COUNTY STREET, AND COVE ROAD MAIN RELAY- LOCATION A - SCHEDULE OF MATERIALS

RING, INTERNAL STIFFENER, ASTM D-2513, ASTM F1924. METFIT OR APPROVED EQUAL.

KEROTEST POLYBALL OR APPROVED EQUAL.

F1055. CENTRAL PLASTICS OR APPROVED EQUAL.

F1055. CENTRAL PLASTICS OR APPROVED EQUAL.

APPROVED EQUAL. COMPLETE WITH PLUG.

PERFECTION WITH END CAP OR APPROVED EQUAL.

ASTM F1055. CENTRAL PLASTICS OR APPROVED EQUAL.

BOX, VALVE, PLASTIC, SNAP-ON, ADJ, W/CI NON-LOCKING LID

DESCRIPTION

TAPPING TEE, ELECTROFUSION, IPS X CTS, HDPE 3408/4710, SDR 11, ASTM D2513, ASTM D3350, ASTM D3261 ASTM

TAPPING TEE, ELECTROFUSION, IPS X IPS, HDPE 3408/4710, SDR 11, ASTM D2513, ASTM D3350, ASTM D3261, ASTM

BAND CLAMP, WITH WELDED 2" FNPT SERVICE OUTLET, 304L SS SINGLE SECTION BAND AND GAP BRIDGES, SS STUDS

ELBOW, 90 DEG, MECHANICAL COMPRESSION, SDR 11 IPS, DUPONT ZYTEL ST-801 NYLON BODY, 316 SS COMRESSION ASTM D2513

WITH TEFLON COATED HEX NUTS, COMPLETELY LINED WITH NITRILE RUBBER GASKET. MUELLER 540 SERVI-SEAL OR

END CAP, MECHANICAL STAB, CTS, HDPE, PE 4710/3408, ASTM D2513, WITH SS GRIPPING SUPPORT RING, ACETAL

COLLET AND SPACER RETAINER RING, PE THRUST WASHER, BUNA-N O-RING, ZINC-PLATED CS INSERT STIFFENER,


HV TAPPING TEE, ELECTROFUSION, IPS X IPS, HDPE 3408/4710, SDR 11, ASTM D2513, ASTM D3350, ASTM D3261,


PIPE, IPS, HDPE 3408/4710 SDR 11, ASTM D2513, ASTM D3350, PERFORMANCE PIPE OR APPROVED EQUAL

BALL VALVE, BUTT FUSION, IPS, HDPE 3408/4710, SDR 11, ASTM D2513, ASME B16.40. FULL PORT, 1/4 TURN,


EVERSURCE SCOTT STREET, COUNTY STREET, AND COVE ROAD MAIN RELAY NEW BEDFORD, MASSACHUSETTS

LOCATION A - PHASE 1, 2 AND SCHEDULE OF MATERIALS						
SCALE: AS NOTED		SHEET 9	OF 16			
DRAWN BY / DATE	CHECKED BY / DATE	SHEET NUMBER	REV. NO.			
MR 12/11/2020	AB 01/05/2021					
APPROVED BY / DATE	MA21PIPNEB025RA	MA-21-PIP-NEB-025-09	Α			

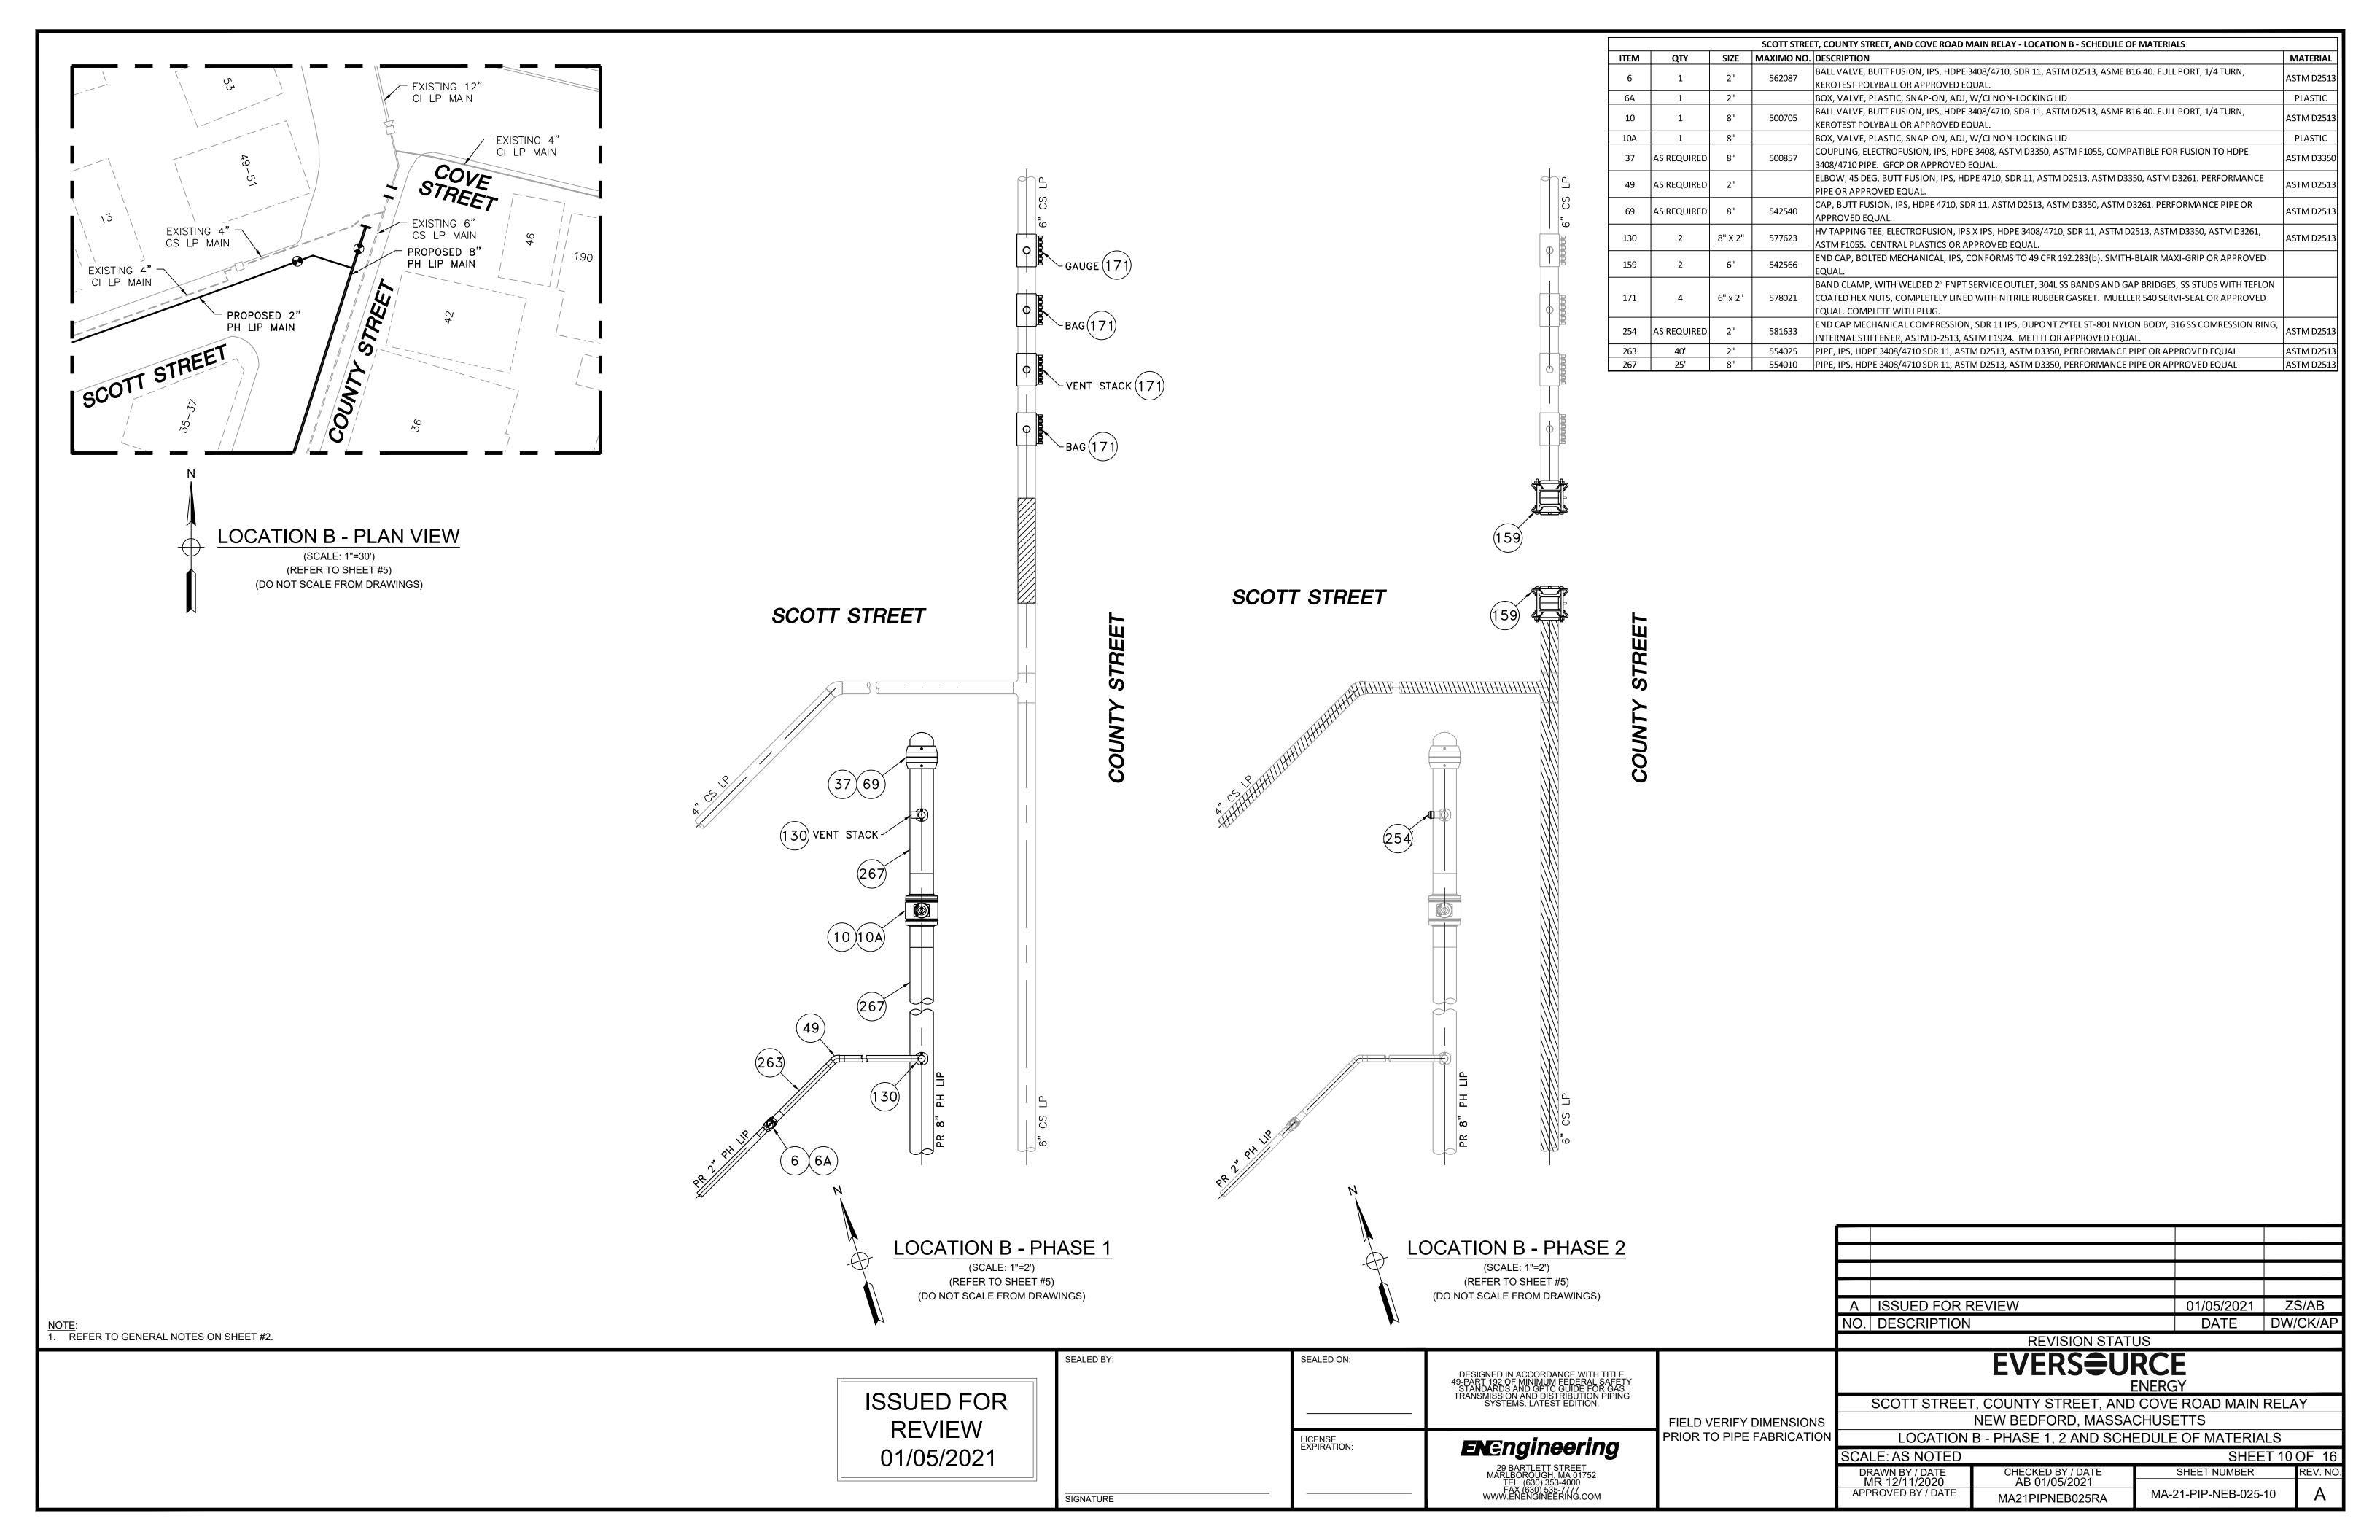

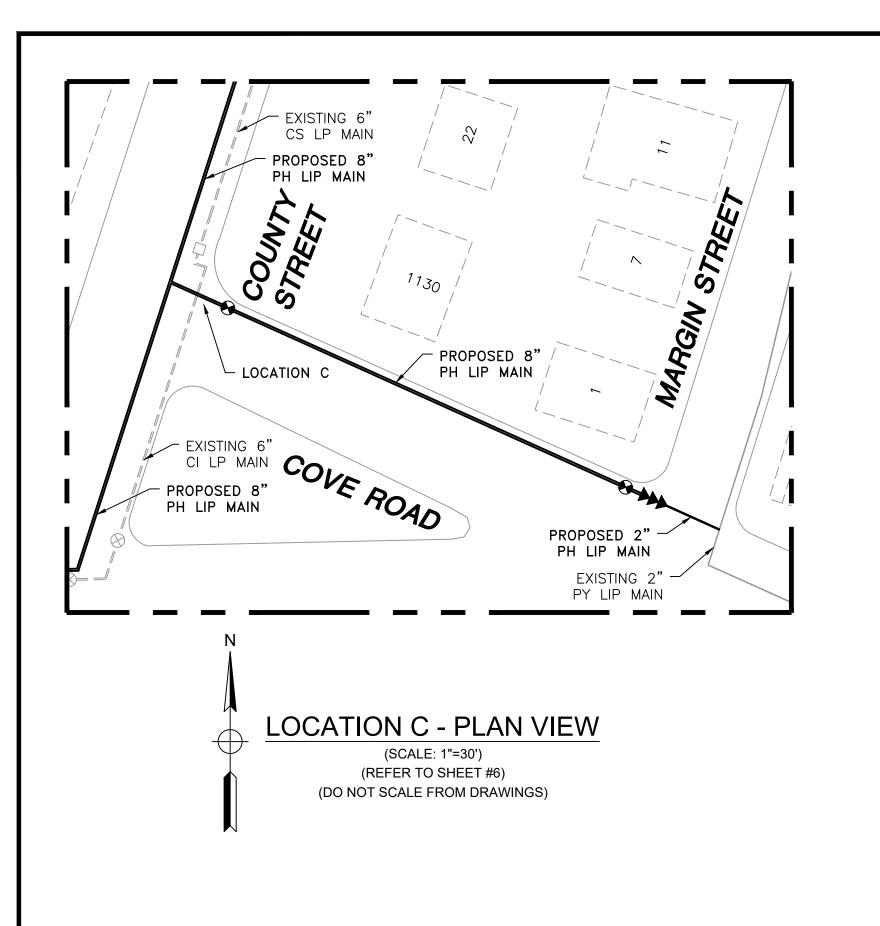

	SCOTT STREET, COUNTY STREET, AND COVE ROAD MAIN RELAY - LOCATION C - SCHEDULE OF MATERIALS					
ITEM QTY SIZE MAXIMO NO. DESCRIPTION MAT		MATERIAL				
10 1 8" 500705	BALL VALVE, BUTT FUSION, IPS, HDPE 3408/4710, SDR 11, ASTM D2513, ASME B16.40. FULL PORT, 1/4 TURN,	ASTM D2513				
		300703	KEROTEST POLYBALL OR APPROVED EQUAL.	7.51111 02515		
10A	1	8"		BOX, VALVE, PLASTIC, SNAP-ON, ADJ, W/CI NON-LOCKING LID	PLASTIC	
76 1 8"	1 2" 560681	560681	TEE, STRAIGHT, BUTT FUSION, IPS, HDPE 4710, SDR 11, ASTM D2513, ASTM D3350, ASTM D3261. PERFORMANCE	ASTM D2513		
	Δ	0	300081	PIPE OR APPROVED EQUAL.	ASTIVIDESIS	
267	40'	8"	554010	PIPE, IPS, HDPE 3408/4710 SDR 11, ASTM D2513, ASTM D3350, PERFORMANCE PIPE OR APPROVED EQUAL	ASTM D2513	

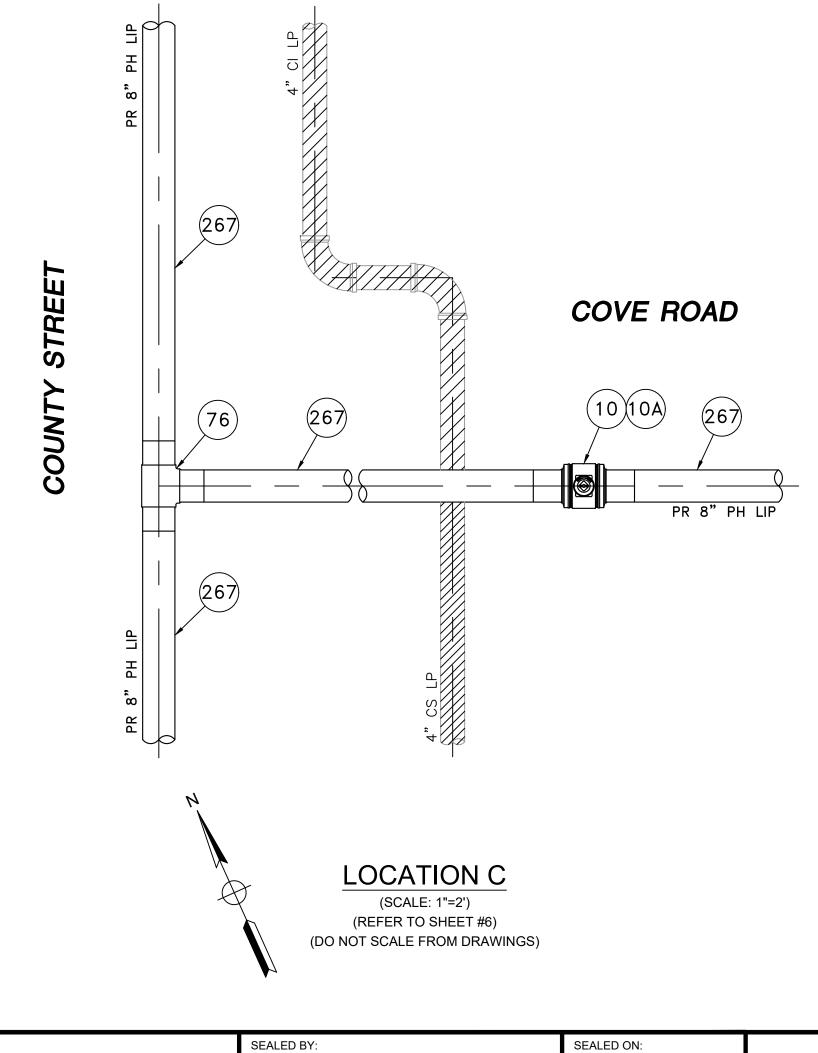

A ISSUED FOR REVIEW 01/05/2021 ZS/AB
NO. DESCRIPTION DATE DW/CK/AP
REVISION STATUS

ISSUED FOR REVIEW 01/05/2021 SIGNATURE

LICENSE EXPIRATION: DESIGNED IN ACCORDANCE WITH TITLE
49-PART 192 OF MINIMUM FEDERAL SAFETY
STANDARDS AND GPTC GUIDE FOR GAS
TRANSMISSION AND DISTRIBUTION PIPING
SYSTEMS. LATEST EDITION.

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29 BARTLETT STREET MARLBOROUGH, MA 01752 TEL. (630) 353-4000 FAX (630) 535-7777 WWW.ENENGINEERING.COM FIELD VERIFY DIMENSIONS
PRIOR TO PIPE FABRICATION


EVERS\(\Display\) ENERGY


SCOTT STREET, COUNTY STREET, AND COVE ROAD MAIN RELAY
NEW BEDFORD, MASSACHUSETTS
LOCATION C AND SCHEDULE OF MATERIALS


 SCALE: AS NOTED
 SHEET 11 OF 16


 DRAWN BY / DATE MR 12/11/2020
 CHECKED BY / DATE AB 01/05/2021
 SHEET NUMBER REV. NO.

 APPROVED BY / DATE APPROVED BY / DATE APPROVED BY / DATE
 MA21PIPNEB025RA
 MA-21-PIP-NEB-025-11
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A ISSUED FOR REVIEW 01/05/2021 ZS/AB NO. DESCRIPTION DATE DW/CK/AI **REVISION STATUS**
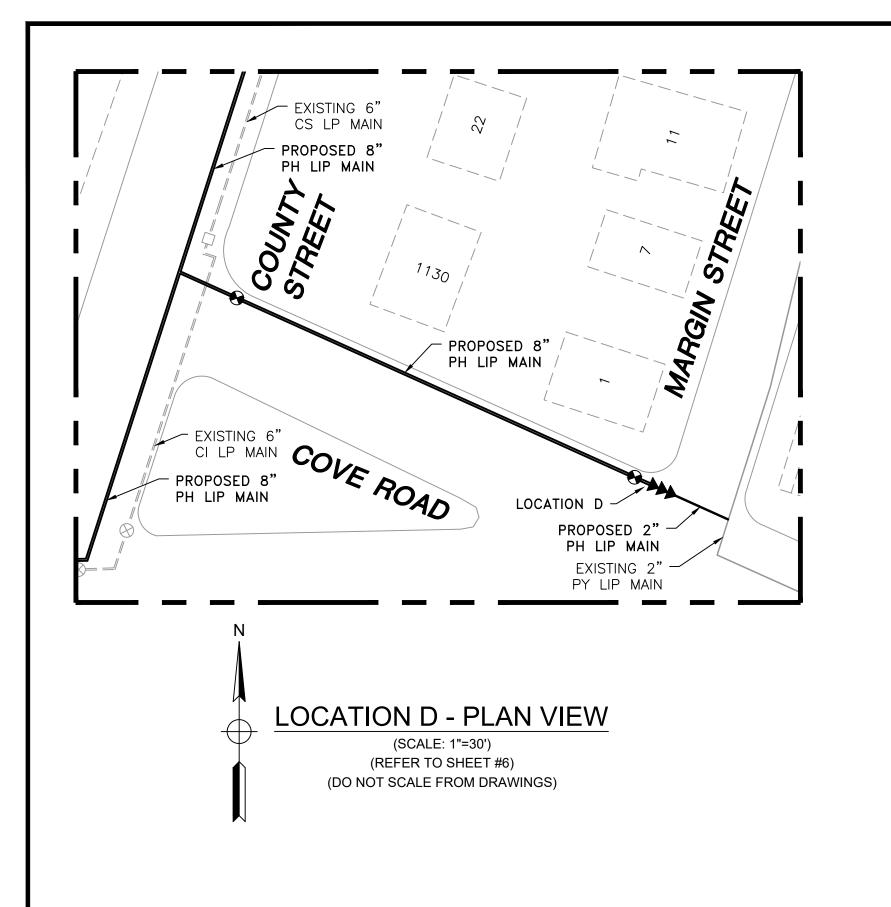
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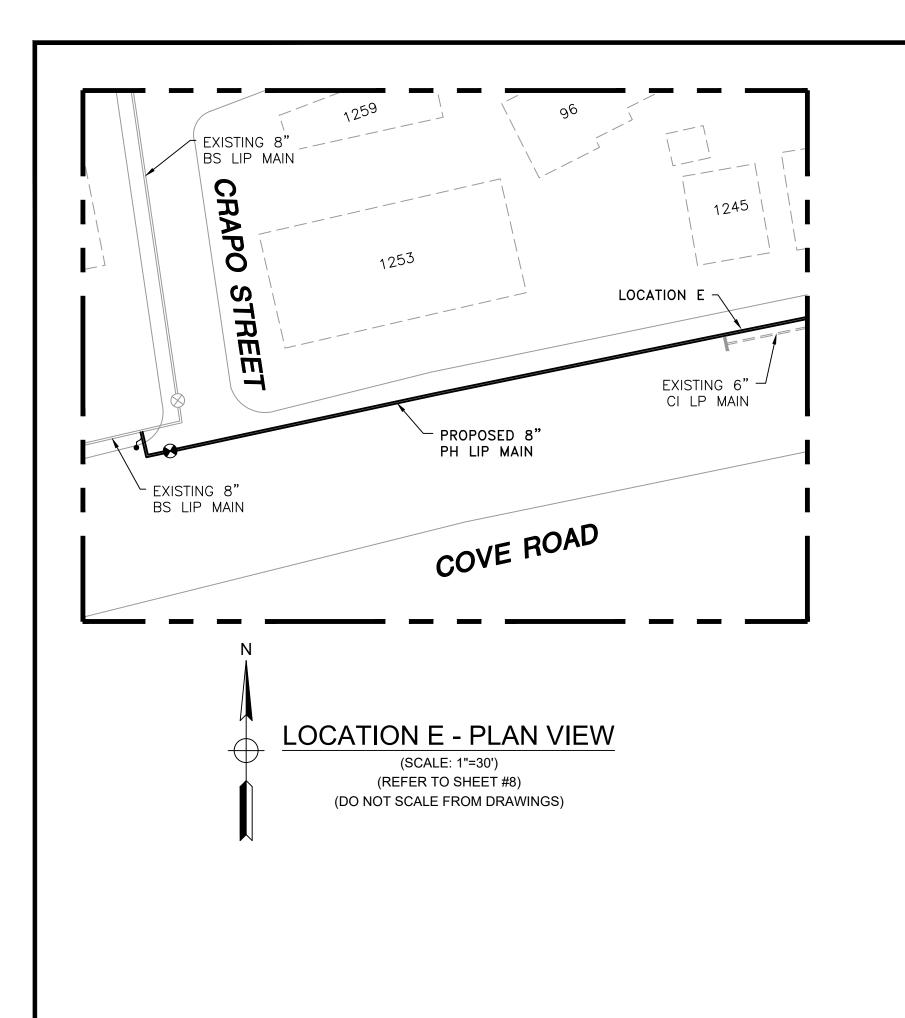
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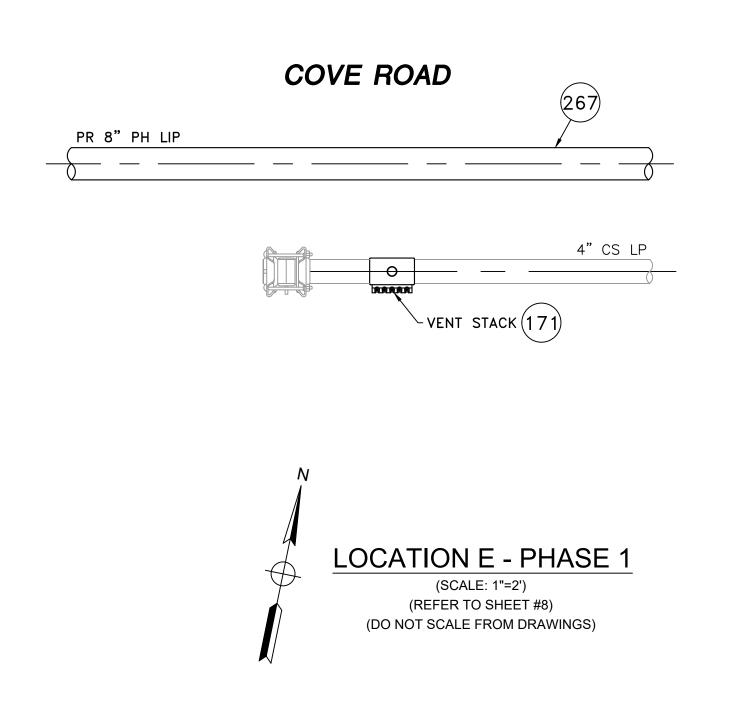
EVERSURCE

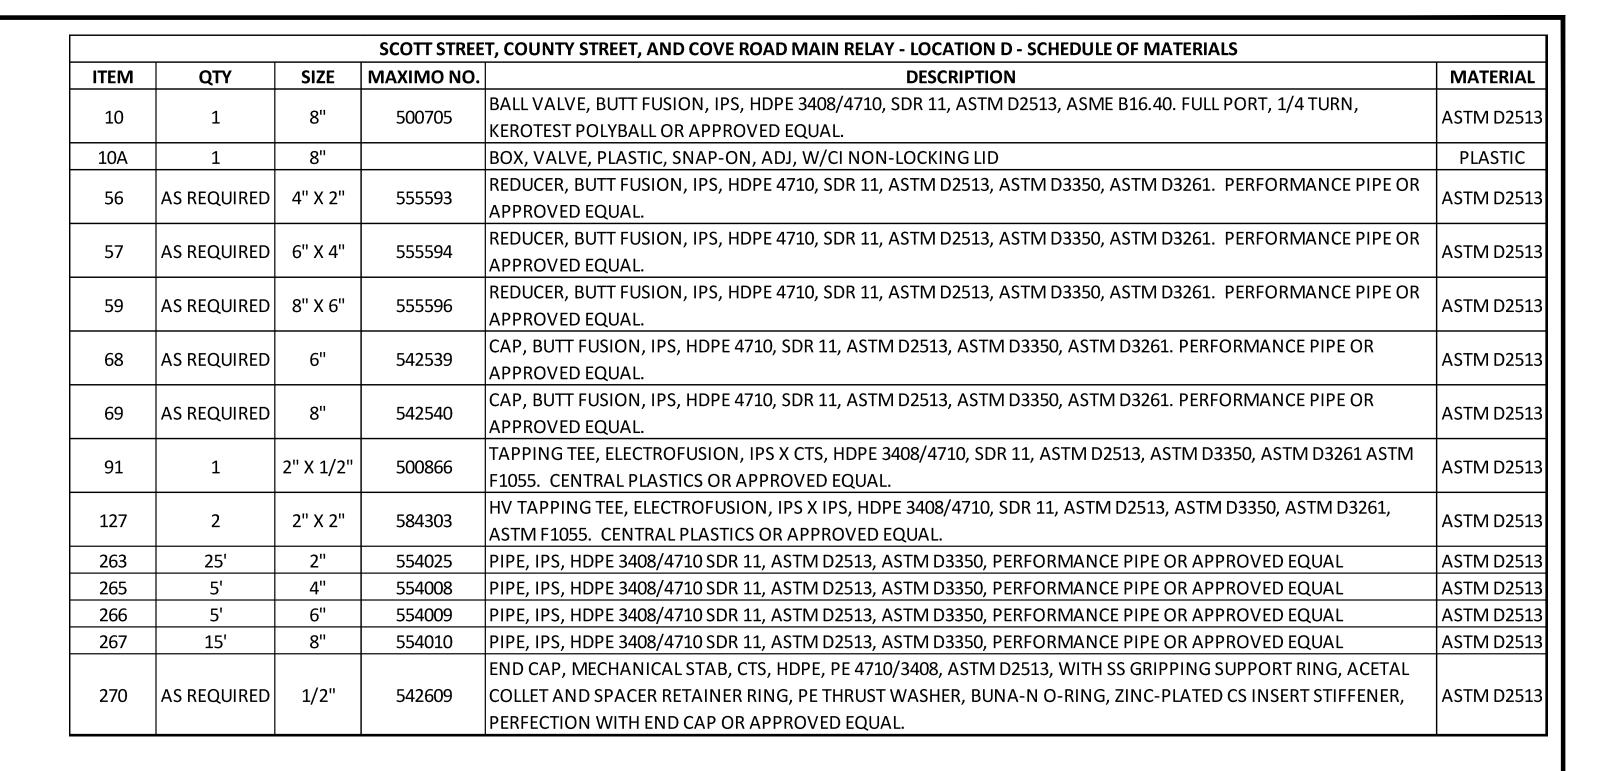MA21PIPNEB025RA

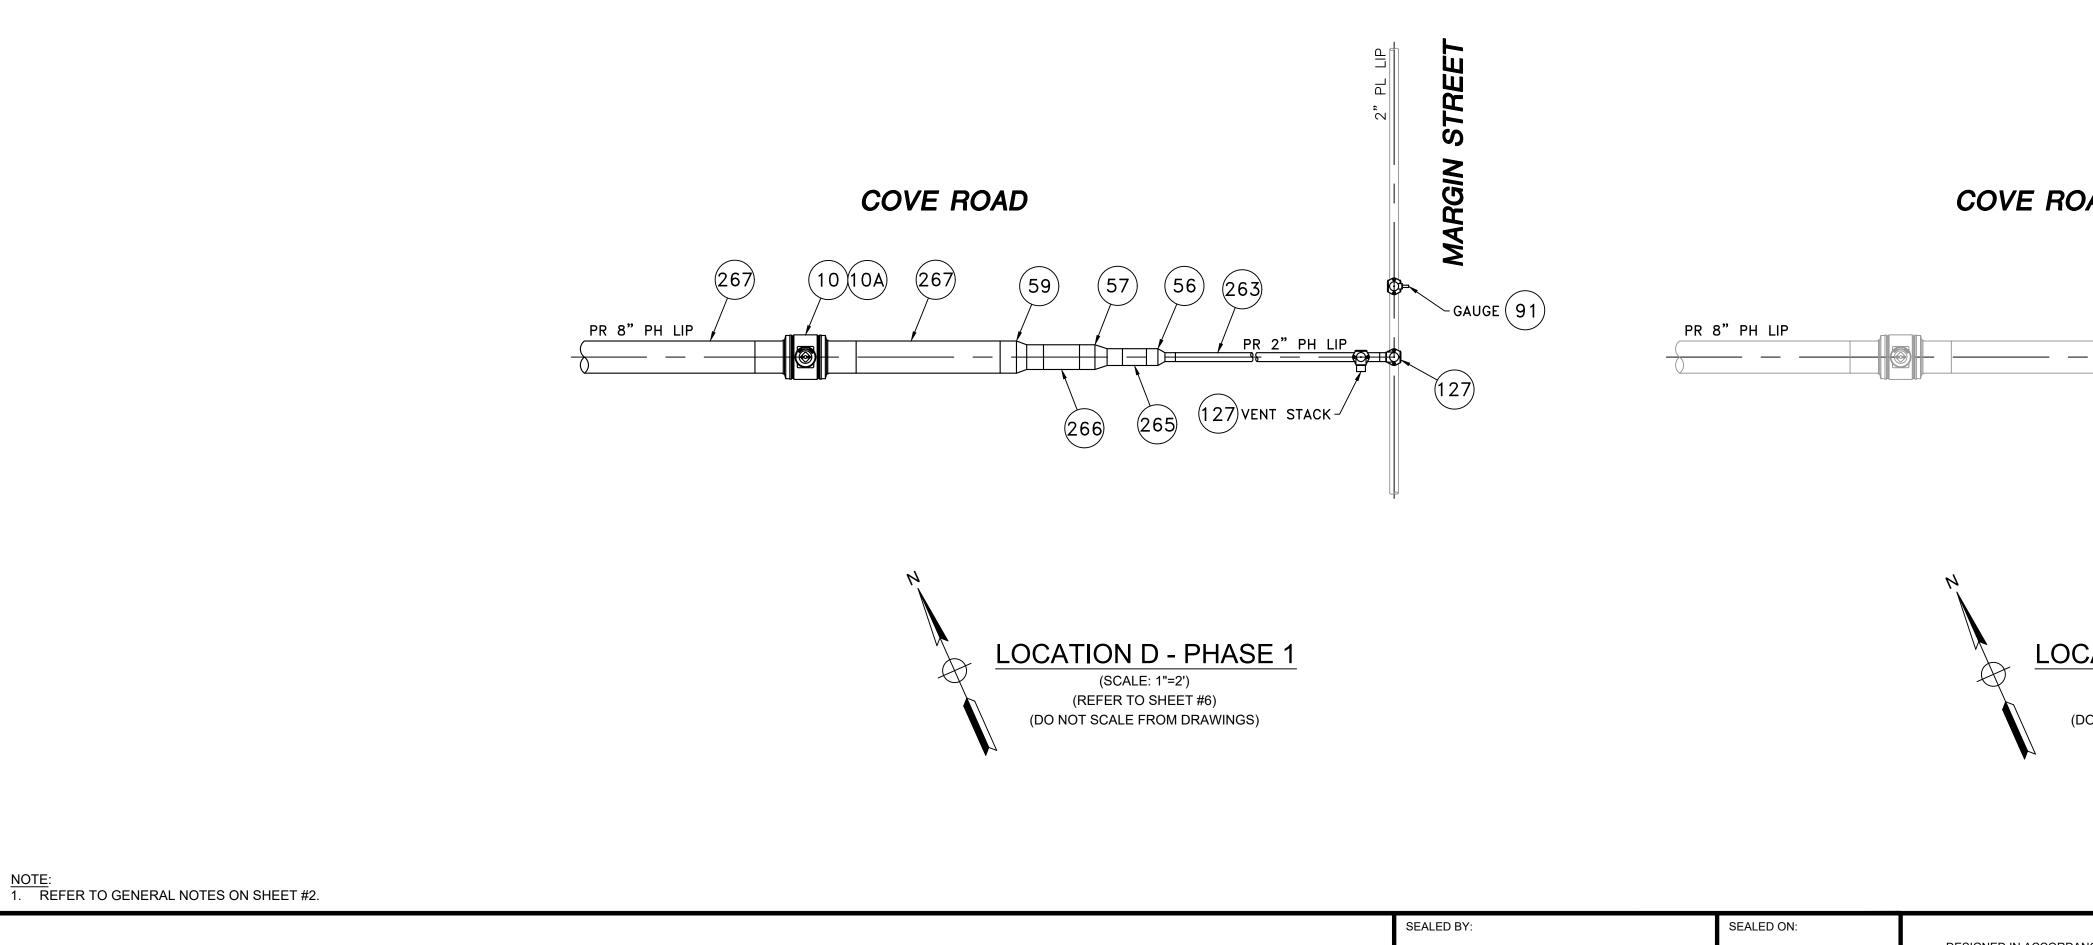SCOTT STREET, COUNTY STREET, AND COVE ROAD MAIN RELAY NEW BEDFORD, MASSACHUSETTS

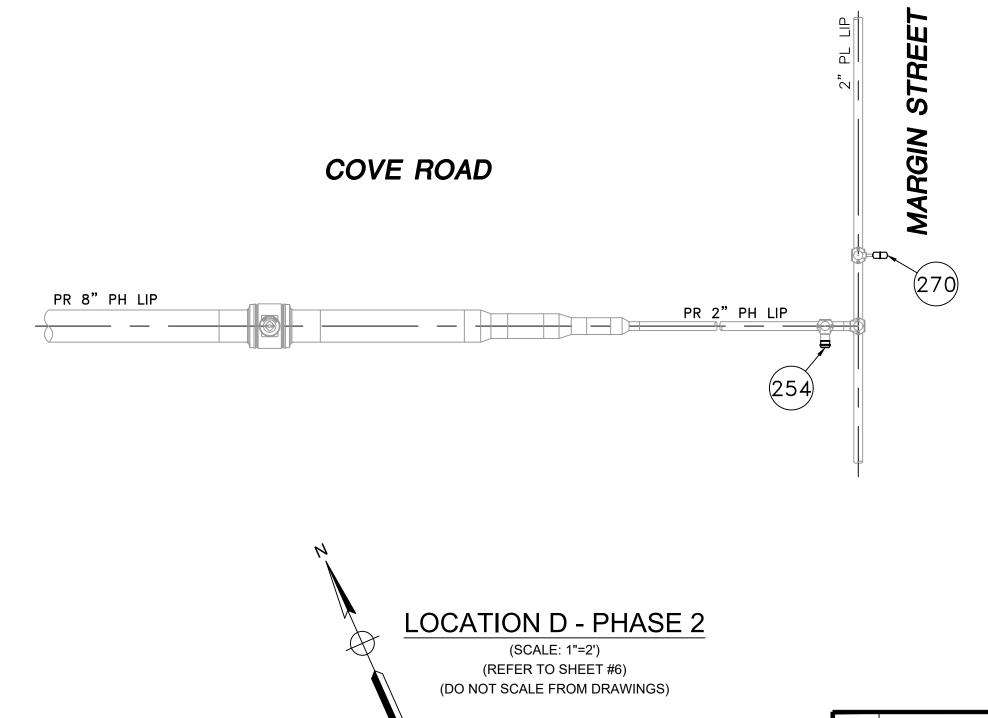LOCATION D - PHASE 1, 2 AND SCHEDULE OF MATERIALS SCALE: AS NOTED SHEET 12 OF 16 SHEET NUMBER CHECKED BY / DATE AB 01/05/2021 MA-21-PIP-NEB-025-12







SCOTT STREET, COUNTY STREET, AND COVE ROAD MAIN RELAY - LOCATION E - SCHEDULE OF MATERIALS					
ITEM	ITEM QTY SIZE MAXIMO NO. DESCRIPTION				MATERIAL
				BAND CLAMP, WITH WELDED 2" FNPT SERVICE OUTLET, 304L SS BANDS AND GAP BRIDGES, SS STUDS WITH TEFLON	
171	1	6" x 2"	578021	COATED HEX NUTS, COMPLETELY LINED WITH NITRILE RUBBER GASKET. MUELLER 540 SERVI-SEAL OR APPROVED	
				EQUAL. COMPLETE WITH PLUG.	
267	15'	8"	554010	PIPE, IPS, HDPE 3408/4710 SDR 11, ASTM D2513, ASTM D3350, PERFORMANCE PIPE OR APPROVED EQUAL	ASTM D2513

COVE ROAD

PR 8" PH LIP

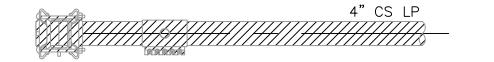

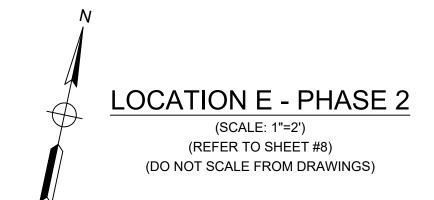

Α	ISSUED FOR REVIEW	01/05/2021	ZS/AB			
NO.	DESCRIPTION	DATE	DW/CK/AP			

REVISION STATUS **EVERS\$\rightarrow\$URCE**

SCOTT STREET, COUNTY STREET, AND COVE ROAD MAIN RELAY NEW BEDFORD, MASSACHUSETTS

LOCATION E - PHASE 1, 2 AND SCHEDULE OF MATERIALS

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SEALED ON:

SEALED BY:

ISSUED FOR


REVIEW

01/05/2021


LICENSE EXPIRATION: **EN**Engineering


FIELD VERIFY DIMENSIONS PRIOR TO PIPE FABRICATION SCALE: AS NOTED


SHEET 13 OF 16 CHECKED BY / DATE AB 01/05/2021 SHEET NUMBER MA-21-PIP-NEB-025-13 MA21PIPNEB025RA

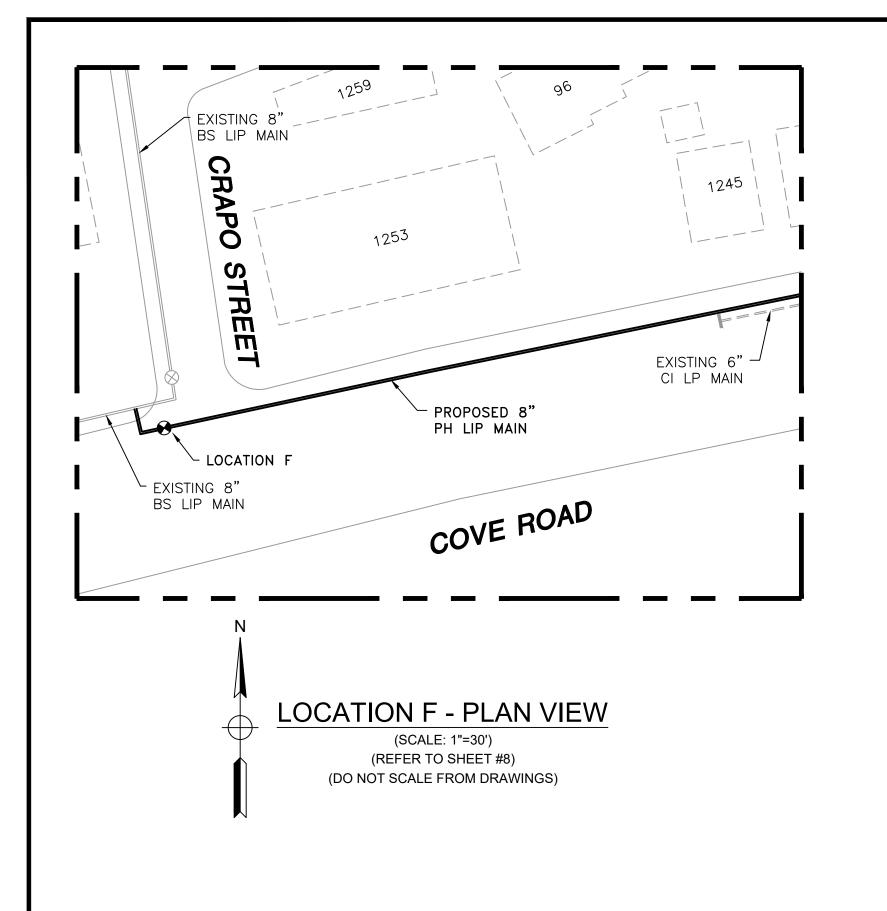



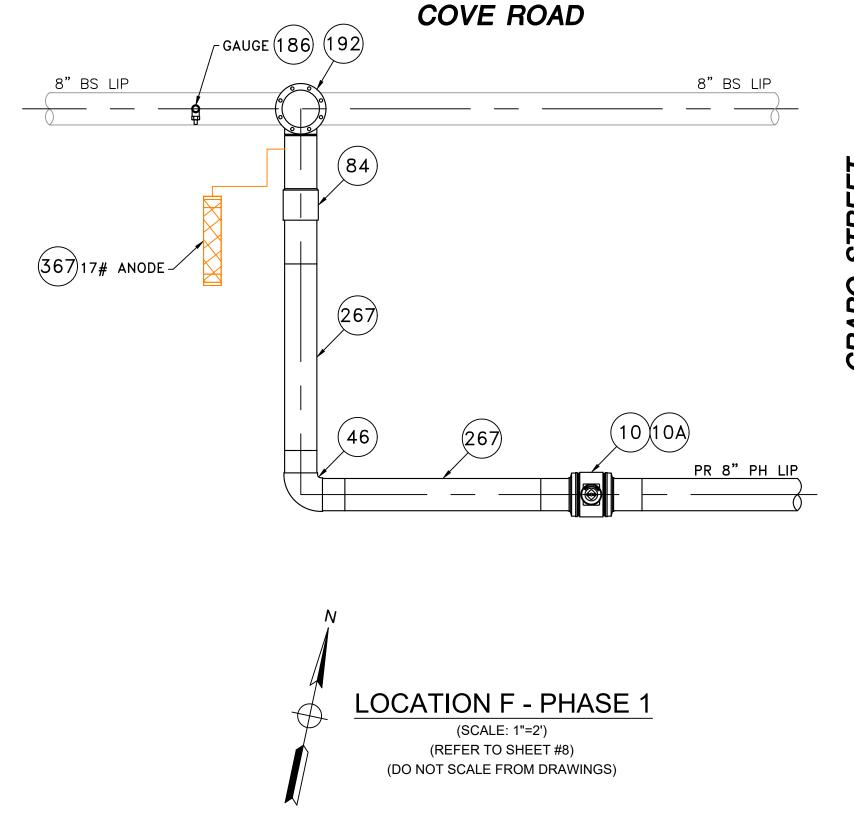

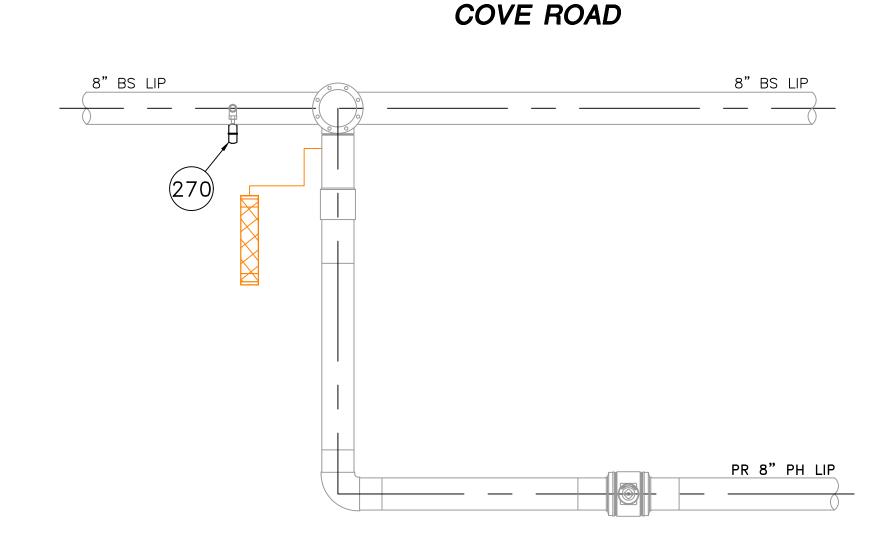

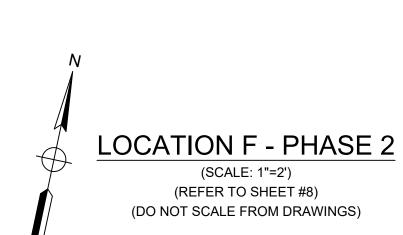

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	REVISION STATUS							

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ISSUED FOR REVIEW 01/05/2021

SEALED BY:

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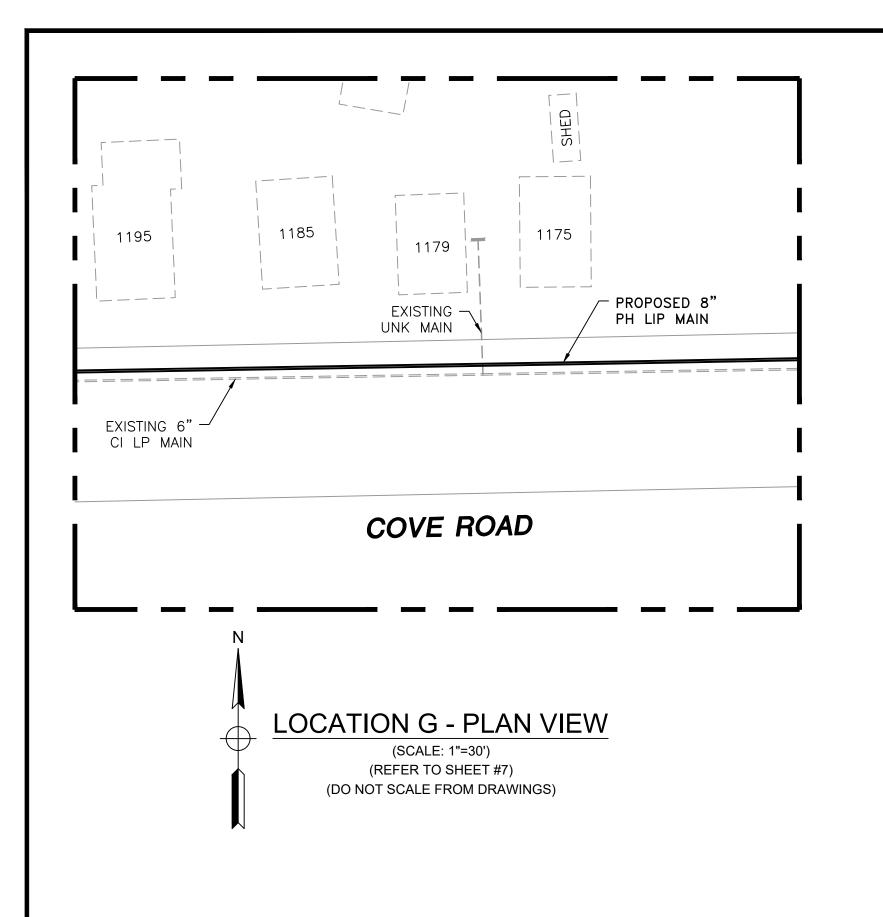
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FIELD VERIFY DIMENSIONS PRIOR TO PIPE FABRICATION


SCOTT STREET, COUNTY STREET, AND COVE ROAD MAIN RELAY NEW BEDFORD, MASSACHUSETTS

MA21PIPNEB025RA

LOCATION F - PHASE 1, 2 AND SCHEDULE OF MATERIALS SCALE: AS NOTED SHEET 14 OF 16 SHEET NUMBER MA-21-PIP-NEB-025-14



SCOTT STREET, COUNTY STREET, AND COVE ROAD MAIN RELAY - LOCATION G - SCHEDULE OF MATERIALS					
ITEM	ITEM QTY SIZE MAXIMO NO. DESCRIPTION			MATERIAL	
267	30'	8"	554010	PIPE, IPS, HDPE 3408/4710 SDR 11, ASTM D2513, ASTM D3350, PERFORMANCE PIPE OR APPROVED EQUAL	ASTM D2513
				BAND CLAMP, WITH WELDED 1" FNPT SERVICE OUTLET, 304L SS SINGLE SECTION BAND AND GAP BRIDGES, SS STUDS	
279	1	2" X 1"	543034	WITH TEFLON COATED HEX NUTS, COMPLETELY LINED WITH NITRILE RUBBER GASKET. MUELLER 540 SERVI-SEAL OR	
				APPROVED EQUAL. COMPLETE WITH PLUG.	

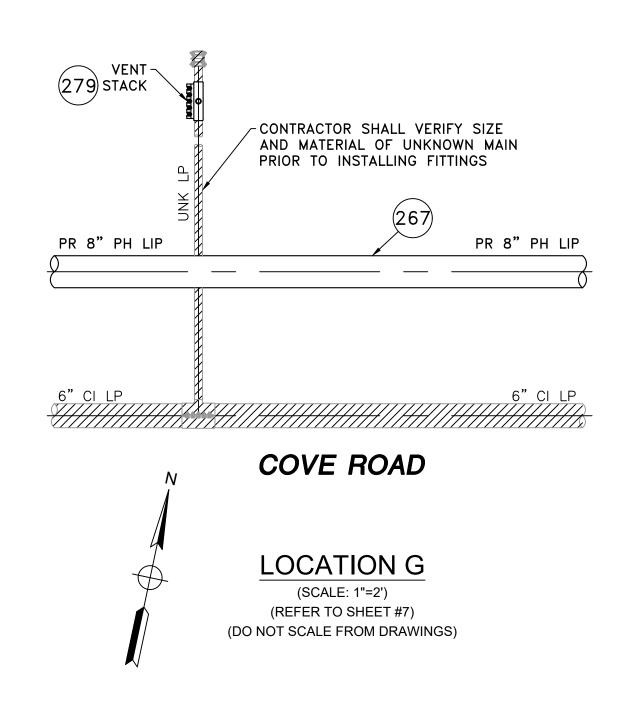

SEALED BY:

SIGNATURE

ISSUED FOR

REVIEW

01/05/2021

SEALED ON:

LICENSE EXPIRATION:

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