


EVERSEURCE ENERGY

LUCAS STREET MAIN RELAY INSTALLATION OF 1250' OF 4" PH LIP GAS MAIN LUCAS STREET NEW BEDFORD, MASSACHUSETTS ENE PROJECT #: 2005881.07 EVERSOURCE PROJECT #: 4128130




LOCUS PLAN NOT TO SCALE

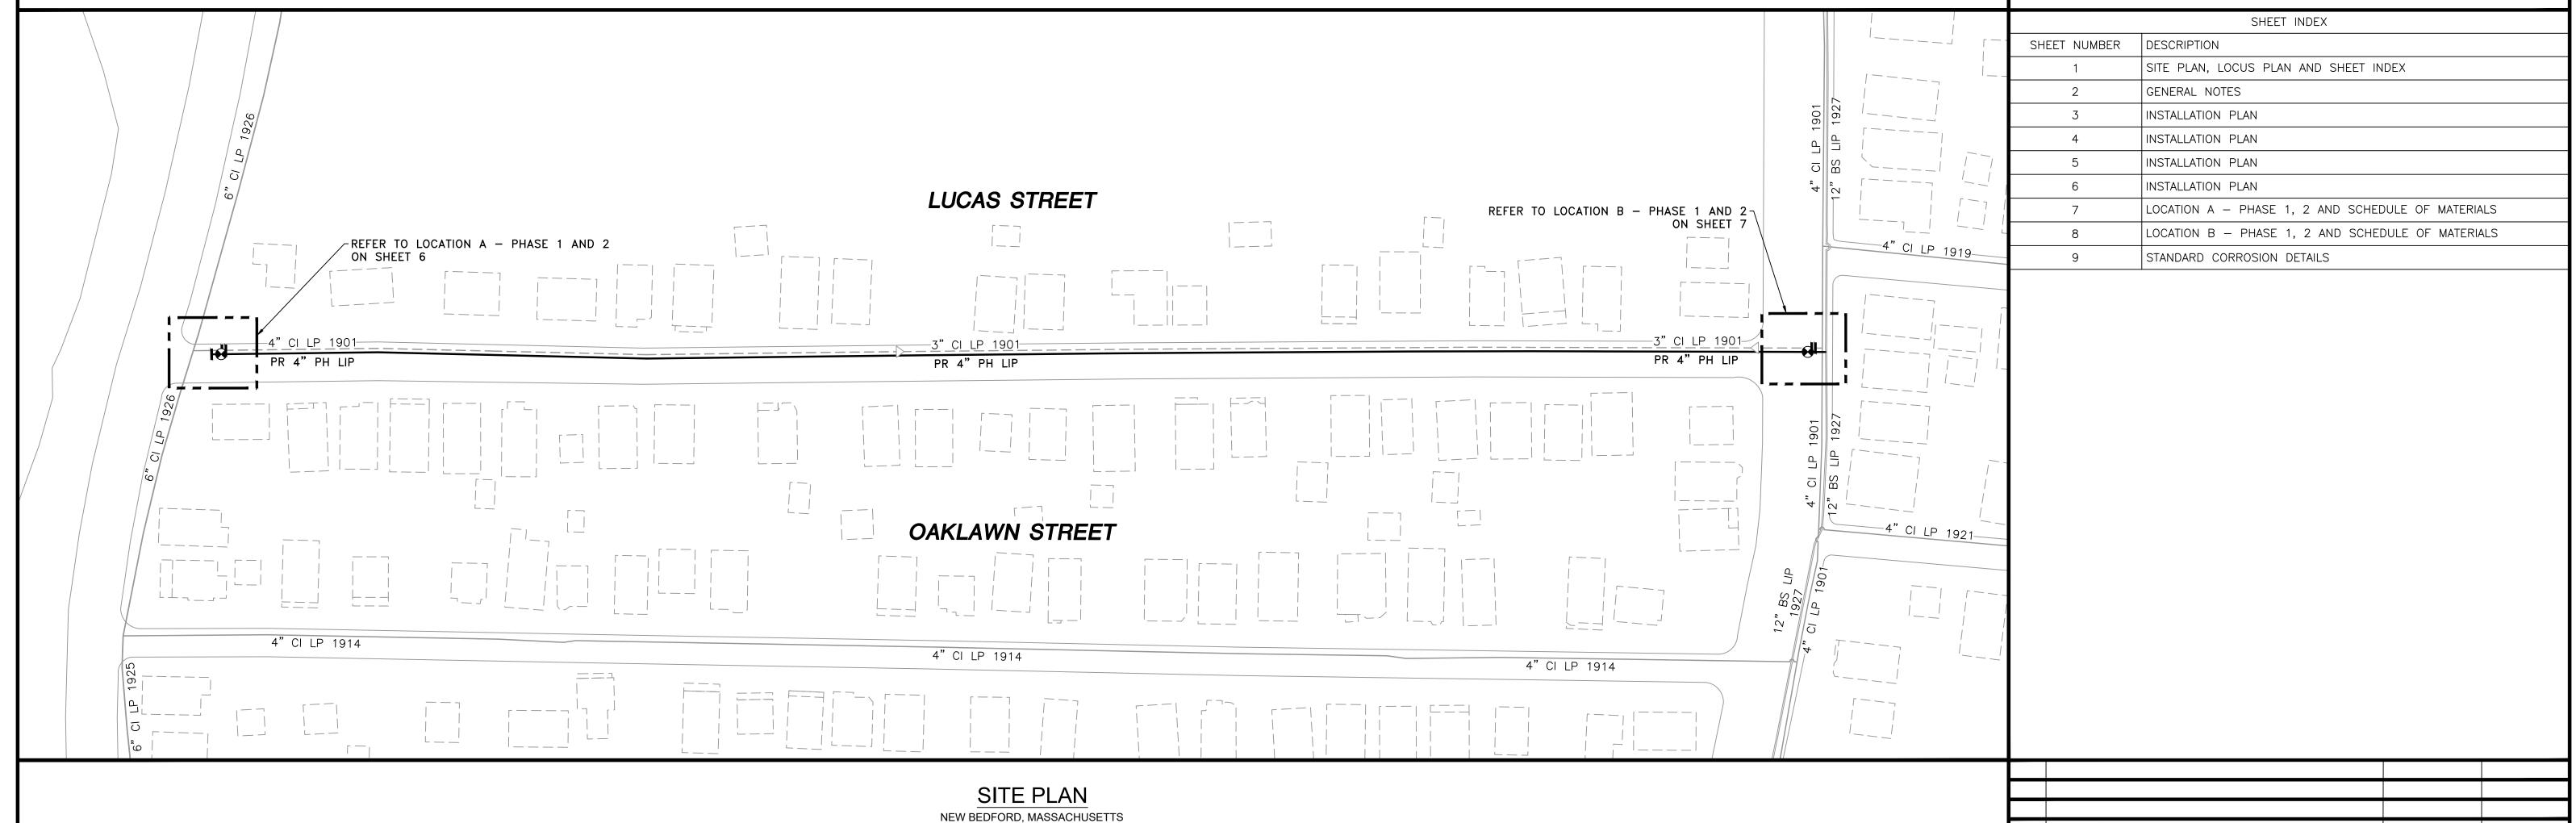

(SCALE: 1"=60') (DO NOT SCALE FROM DRAWINGS)

ISSUED FOR CONSTRUCTION 11/23/2020

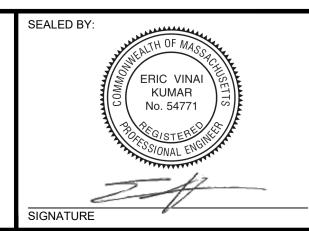

SEALED ON: 11/24/2020 LICENSE EXPIRATION: **EN**Engineering 29 BARTLETT STREET MARLBOROUGH, MA 01752 TEL. (630) 353-4000 FAX (630) 535-7777 WWW.ENENGINEERING.COM

06/30/2022

FIELD VERIFY DIMENSIONS PRIOR TO PIPE FABRICATION

REVISION STATUS EVERS\$\rightarrow\$URCE LUCAS STREET MAIN RELAY NEW BEDFORD, MASSACHUSETTS SITE PLAN, LOCUS PLAN AND SHEET INDEX

11/23/2020 ZS/AB/EK

DW/CK/AF

DATE

0 ISSUED FOR CONSTRUCTION

NO. DESCRIPTION

SCALE: AS NOTED SHEET 1 OF 9 SHEET NUMBER MA-21-PIP-NEB-003-01 MA21PIPNEB003R0


GENERAL NOTES


- 1. IF ANY OF THE FOLLOWING OCCUR A DRAWING REVISION IS REQUIRED AND MUST BE APPROVED AND/OR STAMPED BY THE ENGINEER OF RECORD. CHANGES CAN BE APPROVED AND/OR STAMPED BY A PROJECT ENGINEER, BUT THE ENGINEER OF RECORD MUST BE INFORMED.
 - A. IF THE TIE IN POINT MOVES TO A DIFFERENT SEGMENT OF PIPE THAN SHOWN
 - B. IF A CHANGE IN THE LOCATION OF VALVES IS REQUIRED
 - C. IF THERE IS ANY CHANGE TO WHAT IS SHOWN ON THE DRAWING WITHIN 50 FT OF A
 - PRESSURE REGULATING STATION, DISTRICT REGULATOR, OR GATE STATION D. IF A CHANGE IN PIPE SIZE, MATERIAL, FITTINGS, OR WALL THICKNESS IS REQUIRED.
- 2. MINOR CHANGES SUCH AS OFFSETS MAY NOT REQUIRE DRAWING CHANGES.
- 3. EXCAVATOR SHALL CALL DIGSAFE/CALL BEFORE YOU DIG (DIAL 811) AT LEAST 72 HOURS PRIOR TO CONSTRUCTION. SATURDAYS, SUNDAYS, AND HOLIDAYS ARE EXCLUDED FROM THE 72-HOUR TIME SPAN, NOT CONSIDERED BUSINESS WORKDAYS.
- 4. CONSTRUCTION DRAWINGS ARE BASED ON EVERSOURCE HISTORICAL DOCUMENTATION AND HAVE NOT BEEN FIELD VERIFIED. WHEN THE PIPE IS EXPOSED AND VARIANCES TO THE CERTIFIED DRAWINGS ARE FOUND, CONTACT GAS ENGINEERING TO DETERMINE PATH FORWARD.
- 5. ALL WORK SHALL BE PERFORMED PER EVERSOURCE, LOCAL, STATE, OSHA, AND FEDERAL REGULATIONS AND STANDARDS.
- 6. MATERIAL AND CONSTRUCTION SHALL CONFORM TO EVERSOURCE GAS STANDARDS.
- 7. THE LOCATIONS OF EXISTING UTILITIES AND UNDERGROUND STRUCTURES ARE APPROXIMATE AND MUST BE FIELD VERIFIED. ADDITIONAL UNDERGROUND FACILITIES MAY EXIST THAT ARE NOT SHOWN ON THESE DRAWINGS WHICH MAY REQUIRE ADDITIONAL OFFSETS IN THE PIPELINE.
- 8. WORK LOCATIONS SHOWN ON THE DRAWINGS ARE APPROXIMATE. EXACT LOCATIONS OF TIE-INS SHALL BE DETERMINED AT THE TIME OF CONSTRUCTION TO SUIT FIELD CONDITIONS AT THE SPECIFIC TIE-IN POINT. VERIFY LOCATIONS OF ALL EXISTING UTILITIES PRIOR TO BEGINNING ANY TIE-IN WORK.
- 9. ALL LIVE GAS WORK INCLUDING BUT NOT LIMITED TO TAPPING OF FITTINGS ON LIVE MAINS, STOPPING, MANIPULATING VALVE, ABANDONMENT, SHALL BE PERFORMED BY, OR AT THE DIRECTION AND UNDER THE DIRECT SUPERVISION OF EVERSOURCE GAS PERSONNEL AND IN ACCORDANCE WITH THE WRITTEN PROCEDURE. DRAWING CHANGES MAY ALSO REQUIRE A CHANGE TO THE PROCEDURE.
- EXCAVATOR IS REQUIRED TO PROTECT EXISTING UTILITIES, STRUCTURES, LANDSCAPE FEATURES, SIGNAGE, CURBS, ETC. CARE SHOULD BE TAKEN NOT TO DISTURB OR DAMAGE SUCH ROADWAY, SIDEWALKS, AND GRASS DISTURBED SHALL BE RESTORED TO THE SATISFACTION OF THE CITY OR TOWN. PLANT BEDS WILL BE RELOCATED TO THEIR EXISTING REGULAR LOCATION.
- 11. IF THE PROJECT IS WITHIN 50 FEET OF A DISTRICT REGULATOR OR GATE STATION, ENSURE THAT A QUALIFIED I&R TECHNICIAN IS ON SITE.
- 12. ALL TRAFFIC CONTROL SHALL CONFORM TO THE LATEST EDITION OF THE MANUAL OF UNIFORM TRAFFIC CONTROL DEVICES (MUTCD), INCLUDING ALL REVISIONS AND ADDENDA. ALL TRAFFIC CONTROL DEVICES WILL BE SUPPLIED BY EXCAVATOR.
- 13. PROPERTY LINES, STRUCTURES AND EXISTING CONDITIONS DEPICTED ON PLANS ARE BASED ON EVERSOURCE GIS INFORMATION AND HAVE NOT BEEN VERIFIED BY LAND SURVEY UNLESS NOTED.
- 14. EXISTING SERVICES SHOWN ON PLAN ARE FOR INFORMATION ONLY. PROPOSED SERVICES ARE NOT SHOWN ON PLANS AND ARE TO BE INSTALLED PER EVERSOURCE CONSTRUCTION STANDARDS.
- 15. PROPOSED WORK SHALL BE PERFORMED AND COMPLETED IN COMPLIANCE WITH ALL PERMITS AND APPROVALS.
- 16. MAINS AND SERVICES SHALL BE PRESSURE TESTED IN ACCORDANCE WITH EVERSOURCE OM-205.
- 17. MAOP:

LP = 14" W.C. LIP = 35 PSIG IP = 60 PSIG HP = 90 PSIG

- 18. ALL WORK SHALL BE PERFORMED PER EVERSOURCE, LOCAL, STATE AND FEDERAL REGULATIONS AND STANDARDS.
- 19. ALL PIPE WILL BE INSTALLED WITH A MINIMUM DEPTH IN ACCORDANCE WITH EVERSOURCE STANDARDS
- 20. SQUEEZE OPERATIONS SHOULD BE COMPLETED IN ACCORDANCE WITH OM-233
- 21. ENSURE ALL SERVICES BEING TRANSFERRED TO A HIGHER PRESSURE SYSTEM HAVE UPGRADED PRESSURE REGULATORS INSTALLED PRIOR TO ACTIVATION.
- 22. ENSURE VALVES ON EXISTING MAIN, WHERE PROPOSED MAIN WILL BE INSERTED HAVE BEEN MADE INOPERABLE.
- 23. ADDITIONAL VALVES AND TEES THAT ARE INCLUDED IN THE SCHEDULE OF MATERIALS MAY BE INSTALLED TEMPORARILY WHEN NEEDED TO FACILITATE TIE-INS AND PURGES.
- 24. METFIT FITTINGS MAY BE SUBSTITUTED FOR ELECTROFUSION FITTINGS WHERE NEEDED.
- 25. DO NOT SCALE FROM DRAWINGS.

ISSUED FOR CONSTRUCTION 11/23/2020

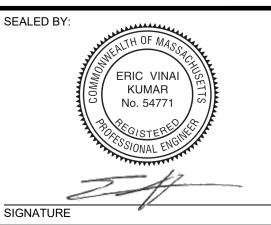

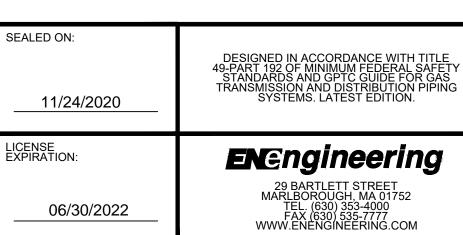

FIELD VERIFY DIMENSIONS PRIOR TO PIPE FABRICATION


0 ISSUED FOR CONSTRUCTION 11/23/2020 ZS/AB/EK NO. DESCRIPTION DATE DW/CK/AP **REVISION STATUS EVERS©**URCE LUCAS STREET MAIN RELAY NEW BEDFORD, MASSACHUSETTS


GENERAL NOTES SCALE: NOT TO SCALE SHEET 2 OF 9 CHECKED BY / DATE AB 11/23/2020 SHEET NUMBER MA-21-PIP-NEB-003-02


MA21PIPNEB003R0


EK 11/23/2020

06/30/2022

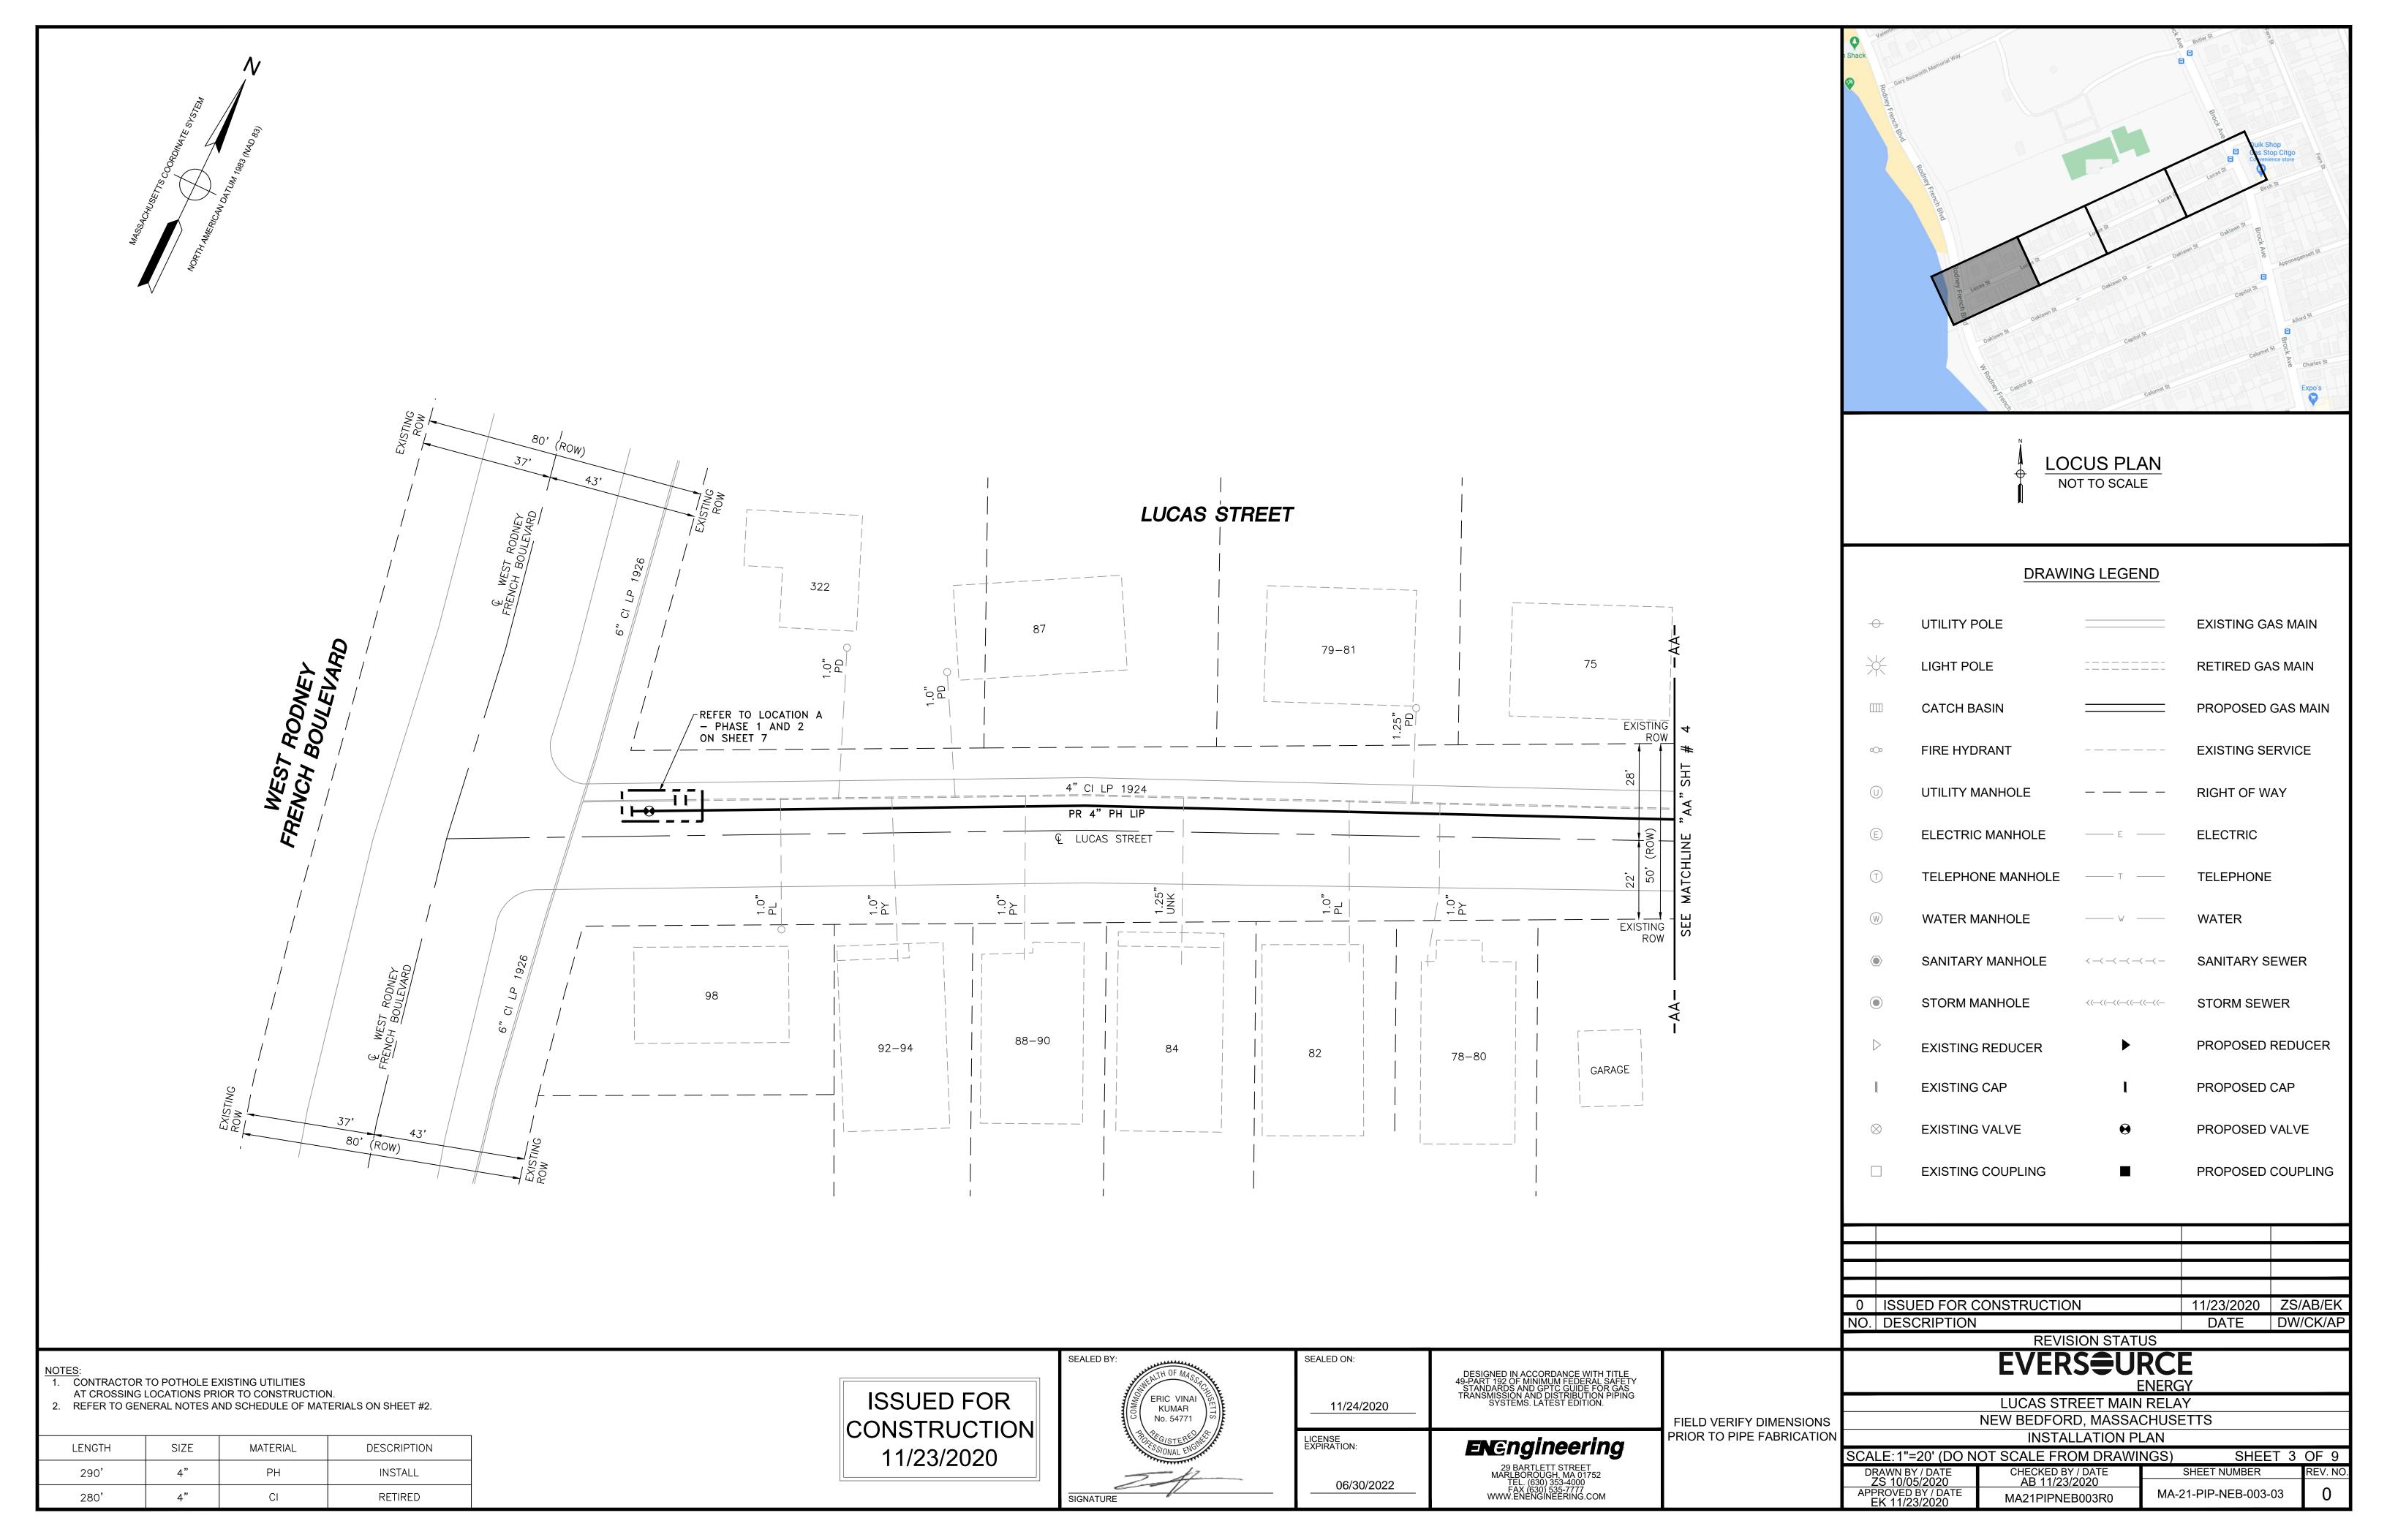

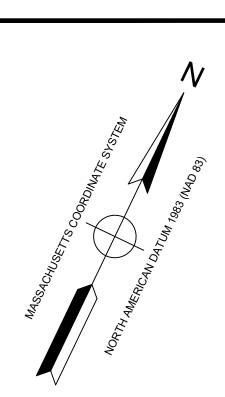

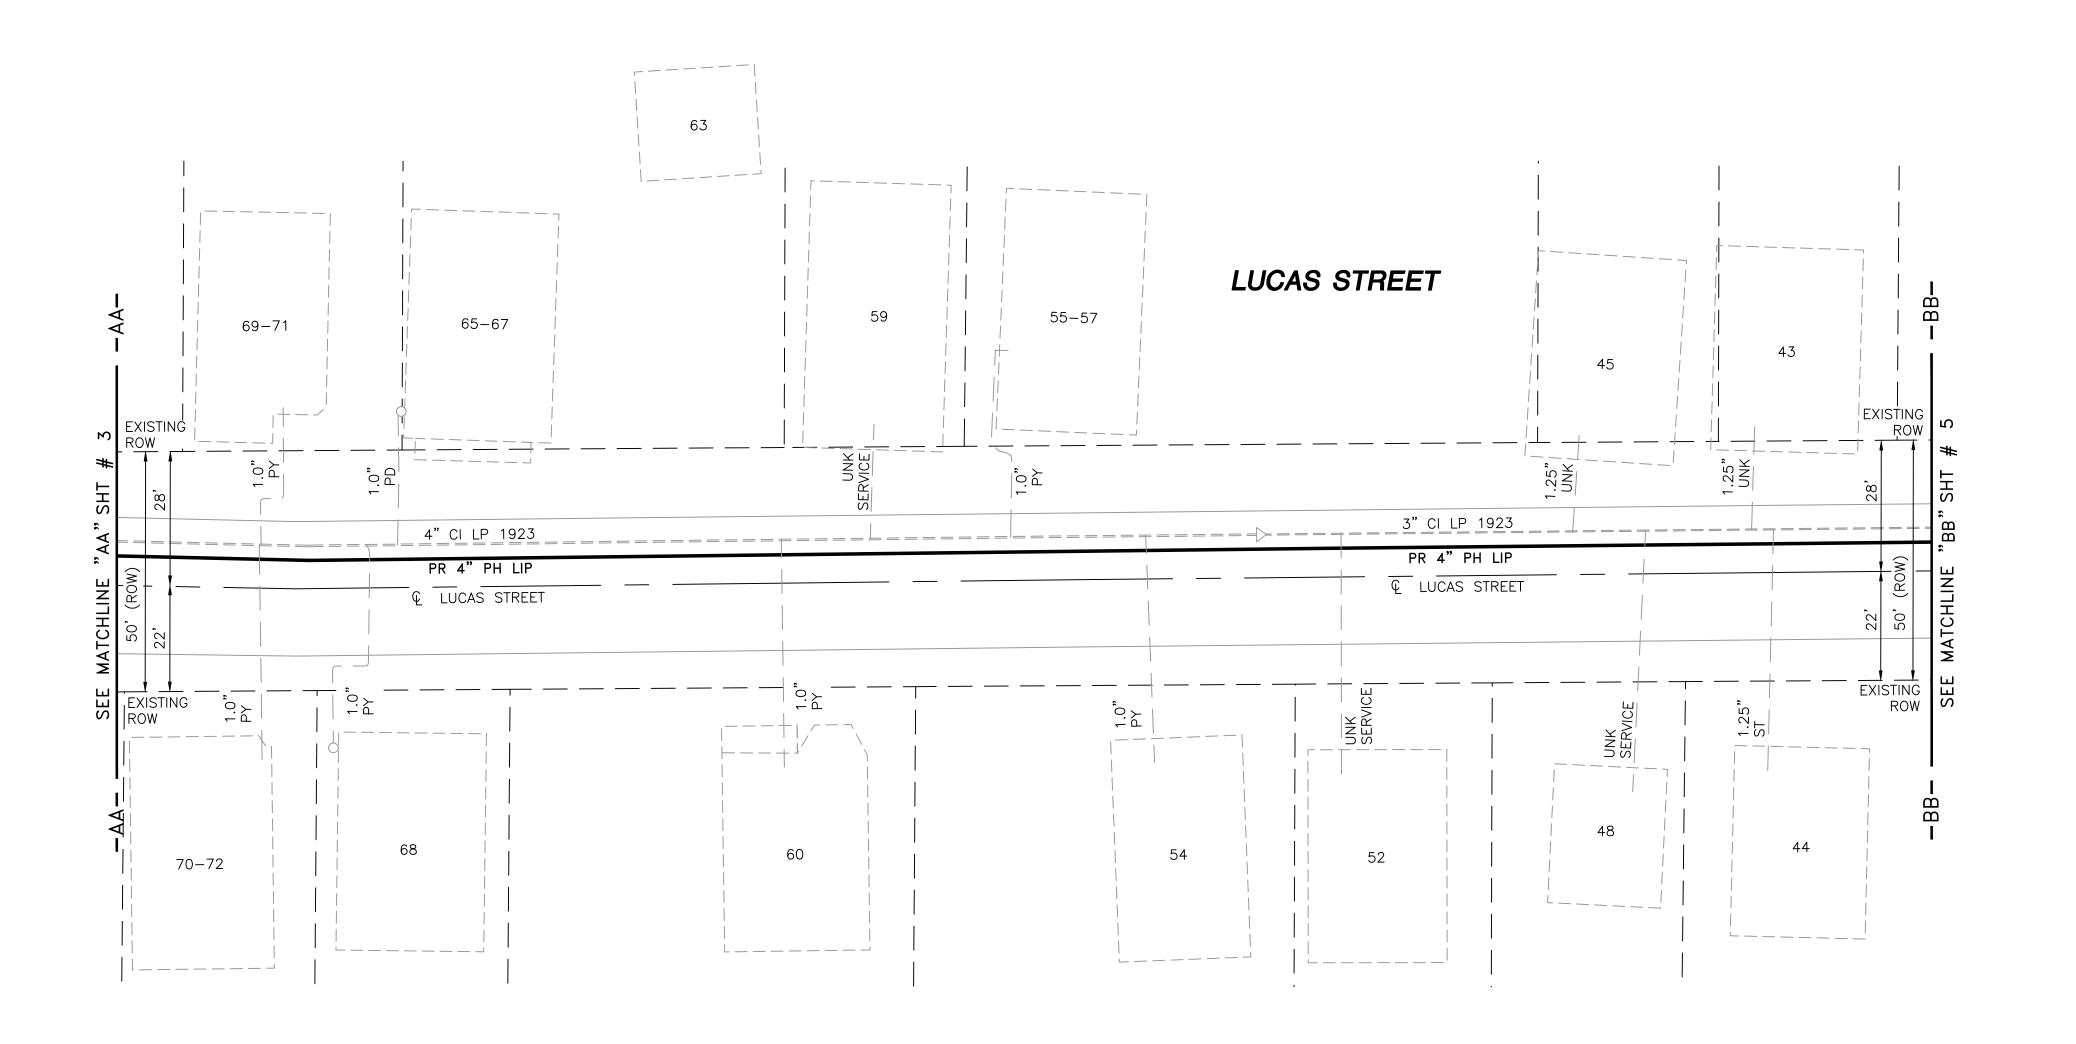

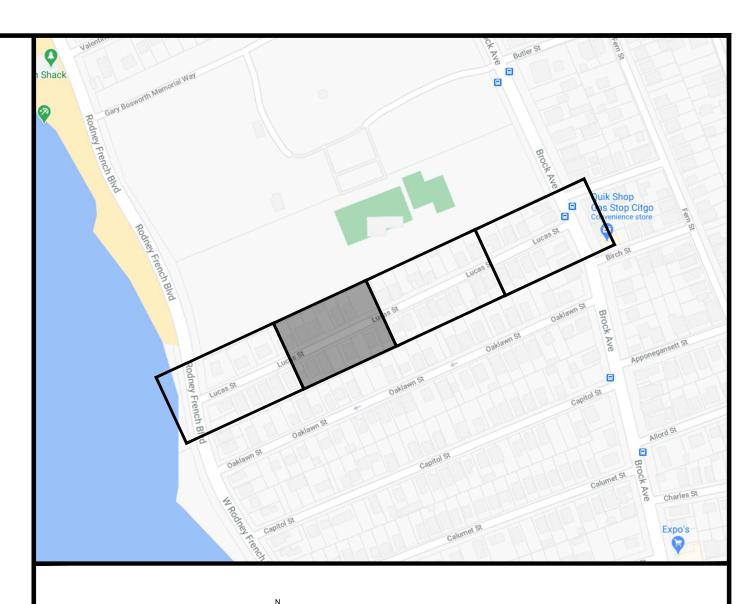

LOCUS PLAN NOT TO SCALE

DRAWING LEGEND						
\rightarrow	UTILITY POLE		EXISTING GAS MAIN			
*	LIGHT POLE	=======	RETIRED GAS MAIN			
	CATCH BASIN		PROPOSED GAS MAIN			
o <u></u> o	FIRE HYDRANT		EXISTING SERVICE			
\bigcirc	UTILITY MANHOLE	_ — — –	RIGHT OF WAY			
E	ELECTRIC MANHOLE	—— Е ——	ELECTRIC			
\bigcirc	TELEPHONE MANHOLE	—— т	TELEPHONE			
W	WATER MANHOLE	W	WATER			
	SANITARY MANHOLE	<-<<-	SANITARY SEWER			
	STORM MANHOLE	<	STORM SEWER			
\triangleright	EXISTING REDUCER	•	PROPOSED REDUCER			
l	EXISTING CAP	1	PROPOSED CAP			
\otimes	EXISTING VALVE	•	PROPOSED VALVE			
	EXISTING COUPLING		PROPOSED COUPLING			

0	ISSUED FOR CONSTRUCTION	11/23/2020	ZS/AB/EI
NO.	DESCRIPTION	DATE	DW/CK/A
	REVISION STATUS		


NOTES:

1. CONTRACTOR TO POTHOLE EXISTING UTILITIES
AT CROSSING LOCATIONS PRIOR TO CONSTRUCTION.

2. REFER TO GENERAL NOTES AND SCHEDULE OF MATERIALS ON SHEET #2.

LENGTH	SIZE	MATERIAL	DESCRIPTION
385'	4"	PH	INSTALL
140'	3"	CI	RETIRED
245'	4"	CI	RETIRED

ISSUED FOR CONSTRUCTION 11/23/2020

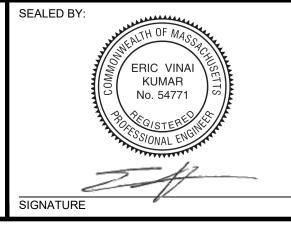


SEALED ON:11/24/2020	DESIGNED IN ACCORDANCE WITH TITLE 49-PART 192 OF MINIMUM FEDERAL SAFETY STANDARDS AND GPTC GUIDE FOR PIPING TRANSMISSION AND DISTRIBUTION PIPING SYSTEMS. LATEST EDITION.
LICENSE EXPIRATION:	EN Engineering
06/30/2022	29 BARTLETT STREET MARLBOROUGH, MA 01752 TEL. (630) 353-4000 FAX (630) 535-7777 WWW.ENENGINEERING.COM


FIELD VERIFY DIMENSIONS
PRIOR TO PIPE FABRICATION


EVERS\$\rightarrow\$URCE

LUCAS STREET MAIN RELAY NEW BEDFORD, MASSACHUSETTS INSTALLATION PLAN

١,	INSTALLATION FLAN						
	SCALE:1"=20' (DO N	NGS) SHEET 4	OF 9				
	DRAWN BY / DATE	CHECKED BY / DATE	SHEET NUMBER	REV. NO			
	ZS 10/05/2020	AB 11/23/2020					
	APPROVED BY / DATE EK 11/23/2020	MA21PIPNEB003R0	MA-21-PIP-NEB-003-04	0			

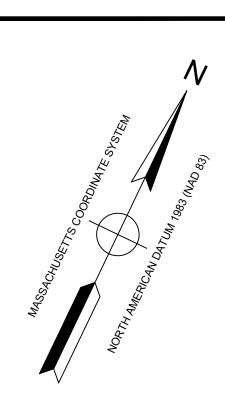

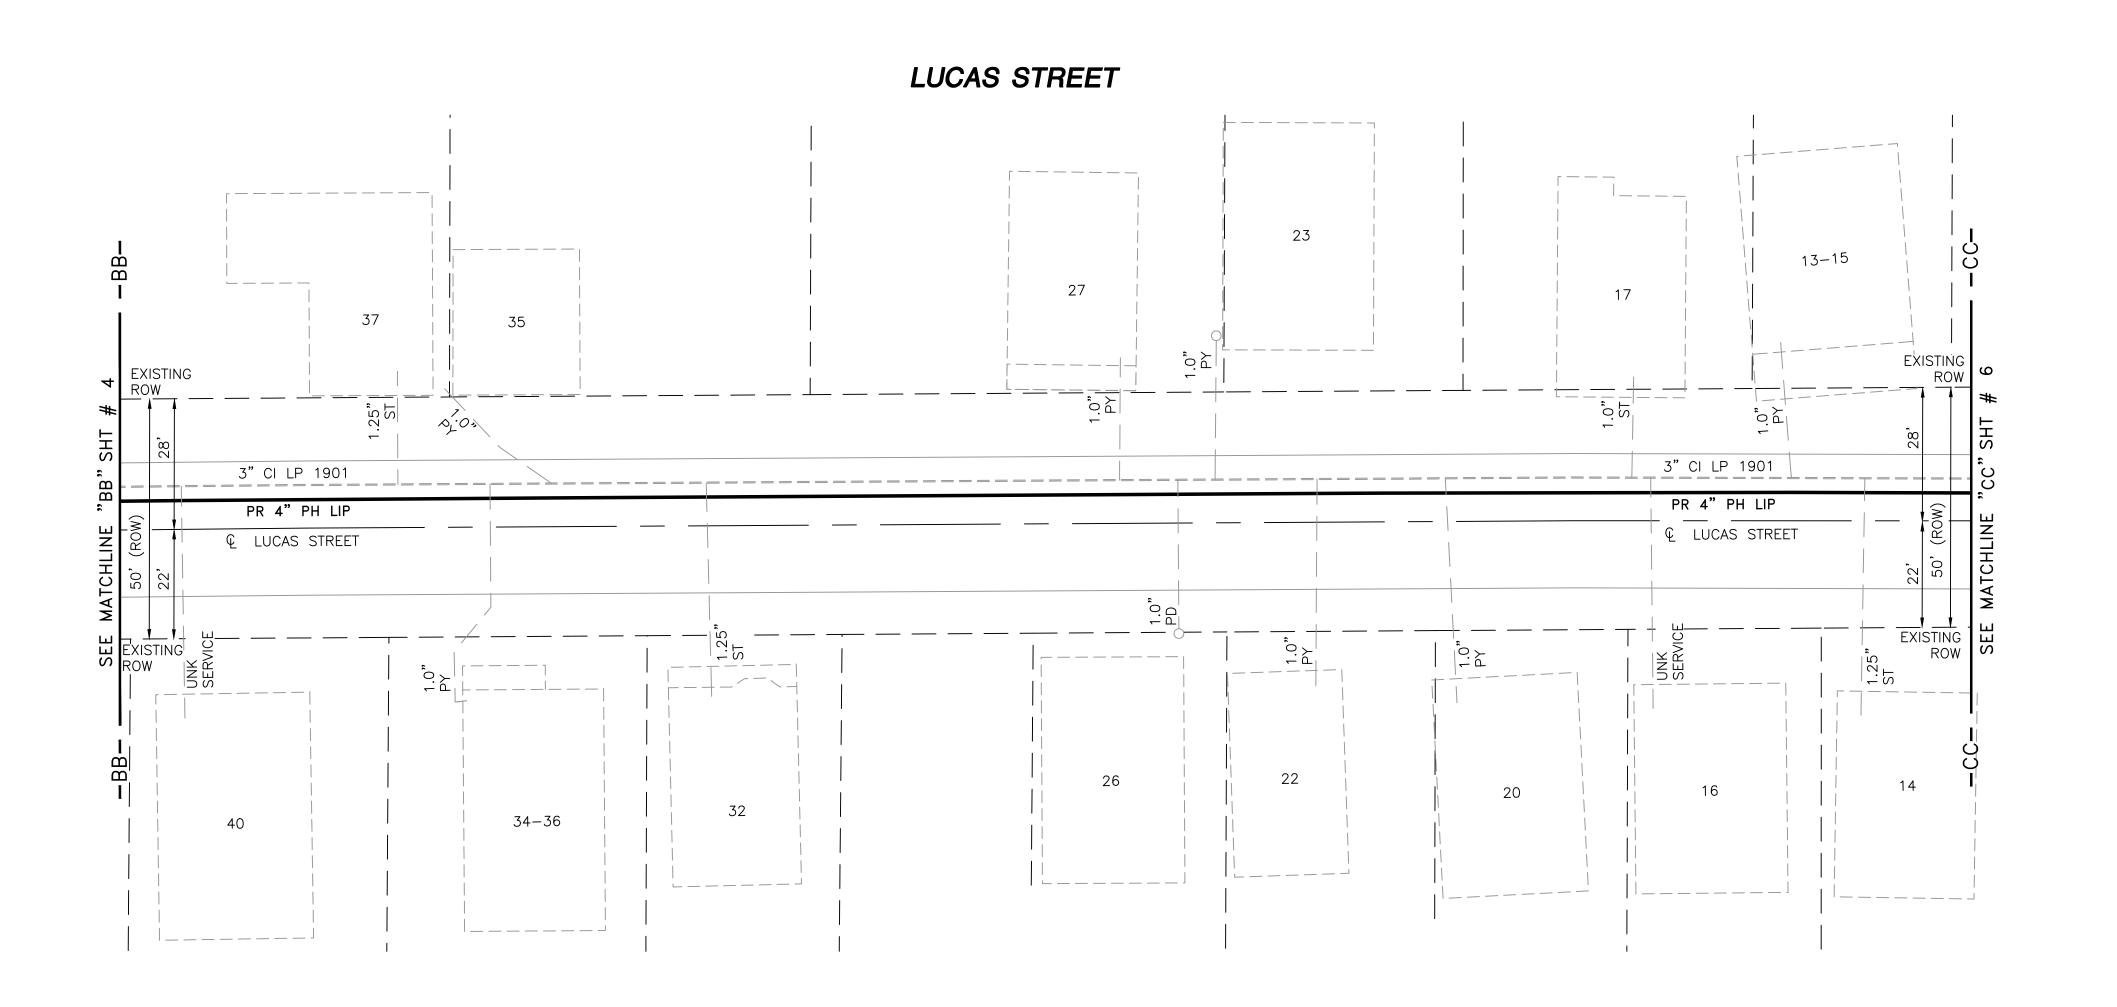

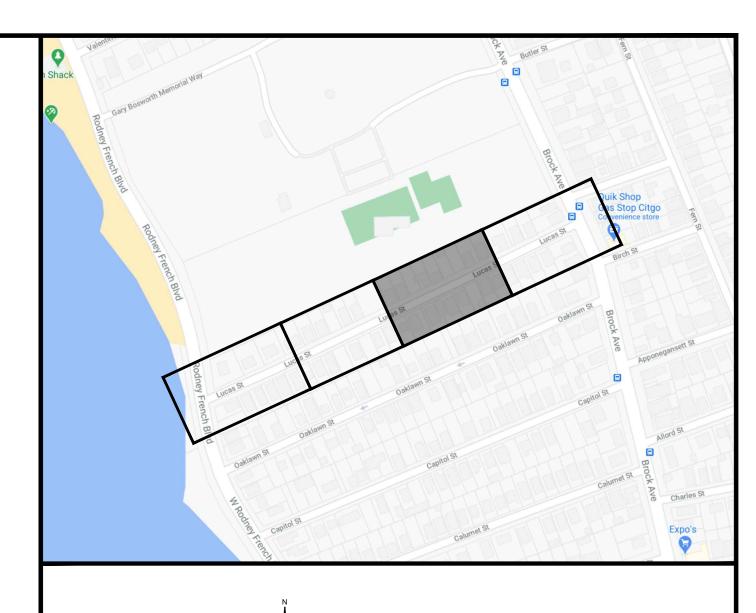

LOCUS PLAN NOT TO SCALE

DRAWING LEGEND						
\rightarrow	UTILITY POLE		EXISTING GAS MAIN			
*	LIGHT POLE	=======	RETIRED GAS MAIN			
	CATCH BASIN		PROPOSED GAS MAIN			
○ ○○	FIRE HYDRANT		EXISTING SERVICE			
U	UTILITY MANHOLE		RIGHT OF WAY			
E	ELECTRIC MANHOLE	—— Е	ELECTRIC			
T	TELEPHONE MANHOLE	— т —	TELEPHONE			
W	WATER MANHOLE	W	WATER			
	SANITARY MANHOLE	<-<-<-	SANITARY SEWER			
	STORM MANHOLE	-<<<<	STORM SEWER			
\triangleright	EXISTING REDUCER	•	PROPOSED REDUCER			
I	EXISTING CAP	l	PROPOSED CAP			
\otimes	EXISTING VALVE	•	PROPOSED VALVE			
	EXISTING COUPLING	•	PROPOSED COUPLING			

0	ISSUED FOR CONSTRUCTION	11/23/2020	ZS/AB/EI
NO.	DESCRIPTION	DATE	DW/CK/A
	DEVISION STATUS		


NOTES:

1. CONTRACTOR TO POTHOLE EXISTING UTILITIES
AT CROSSING LOCATIONS PRIOR TO CONSTRUCTION.

2. REFER TO GENERAL NOTES AND SCHEDULE OF MATERIALS ON SHEET #2.

LENGTH	SIZE	MATERIAL	DESCRIPTION
385'	4"	PH	INSTALL
385'	3"	CI	RETIRED

ISSUED FOR CONSTRUCTION 11/23/2020

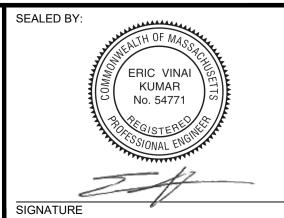


SEALED ON:	DESIGNED IN ACCORDANCE WITH TITLE 49-PART 192 OF MINIMUM FEDERAL SAFETY STANDARDS AND GPTC GUIDE FOR GRIS TRANSMISSION AND DISTRIBUTION PIPING SYSTEMS. LATEST EDITION.
LICENSE EXPIRATION:	ENEngineering 29 BARTLETT STREET MARLBOROUGH, MA 01752


FIELD VERIFY DIMENSIONS
PRIOR TO PIPE FABRICATION


EVERS\$\rightarrow\$URCE

ENERGY LUCAS STREET MAIN RELAY NEW BEDFORD, MASSACHUSETTS INSTALLATION PLAN

111017/122/1110111 27/11						
SCALE: 1"=20' (DO N	OT SCALE FROM DRAWII	NGS)	SHEET !	5	OF	9
DRAWN BY / DATE	CHECKED BY / DATE		SHEET NUMBER		REV.	. NO
ZS 10/05/2020	AB 11/23/2020				_	
APPROVED BY / DATE EK 11/23/2020	MA21PIPNEB003R0	MA.	-21-PIP-NEB-003-05		C)

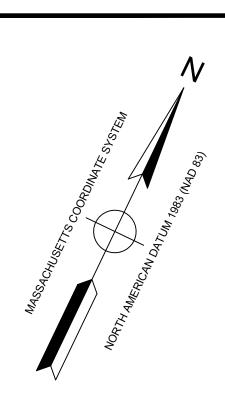

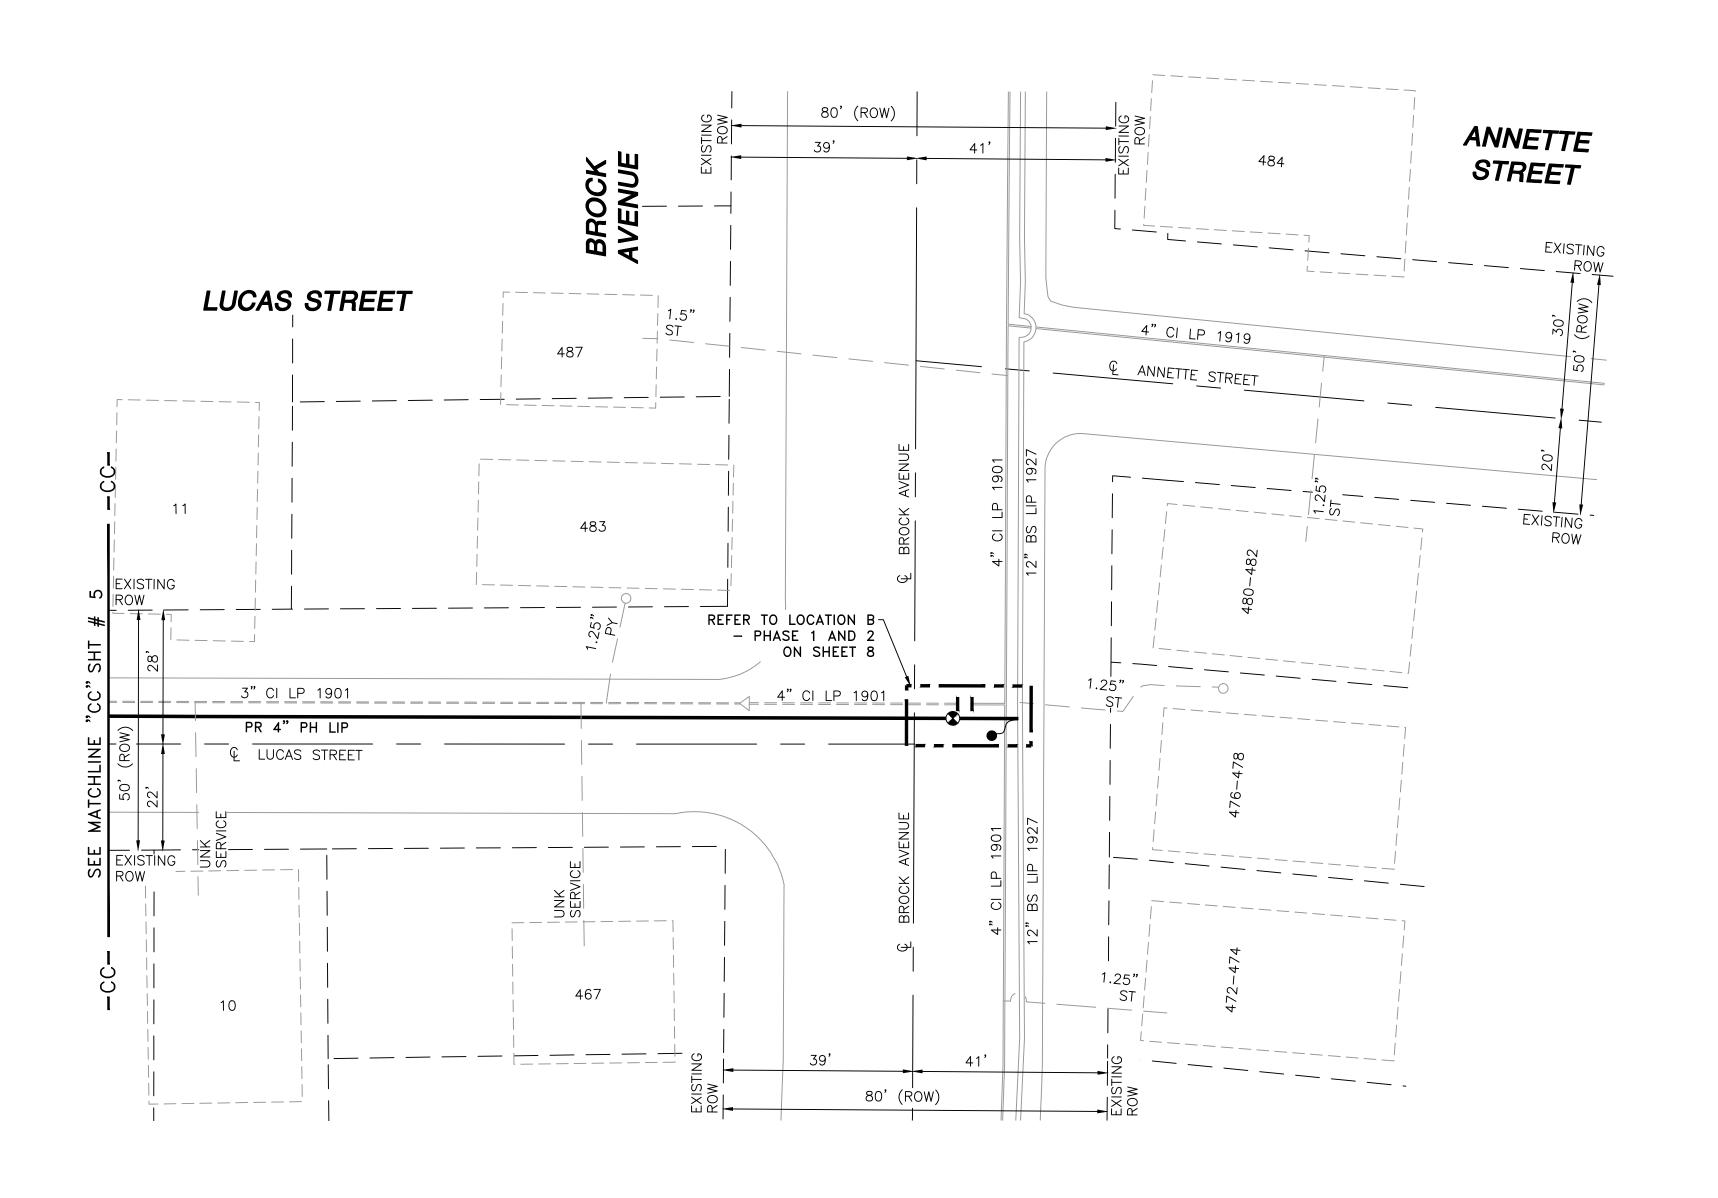

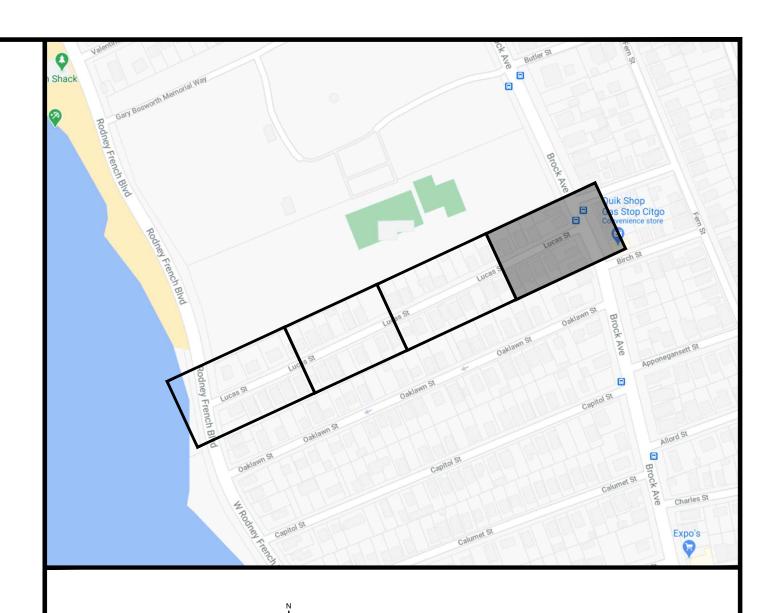

LOCUS PLAN NOT TO SCALE

DRAWING LEGEND

\ominus	UTILITY POLE		EXISTING GAS MAIN
\	LIGHT POLE	=======	RETIRED GAS MAIN
	CATCH BASIN		PROPOSED GAS MAIN
:Oo	FIRE HYDRANT		EXISTING SERVICE
Û	UTILITY MANHOLE		RIGHT OF WAY
E	ELECTRIC MANHOLE	— Е —	ELECTRIC
Ī	TELEPHONE MANHOLE	— т —	TELEPHONE
W	WATER MANHOLE	—— W	WATER

SANITARY MANHOLE

STORM MANHOLE

EXISTING REDUCER

EXISTING CAP

EXISTING VALVE

SANITARY SEWER

STORM SEWER

PROPOSED CAP

PROPOSED VALVE

PROPOSED REDUCER

PROPOSED COUPLING EXISTING COUPLING

0 ISSUED FOR CONSTRUCTION 11/23/2020 ZS/AB/EK NO. DESCRIPTION DATE DW/CK/AP **REVISION STATUS**

EVERSURCE


LUCAS STREET MAIN RELAY NEW BEDFORD, MASSACHUSETTS **INSTALLATION PLAN**

111017 (22) (11011 27) (11						
SCALE: 1"=20' (DO N	SHEET 6	3	OF	9		
DRAWN BY / DATE	CHECKED BY / DATE		SHEET NUMBER		REV.	. NO
ZS 10/05/2020	AB 11/23/2020				_	$\overline{}$
APPROVED BY / DATE EK 11/23/2020	MA21PIPNEB003R0	MA.	-21-PIP-NEB-003-06		Ĺ)

1.	NOTES: 1. CONTRACTOR TO POTHOLE EXISTING UTILITIES AT CROSSING LOCATIONS PRIOR TO CONSTRUCTION. 2. REFER TO GENERAL NOTES AND SCHEDULE OF MATERIALS ON SHEET #2.								
	LENGTH	SIZE	MATERIAL	DESCRIPTION					
	190'	4"	PH	INSTALL					
	130'	3"	CI	RETIRED					

RETIRED

ISSUED FOR CONSTRUCTION 11/23/2020

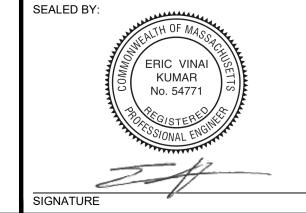

SEALED ON:


LICENSE EXPIRATION:

11/24/2020


06/30/2022


DESIGNED IN ACCORDANCE WITH TITLE 49-PART 192 OF MINIMUM FEDERAL SAFETY STANDARDS AND GPTC GUIDE FOR GAS TRANSMISSION AND DISTRIBUTION PIPING SYSTEMS. LATEST EDITION.

FIELD VERIFY DIMENSIONS
PRIOR TO PIPE FABRICATION **EN**Engineering 29 BARTLETT STREET MARLBOROUGH, MA 01752 TEL. (630) 353-4000 FAX (630) 535-7777 WWW.ENENGINEERING.COM

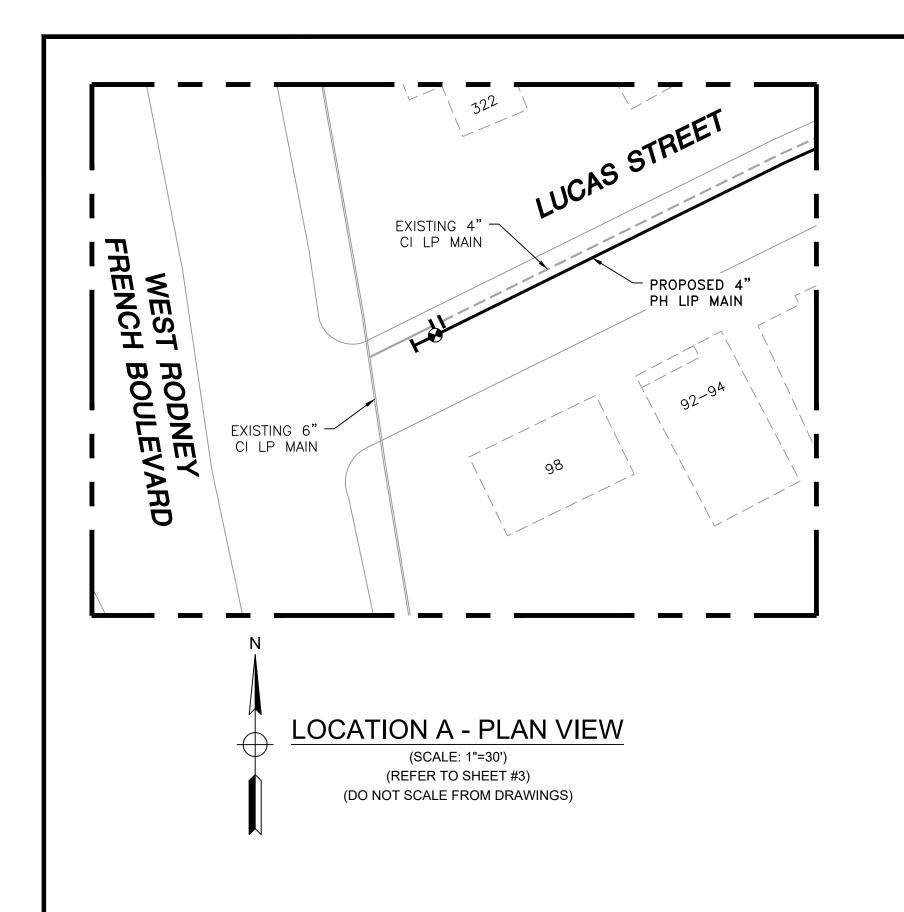



NOTE:
1. REFER TO GENERAL NOTES ON SHEET #2.

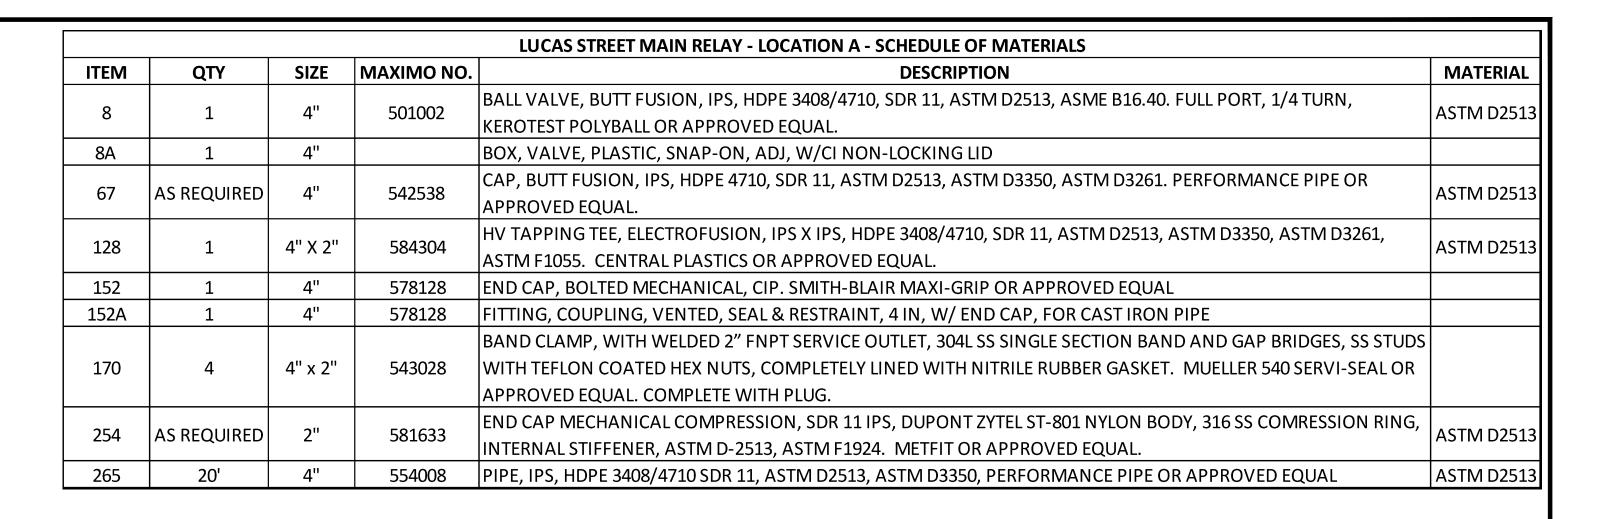

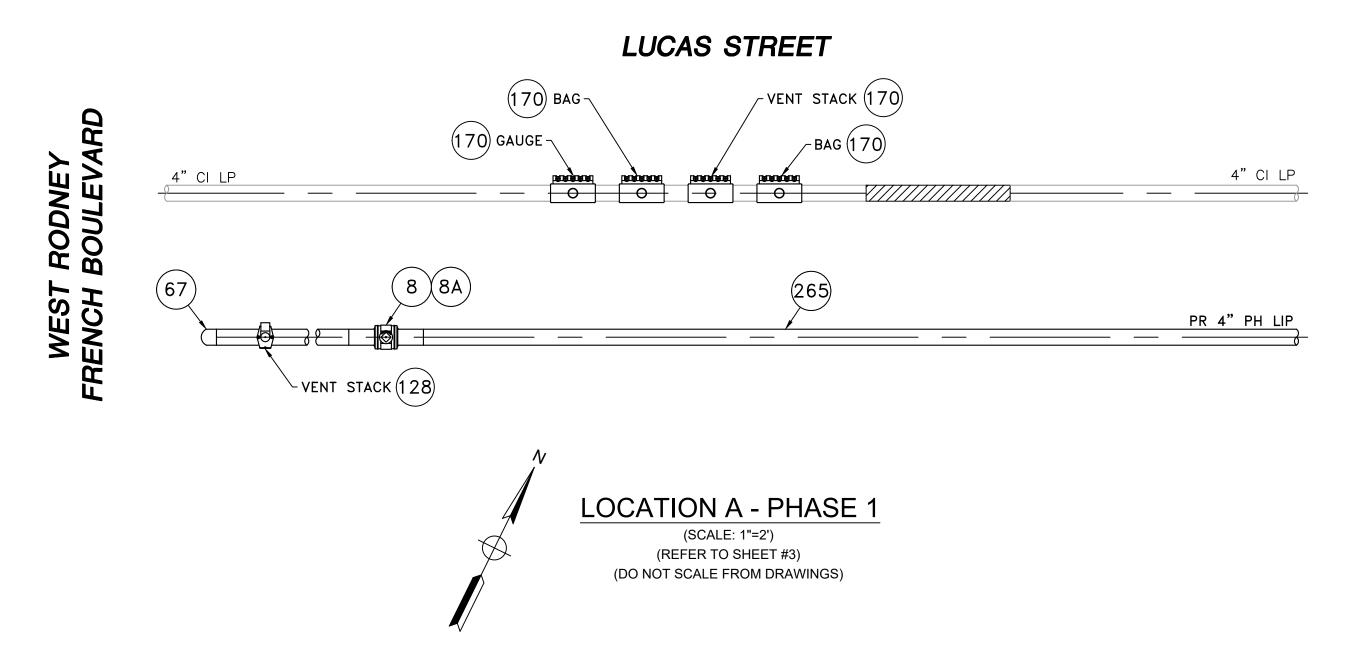


LUCAS STREET

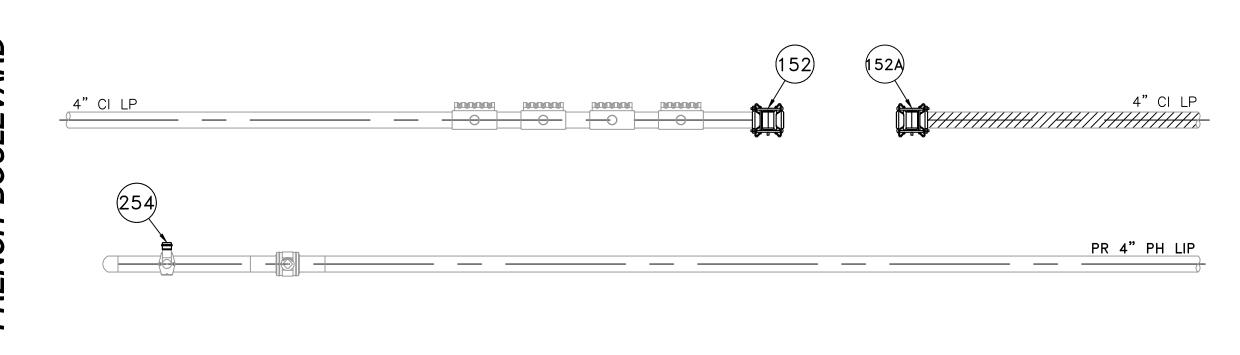

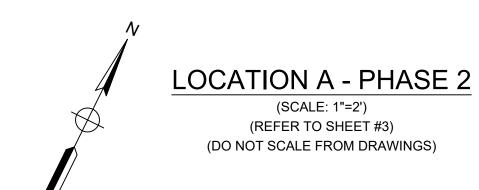

0 ISSUED FOR CONSTRUCTION 11/23/2020 ZS/AB/EK
NO. DESCRIPTION DATE DW/CK/AP
REVISION STATUS

ISSUED FOR CONSTRUCTION 11/23/2020

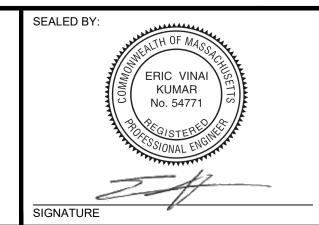

DESIGNED IN ACCORDANCE WITH TITLE
49-PART 192 OF MINIMUM FEDERAL SAFETY
STANDARDS AND GPTC GUIDE FOR GAS
TRANSMISSION AND DISTRIBUTION PIPING
SYSTEMS. LATEST EDITION.

LICENSE
EXPIRATION:

ENGINEERING

06/30/2022

29 BARTLETT STREET MARLBOROUGH, MA 01752 TEL. (630) 353-4000 FAX (630) 535-7777 WWW.ENENGINEERING.COM FIELD VERIFY DIMENSIONS
PRIOR TO PIPE FABRICATION
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EVERS

ENERGY

LUCAS STREET MAIN RELAY


NEW BEDFORD, MASSACHUSETTS

LOCATION A - PHASE 1, 2 AND SCHEDULE OF MATERIALS


 SCALE: AS NOTED
 SHEET 7 OF 9

 DRAWN BY / DATE
 CHECKED BY / DATE
 SHEET NUMBER
 REV. NO.

 ZS 10/05/2020
 AB 11/23/2020
 MA-21-PIP-NEB-003-07
 0

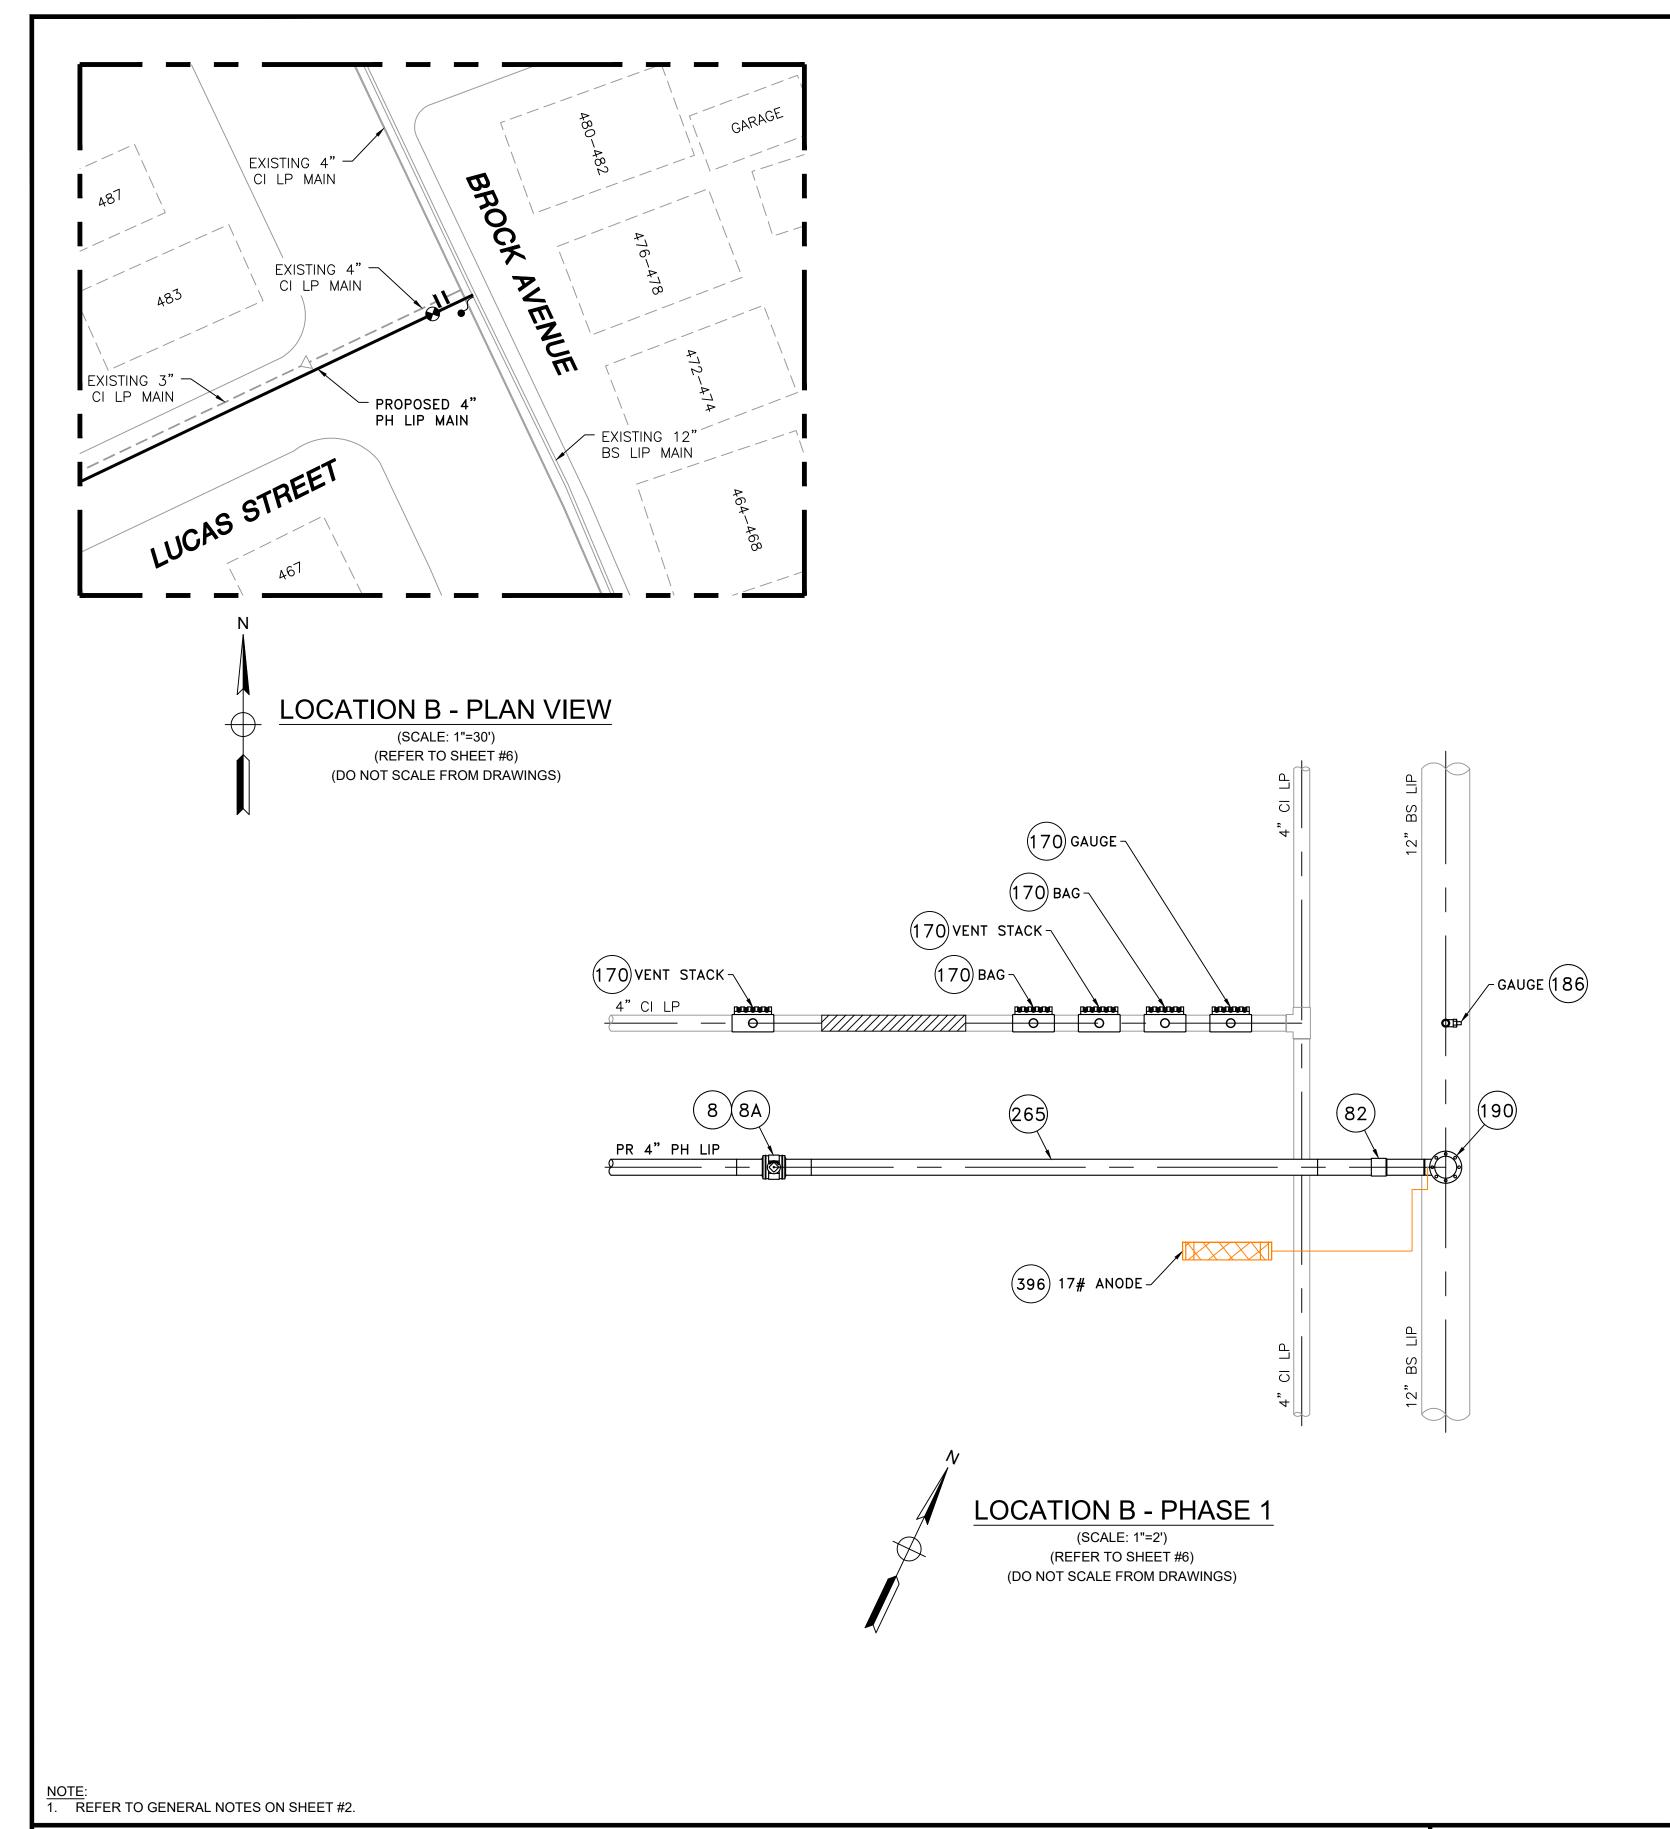

LUCAS STREET MAIN RELAY - LOCATION B - SCHEDULE OF MATERIALS								
ITEM	QTY	SIZE	MAXIMO NO.	DESCRIPTION	MATERIAL			
8	1	4"	1 501002	BALL VALVE, BUTT FUSION, IPS, HDPE 3408/4710, SDR 11, ASTM D2513, ASME B16.40. FULL PORT, 1/4 TURN,	ASTM D2513			
8				KEROTEST POLYBALL OR APPROVED EQUAL.				
8A	1	4"		BOX, VALVE, PLASTIC, SNAP-ON, ADJ, W/CI NON-LOCKING LID				
82	1	4"	546254	TRANSITION FITTING, STEEL TO HDPE, SDR 11, ASTM A53 STEEL W/WELD END, HDPE 3408 W/BUTT FUSION END,				
82				ASTM D2513, ASTM F1973, ANSI B31.8. PERFECTION OR APPROVED EQUAL.				
152	2	4"	578128	END CAP, BOLTED MECHANICAL, CIP. SMITH-BLAIR MAXI-GRIP OR APPROVED EQUAL				
	5	4" x 2"	543028	BAND CLAMP, WITH WELDED 2" FNPT SERVICE OUTLET, 304L SS SINGLE SECTION BAND AND GAP BRIDGES, SS STUDS				
170				WITH TEFLON COATED HEX NUTS, COMPLETELY LINED WITH NITRILE RUBBER GASKET. MUELLER 540 SERVI-SEAL OR				
				APPROVED EQUAL. COMPLETE WITH PLUG.				
	1	3/4" x 1/2"	578021	SERVICE TEE, WELD X MECHANICAL COUPLING FOR HDPE, CTS, DRESSER STYLE 90 TAP-N-VALVE WITH STYLE 501				
100				TRANSITION COUPLING OUTLET. FORGED STEEL BODY BEVELED FOR WELDING. STYLE 501 TRANSITION COUPLING				
186				TO HAVE THREADED BODY, INTERNAL STIFFENER WITH GASKET, SPRING WASHER AND GRIP RING WITH THREADED				
				NUT.				
100	1	4"	578137	3-WAY TEE, WELD X WELD, TD WILLIAMSON, ASTM A105 OR ASTM A234 WPB BODY, WITH FLANGED CAP AND	ASTM A105			
190				COMPLETION PLUG.				
265	25'	4"	554008	PIPE, IPS, HDPE 3408/4710 SDR 11, ASTM D2513, ASTM D3350, PERFORMANCE PIPE OR APPROVED EQUAL	ASTM D2513			
	AS REQUIRED	1/2"	542609	END CAP, MECHANICAL STAB, CTS, HDPE, PE 4710/3408, ASTM D2513, WITH SS GRIPPING SUPPORT RING, ACETAL				
270				COLLET AND SPACER RETAINER RING, PE THRUST WASHER, BUNA-N O-RING, ZINC-PLATED CS INSERT STIFFENER,	ASTM D2513			
				PERFECTION WITH END CAP OR APPROVED EQUAL.				
200	1	17#	577776	ANODE BAG, 17 LB NET, HIGH POTENTIAL MAGNESIUM, W/ 10 FT #10 AWG TW ORANGE LEAD WIRE, PACKED IN				
396				CARDBOARD BOX 42 LB WEIGHT				

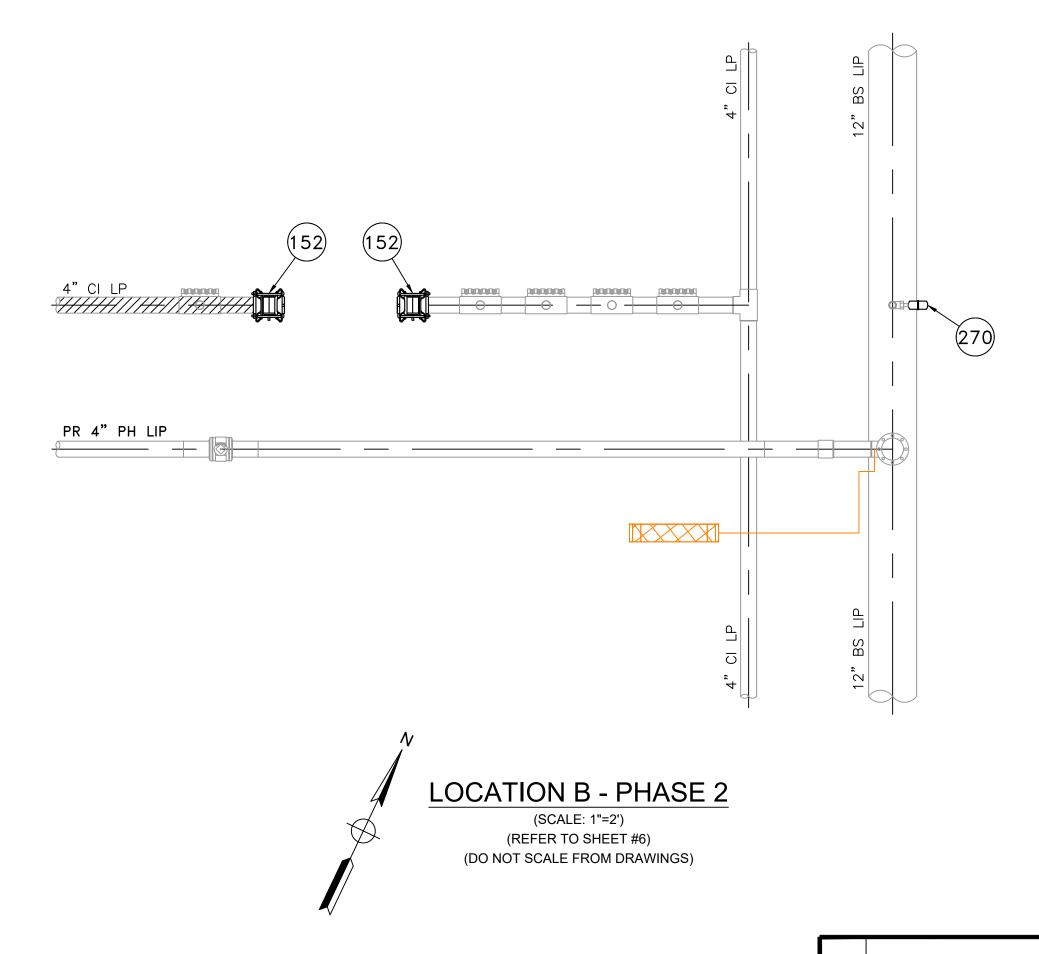

0 ISSUED FOR CONSTRUCTION 11/23/2020 ZS/AB/EK
NO. DESCRIPTION DATE DW/CK/AP
REVISION STATUS

ISSUED FOR CONSTRUCTION 11/23/2020 SEALED BY:

ERIC VINAI KUMAR
No. 54771

SIGNATURE

LICENSE EXPIRATION:

06/30/2022

DESIGNED IN ACCORDANCE WITH TITLE
49-PART 192 OF MINIMUM FEDERAL SAFETY
STANDARDS AND GPTC GUIDE FOR GAS
TRANSMISSION AND DISTRIBUTION PIPING
SYSTEMS. LATEST EDITION.

FIELD VERIFY DIMENSIONS PRIOR TO PIPE FABRICATION

29 BARTLETT STREET
MARLBOROUGH, MA 01752
TEL. (630) 353-4000
FAX (630) 535-7777
WWW.ENENGINEERING.COM

EVERSEURCE ENERGY
LUCAS STREET MAIN RELAY

NEW BEDFORD, MASSACHUSETTS

LOCATION B - PHASE 1, 2 AND SCHEDULE OF MATERIALS

SCALE: AS NOTED

SHEET 8 OF 9

DRAWN BY / DATE CHECKED BY / DATE SHEET NUMBER REZS 10/05/2020 AB 11/23/2020

APPROVED BY / DATE EK 11/23/2020 MA21PIPNEB003R0 MA-21-PIP-NEB-003-08

