




BLISS STREET MAIN RELAY
INSTALLATION OF 220' OF 2" PH LIP GAS MAIN
BLISS STREET
NEW BEDFORD, MASSACHUSETTS
ENE PROJECT #: 2005881.67
EVERSOURCE PROJECT #: 02311590



LOCUS PLAN

NOT TO SCALE

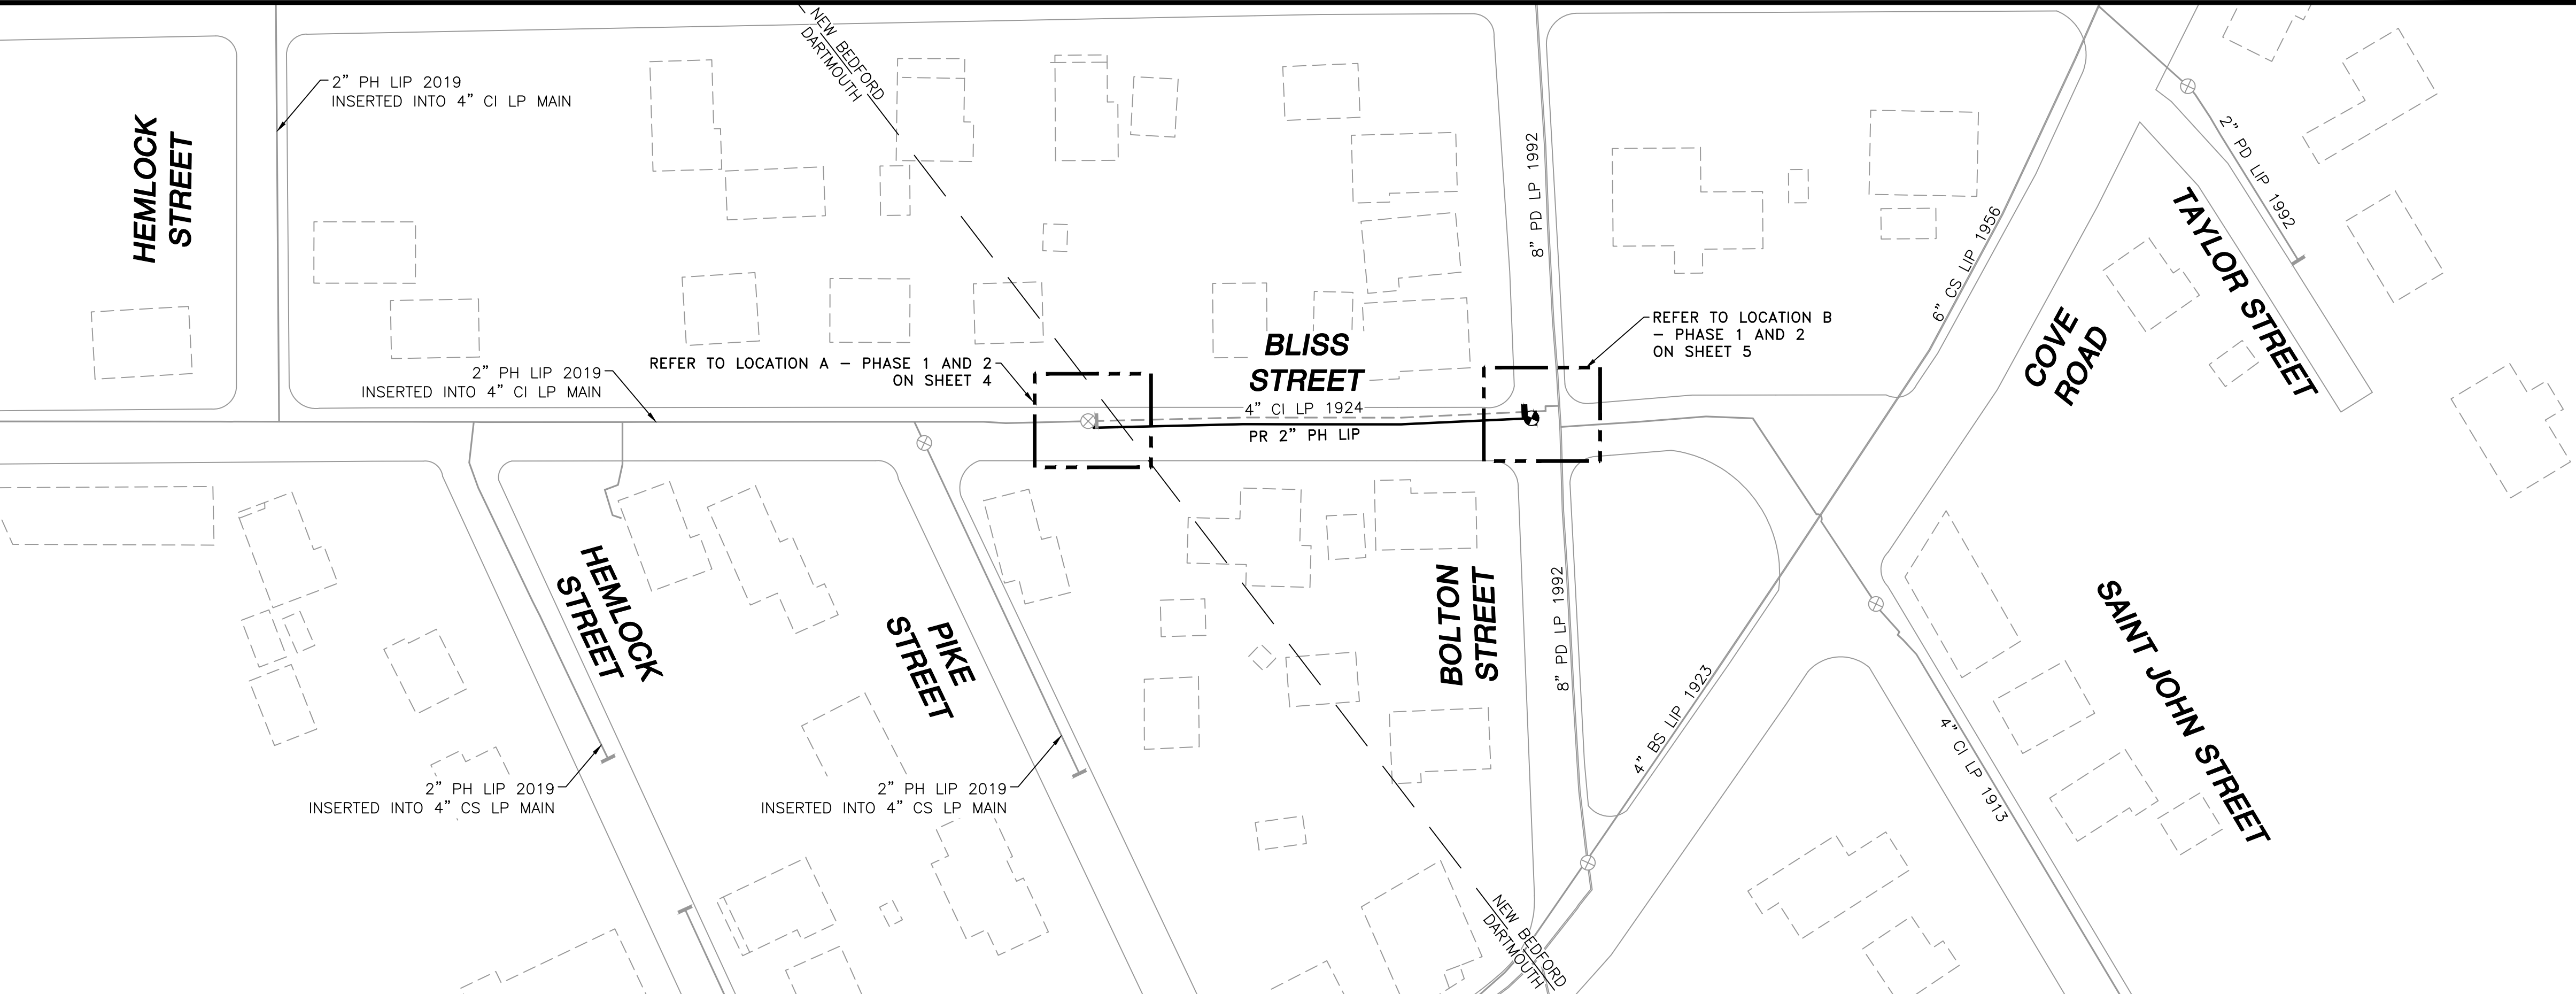

| SHEET INDEX | |
|--------------|---|
| SHEET NUMBER | DESCRIPTION |
| 1 | SITE PLAN, LOCUS PLAN AND SHEET INDEX |
| 2 | GENERAL NOTES |
| 3 | INSTALLATION PLAN |
| 4 | LOCATION A - PHASE 1, 2 AND SCHEDULE OF MATERIALS |
| 5 | LOCATION B - PHASE 1, 2 AND SCHEDULE OF MATERIALS |
| 6 | STANDARD CORROSION DETAILS |

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| 0 | ISSUED FOR CONSTRUCTION | 12/23/2020 | TG/AB/EK |
| NO. | DESCRIPTION | DATE | DW/CK/AP |

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| REVISION STATUS | | | |
| <div>EVERSOURCE</div> <div>ENERGY</div> | | | |
| BLISS STREET MAIN RELAY | | | |
| NEW BEDFORD, MASSACHUSETTS | | | |
| SITE PLAN, LOCUS PLAN AND SHEET INDEX | | | |
| SCALE: AS NOTED | | SHEET 1 OF 6 | |
| DRAWN BY / DATE TG 12/10/2020 | CHECKED BY / DATE AB 12/23/2020 | SHEET NUMBER | REV. NO. |
| APPROVED BY / DATE EK 12/23/2020 | MANEB21PIP030R0 | MA-NEB-21-PIP-030-01 | 0 |

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12/27/2020

LICENSE EXPIRATION

06/30/202

DESIGNED IN ACCORDANCE WITH TITLE 49-PART 192 OF MINIMUM FEDERAL SAFETY STANDARDS AND GPTC GUIDE FOR GAS TRANSMISSION AND DISTRIBUTION PIPING SYSTEMS. LATEST EDITION.

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FIELD VERIFY DIMENSIONS PRIOR TO PIPE FABRICATION

EVERSOURCE
ENERGY

BLISS STREET MAIN RELAY

NEW BEDFORD, MASSACHUSETTS

SITE PLAN, LOCUS PLAN AND SHEET INDEX

SCALE: AS NOTED

SHEET 1 OF 6

DRAWN BY / DATE

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GENERAL NOTES

1. IF ANY OF THE FOLLOWING OCCUR A DRAWING REVISION IS REQUIRED AND MUST BE APPROVED AND/OR STAMPED BY THE ENGINEER OF RECORD. CHANGES CAN BE APPROVED AND/OR STAMPED BY A PROJECT ENGINEER, BUT THE ENGINEER OF RECORD MUST BE INFORMED.

A. IF THE TIE IN POINT MOVES TO A DIFFERENT SEGMENT OF PIPE THAN SHOWN

B. IF A CHANGE IN THE LOCATION OF VALVES IS REQUIRED

C. IF THERE IS ANY CHANGE TO WHAT IS SHOWN ON THE DRAWING WITHIN 50 FT OF A PRESSURE REGULATING STATION, DISTRICT REGULATOR, OR GATE STATION

D. IF A CHANGE IN PIPE SIZE, MATERIAL, FITTINGS, OR WALL THICKNESS IS REQUIRED.
2. MINOR CHANGES SUCH AS OFFSETS MAY NOT REQUIRE DRAWING CHANGES.
3. EXCAVATOR SHALL CALL DIGSAFE/CALL BEFORE YOU DIG (DIAL 811) AT LEAST 72 HOURS PRIOR TO CONSTRUCTION. SATURDAYS, SUNDAYS, AND HOLIDAYS ARE EXCLUDED FROM THE 72-HOUR TIME SPAN, NOT CONSIDERED BUSINESS WORKDAYS.
4. CONSTRUCTION DRAWINGS ARE BASED ON EVERSOURCE HISTORICAL DOCUMENTATION AND HAVE NOT BEEN FIELD VERIFIED. WHEN THE PIPE IS EXPOSED AND VARIANCES TO THE CERTIFIED DRAWINGS ARE FOUND, CONTACT GAS ENGINEERING TO DETERMINE PATH FORWARD.
5. ALL WORK SHALL BE PERFORMED PER EVERSOURCE, LOCAL, STATE, OSHA, AND FEDERAL REGULATIONS AND STANDARDS.
6. MATERIAL AND CONSTRUCTION SHALL CONFORM TO EVERSOURCE GAS STANDARDS.
7. THE LOCATIONS OF EXISTING UTILITIES AND UNDERGROUND STRUCTURES ARE APPROXIMATE AND MUST BE FIELD VERIFIED. ADDITIONAL UNDERGROUND FACILITIES MAY EXIST THAT ARE NOT SHOWN ON THESE DRAWINGS WHICH MAY REQUIRE ADDITIONAL OFFSETS IN THE PIPELINE.
8. WORK LOCATIONS SHOWN ON THE DRAWINGS ARE APPROXIMATE. EXACT LOCATIONS OF TIE-INS SHALL BE DETERMINED AT THE TIME OF CONSTRUCTION TO SUIT FIELD CONDITIONS AT THE SPECIFIC TIE-IN POINT. VERIFY LOCATIONS OF ALL EXISTING UTILITIES PRIOR TO BEGINNING ANY TIE-IN WORK.
9. ALL LIVE GAS WORK INCLUDING BUT NOT LIMITED TO TAPPING OF FITTINGS ON LIVE MAINS, STOPPING, MANIPULATING VALVE, ABANDONMENT, SHALL BE PERFORMED BY, OR AT THE DIRECTION AND UNDER THE DIRECT SUPERVISION OF EVERSOURCE GAS PERSONNEL AND IN ACCORDANCE WITH THE WRITTEN PROCEDURE. DRAWING CHANGES MAY ALSO REQUIRE A CHANGE TO THE PROCEDURE.
10. EXCAVATOR IS REQUIRED TO PROTECT EXISTING UTILITIES, STRUCTURES, LANDSCAPE FEATURES, SIGNAGE, CURBS, ETC. CARE SHOULD BE TAKEN NOT TO DISTURB OR DAMAGE SUCH ROADWAY, SIDEWALKS, AND GRASS DISTURBED SHALL BE RESTORED TO THE SATISFACTION OF THE CITY OR TOWN. PLANT BEDS WILL BE RELOCATED TO THEIR EXISTING REGULAR LOCATION.
11. IF THE PROJECT IS WITHIN 50 FEET OF A DISTRICT REGULATOR OR GATE STATION, ENSURE THAT A QUALIFIED I&R TECHNICIAN IS ON SITE.
12. ALL TRAFFIC CONTROL SHALL CONFORM TO THE LATEST EDITION OF THE MANUAL OF UNIFORM TRAFFIC CONTROL DEVICES (MUTCD), INCLUDING ALL REVISIONS AND ADDENDA. ALL TRAFFIC CONTROL DEVICES WILL BE SUPPLIED BY EXCAVATOR.
13. PROPERTY LINES, STRUCTURES AND EXISTING CONDITIONS DEPICTED ON PLANS ARE BASED ON EVERSOURCE GIS INFORMATION AND HAVE NOT BEEN VERIFIED BY LAND SURVEY UNLESS NOTED.
14. EXISTING SERVICES SHOWN ON PLAN ARE FOR INFORMATION ONLY. PROPOSED SERVICES ARE NOT SHOWN ON PLANS AND ARE TO BE INSTALLED PER EVERSOURCE CONSTRUCTION STANDARDS.
15. PROPOSED WORK SHALL BE PERFORMED AND COMPLETED IN COMPLIANCE WITH ALL PERMITS AND APPROVALS.
16. MAINS AND SERVICES SHALL BE PRESSURE TESTED IN ACCORDANCE WITH EVERSOURCE OM-205.
17. MAOP:

LP = 14" W.C.

LIP = 35 PSIG


IP = 60 PSIG

HP = 90 PSIG
18. ALL WORK SHALL BE PERFORMED PER EVERSOURCE, LOCAL, STATE AND FEDERAL REGULATIONS AND STANDARDS.
19. ALL PIPE WILL BE INSTALLED WITH A MINIMUM DEPTH IN ACCORDANCE WITH EVERSOURCE STANDARDS
20. SQUEEZE OPERATIONS SHOULD BE COMPLETED IN ACCORDANCE WITH OM-233
21. ENSURE ALL SERVICES BEING TRANSFERRED TO A HIGHER PRESSURE SYSTEM HAVE UPGRADED PRESSURE REGULATORS INSTALLED PRIOR TO ACTIVATION.
22. ENSURE VALVES ON EXISTING MAIN, WHERE PROPOSED MAIN WILL BE INSERTED HAVE BEEN MADE INOPERABLE.
23. ADDITIONAL VALVES AND TEES THAT ARE INCLUDED IN THE SCHEDULE OF MATERIALS MAY BE INSTALLED TEMPORARILY WHEN NEEDED TO FACILITATE TIE-INS AND PURGES.
24. METFIT FITTINGS MAY BE SUBSTITUTED FOR ELECTROFUSION FITTINGS WHERE NEEDED.
25. DO NOT SCALE FROM DRAWINGS.

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
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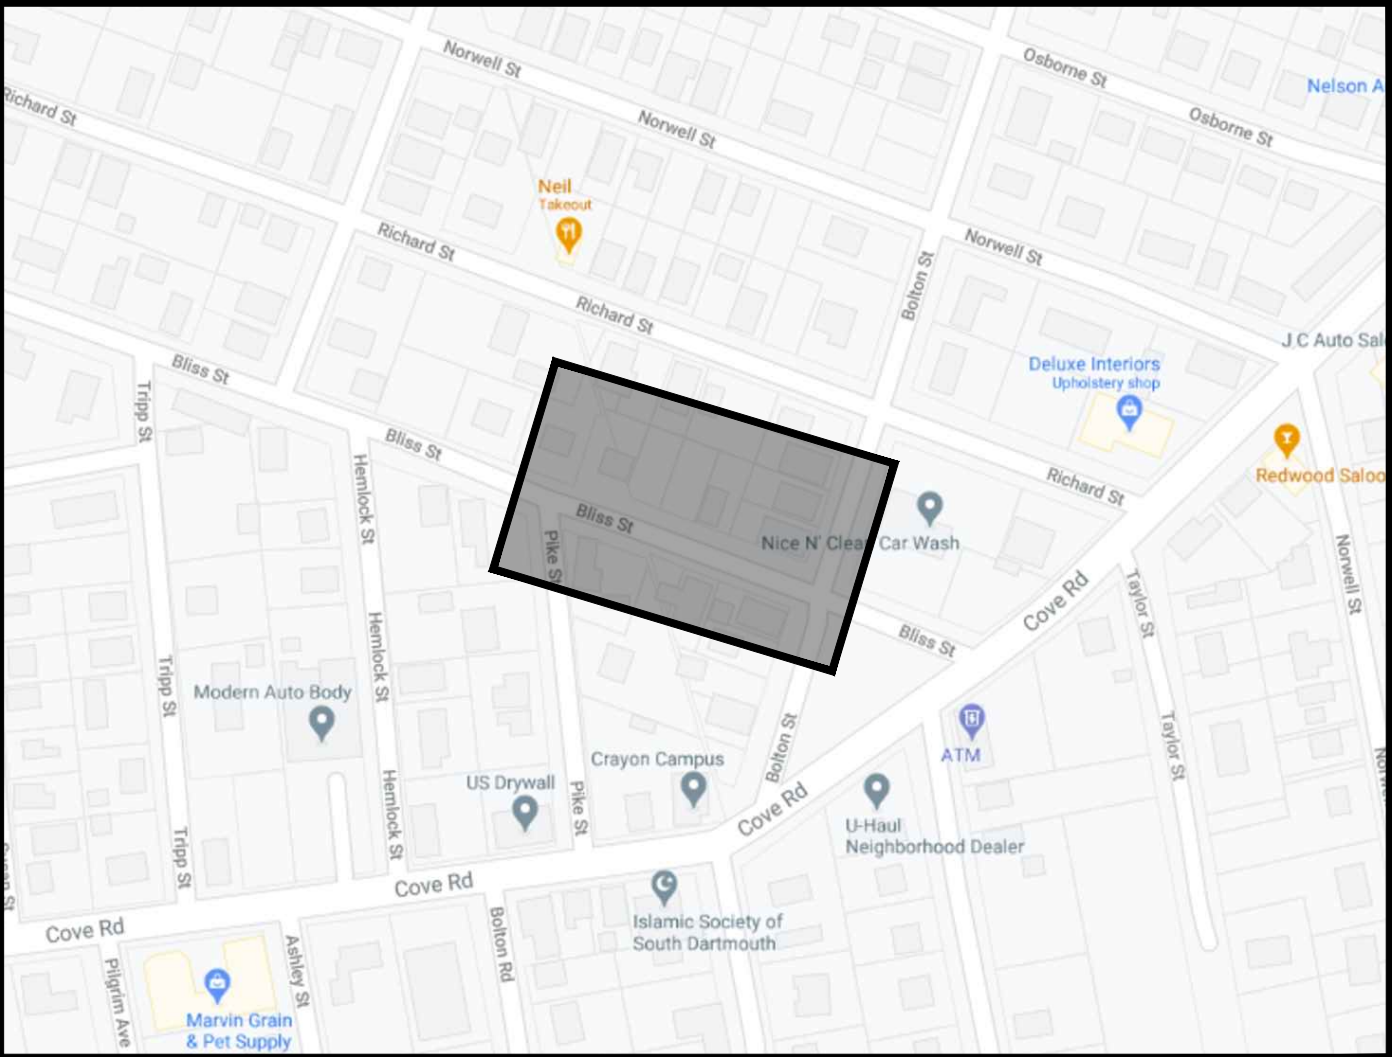
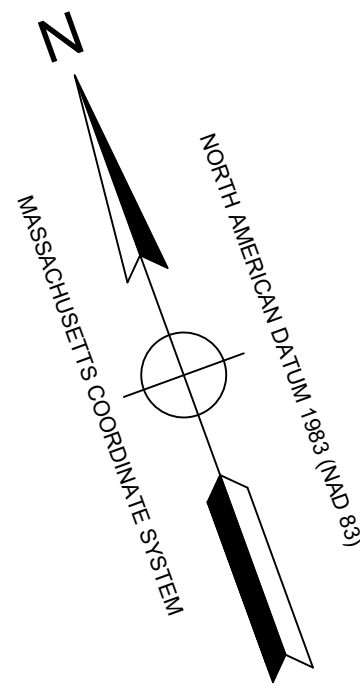



BLISS STREET MAIN RELAY
NEW BEDFORD, MASSACHUSETTS
GENERAL NOTES

SCALE: NOT TO SCALE





























SHEET 2 OF 6


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 **LOCUS PLAN**
NOT TO SCALE

DRAWING LEGEND

| | | | |
|---|-------------------|---|-------------------|
|  | UTILITY POLE |  | EXISTING GAS MAIN |
|  | LIGHT POLE |  | RETIRED GAS MAIN |
|  | CATCH BASIN |  | PROPOSED GAS MAIN |
|  | FIRE HYDRANT |  | EXISTING SERVICE |
|  | UTILITY MANHOLE |  | RIGHT OF WAY |
|  | ELECTRIC MANHOLE |  | ELECTRIC |
|  | TELEPHONE MANHOLE |  | TELEPHONE |
|  | WATER MANHOLE |  | WATER |
|  | SANITARY MANHOLE |  | SANITARY SEWER |
|  | STORM MANHOLE |  | STORM SEWER |
|  | EXISTING REDUCER |  | PROPOSED REDUCER |
|  | EXISTING CAP |  | PROPOSED CAP |
|  | EXISTING VALVE |  | PROPOSED VALVE |
|  | EXISTING COUPLING |  | PROPOSED ANODE |



- NOTES:
- REFER TO GENERAL NOTES ON SHEET #2.
 - CONTRACTOR TO POTHOLE EXISTING UTILITIES AT CROSSING LOCATIONS PRIOR TO CONSTRUCTION.
 - HDPE, 4710, SDR 11 ELBOWS TO BE INSTALLED AS REQUIRED TO FACILITATE OFFSETS BASED ON FIELD CONDITIONS.
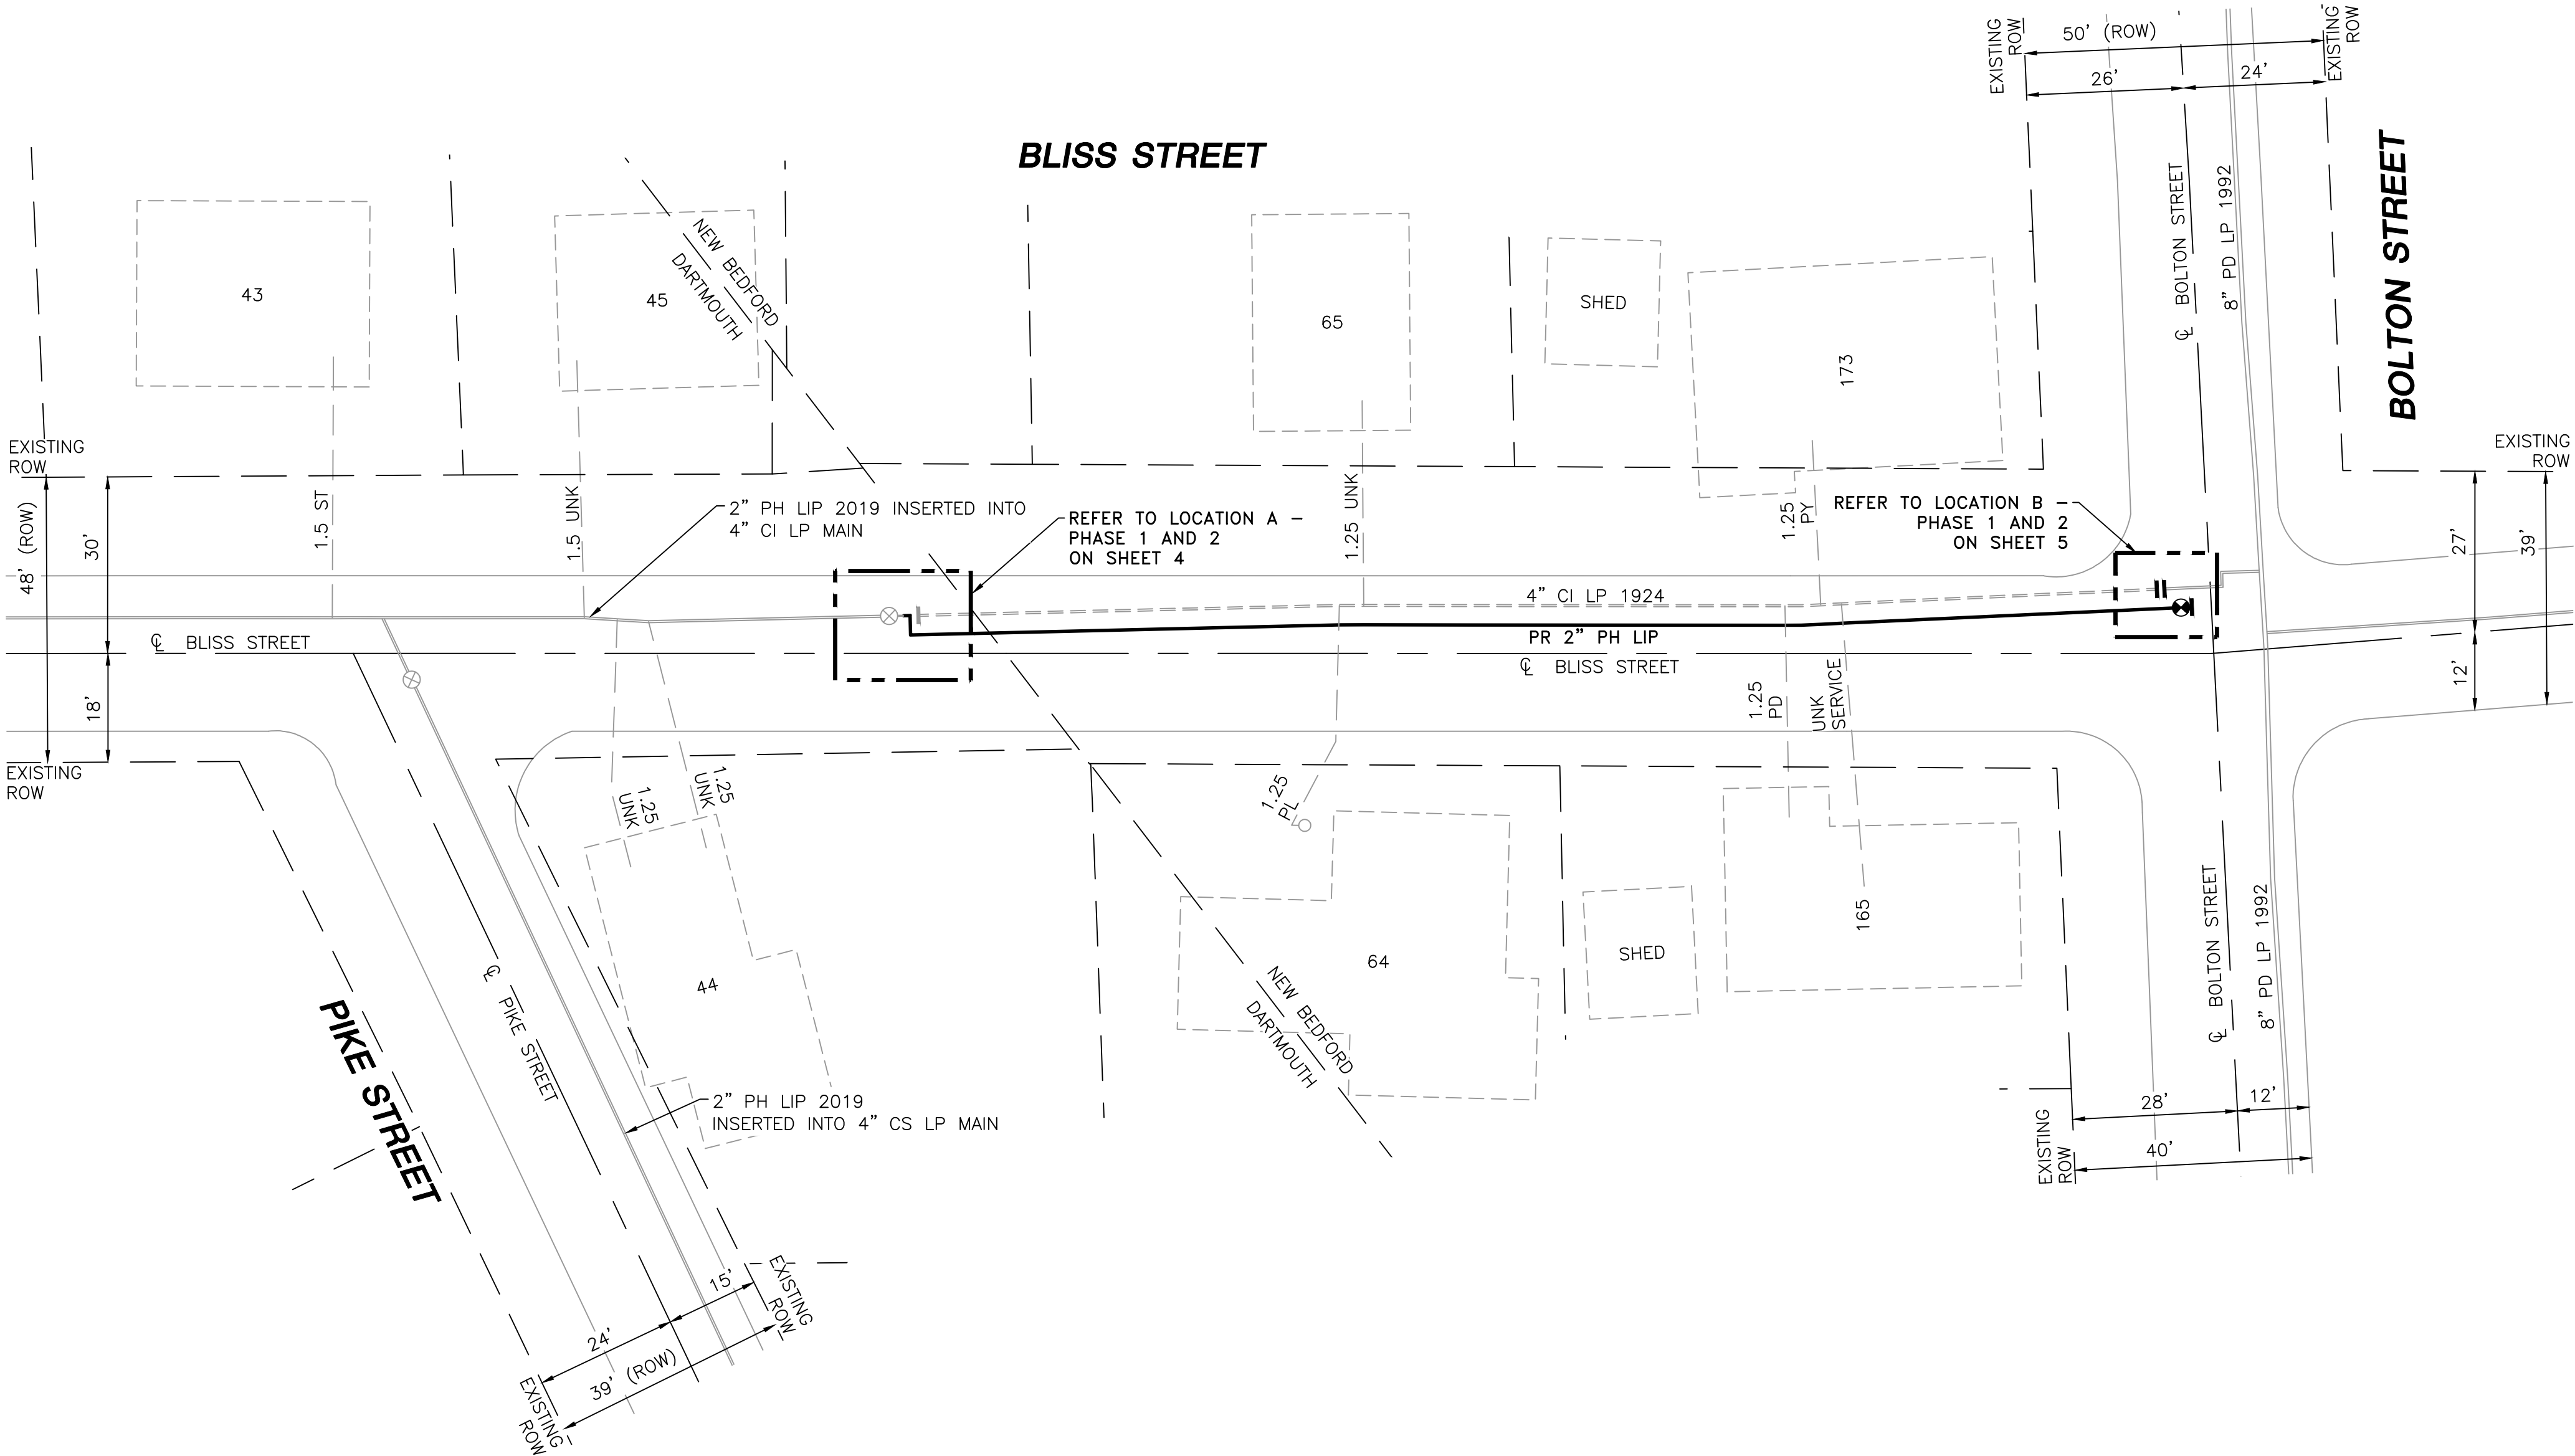
| LENGTH | SIZE | MATERIAL | DESCRIPTION |
|--------|------|----------|-------------|
| 220' | 2" | PH | INSTALL |
| 210' | 4" | CI | RETIRE |

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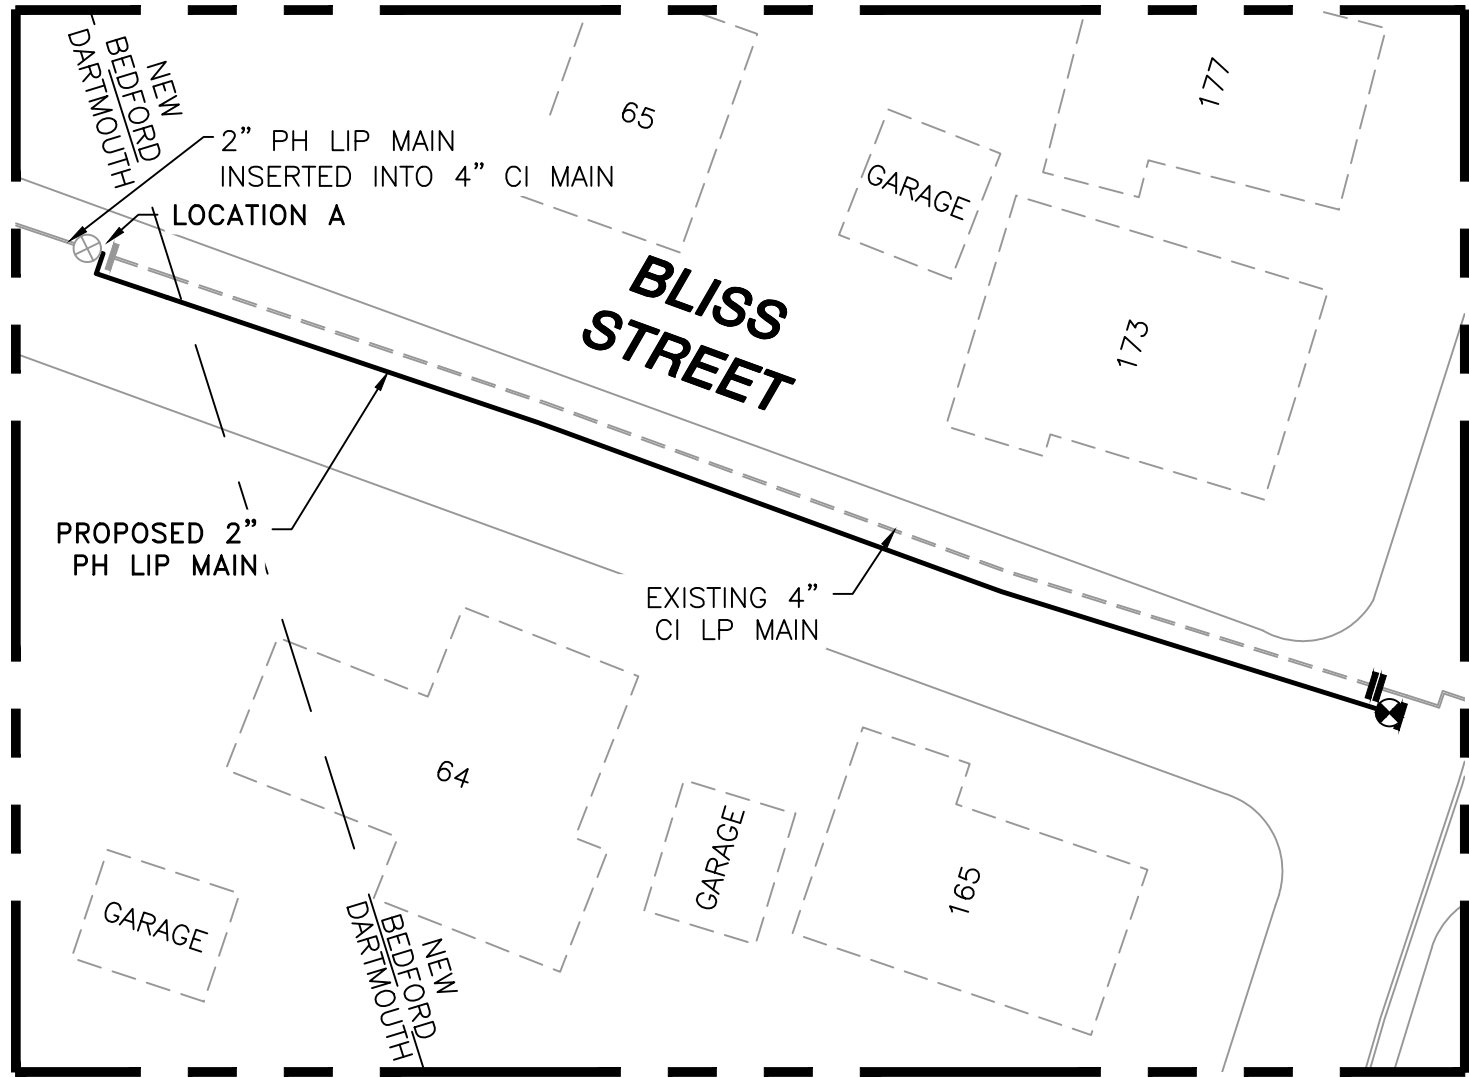
REVISION STATUS

EVERSOURCE
ENERGY


BLISS STREET MAIN RELAY
NEW BEDFORD, MASSACHUSETTS

INSTALLATION PLAN


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| SCALE: 1"=20' (DO NOT SCALE FROM DRAWINGS) | | SHEET 3 OF 6 | |
| DRAWN BY / DATE TG 12/10/2020 | CHECKED BY / DATE AB 12/23/2020 | SHEET NUMBER MA-NEB-21-PIP-030-03 | REV. NO. 0 |
| APPROVED BY / DATE EK 12/23/2020 | MANEB21PIP030R0 | | |



LOCATION A - PLAN VIEW
(SCALE: 1"=30')
(REFER TO SHEET #3)
(DO NOT SCALE FROM DRAWINGS)

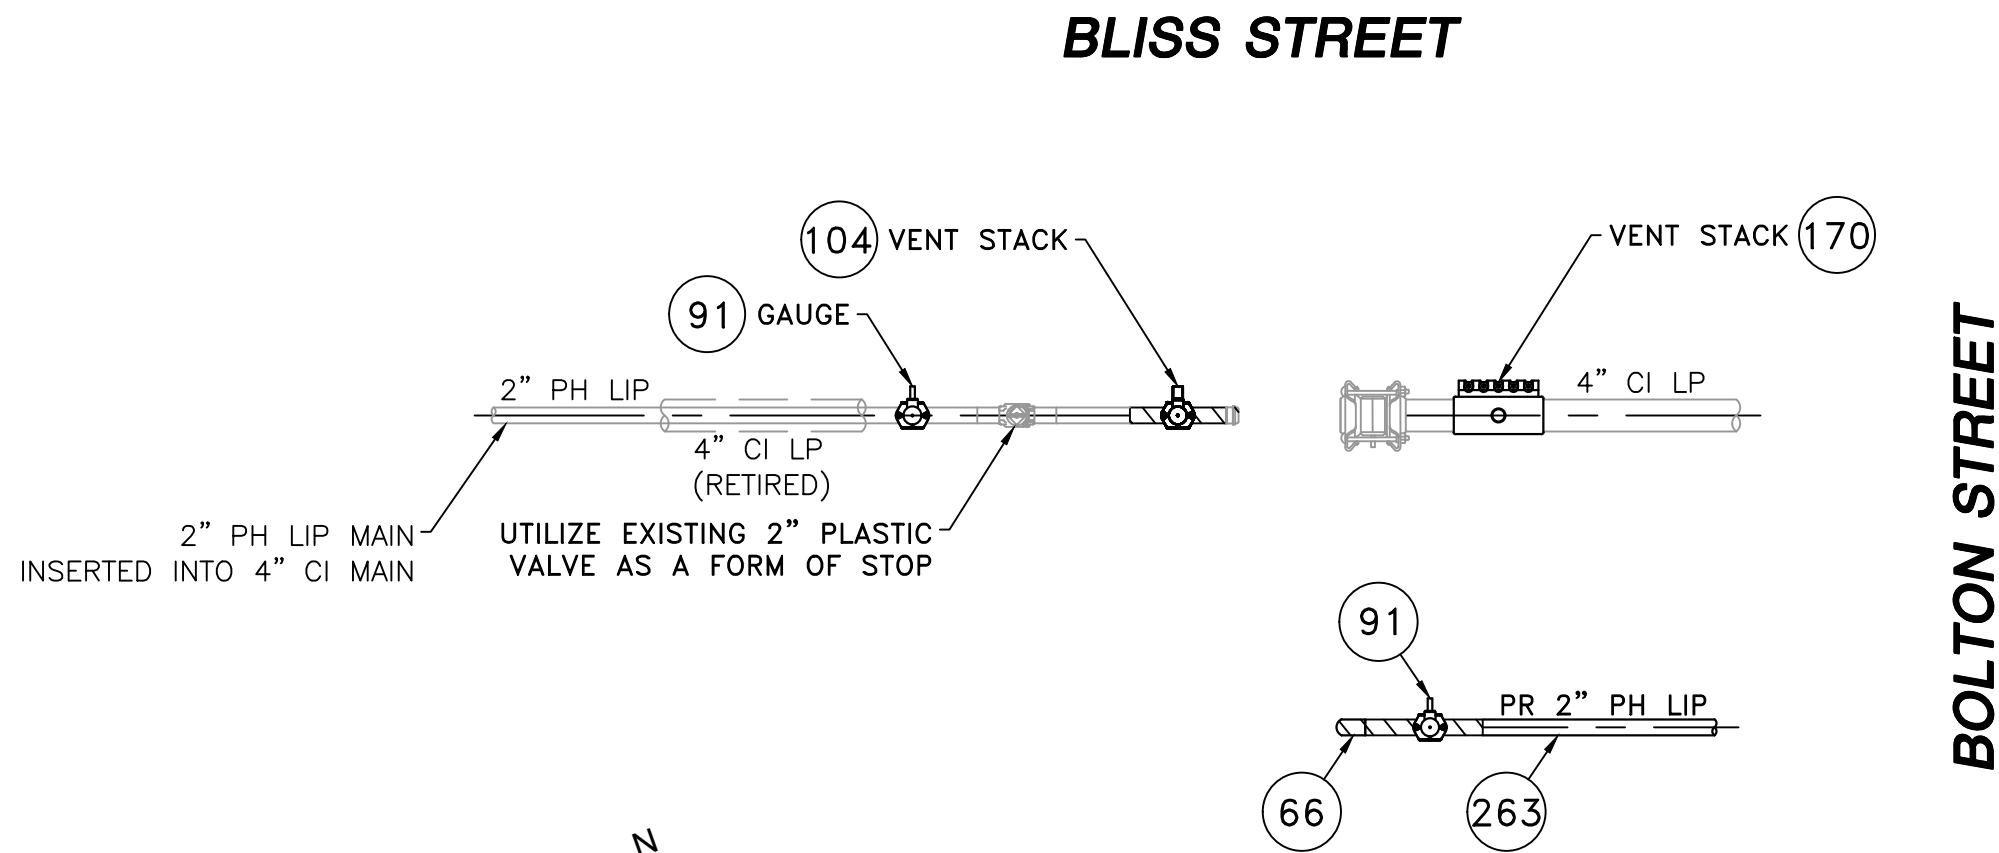

LOCATION A - PHASE 1
(SCALE: 1"=2')
(REFER TO SHEET #3)
(DO NOT SCALE FROM DRAWINGS)

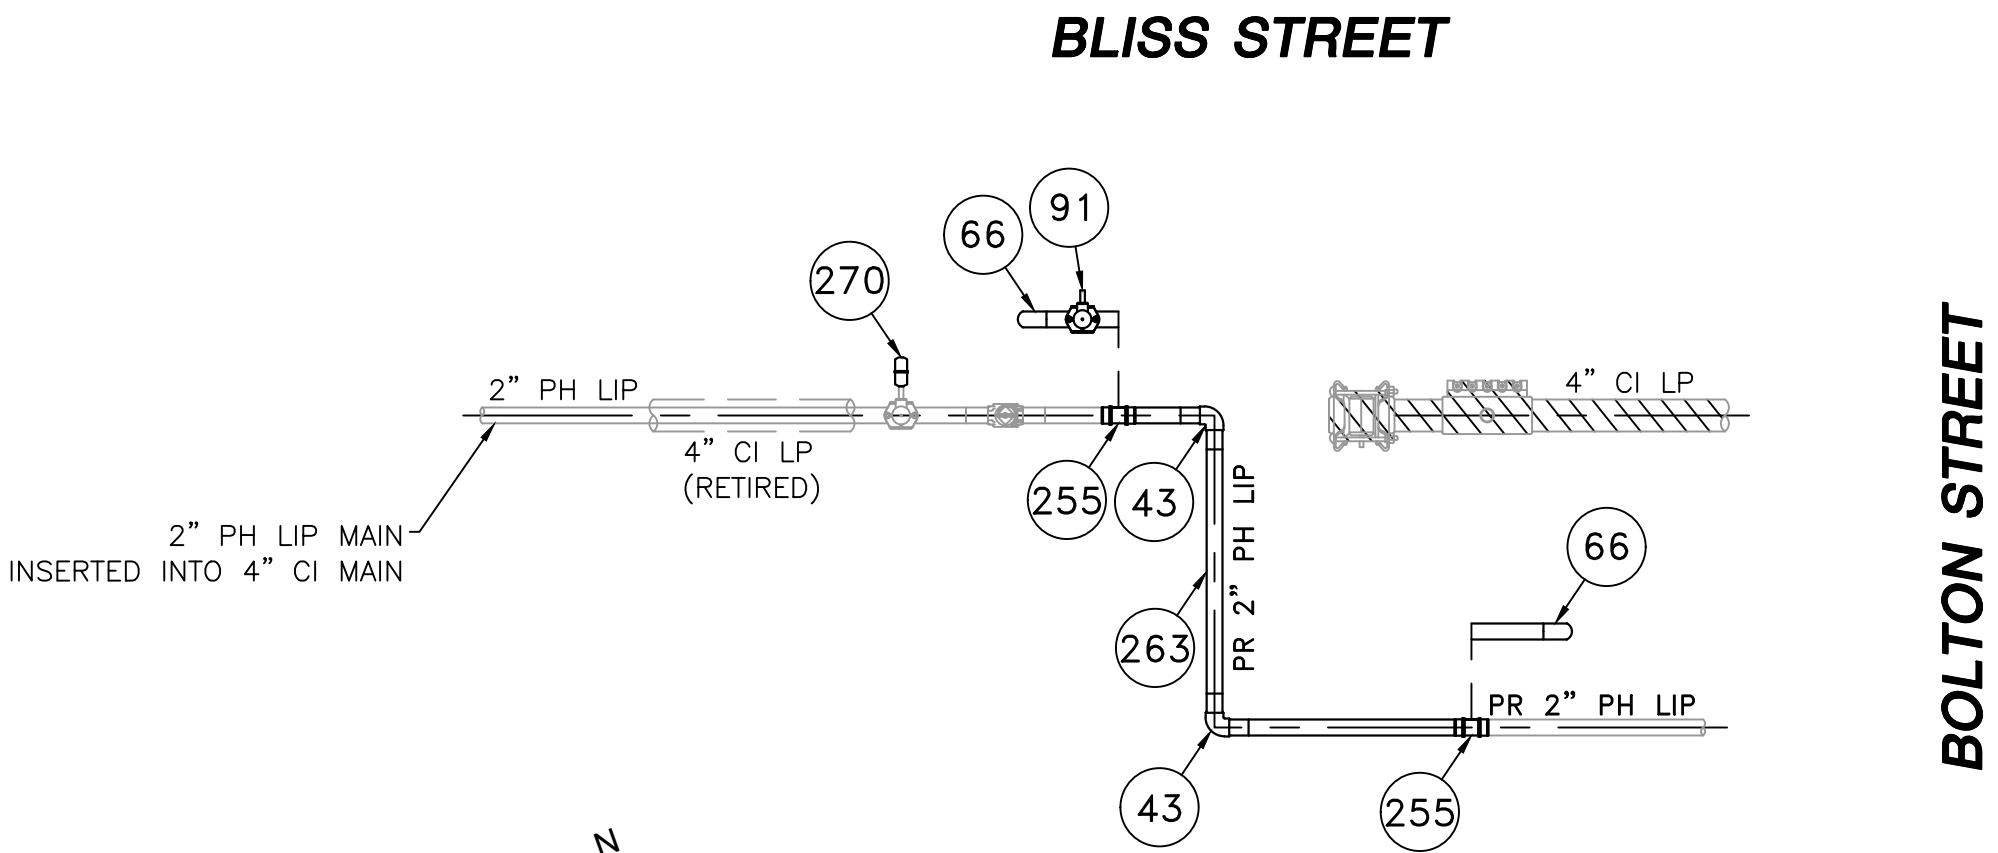

LOCATION A - PHASE 2
(SCALE: 1"=2')
(REFER TO SHEET #3)
(DO NOT SCALE FROM DRAWINGS)

| BLISS STREET MAIN RELAY - LOCATION A - SCHEDULE OF MATERIALS | | | | | |
|--|-------------|-----------|------------|--|------------|
| ITEM | QTY | SIZE | MAXIMO NO. | DESCRIPTION | MATERIAL |
| 43 | AS REQUIRED | 2" | 545367 | ELBOW, 90 DEG, BUTT FUSION, IPS, HDPE 4710, SDR 11, ASTM D2513, ASTM D3350, ASTM D3261. PERFORMANCE PIPE OR APPROVED EQUAL. | ASTM D2513 |
| 66 | AS REQUIRED | 2" | 542572 | CAP, BUTT FUSION, IPS, HDPE 4710, SDR 11, ASTM D2513, ASTM D3350, ASTM D3261. PERFORMANCE PIPE OR APPROVED EQUAL. | ASTM D2513 |
| 91 | 3 | 2" X 1/2" | 500866 | TAPPING TEE, ELECTROFUSION, IPS X CTS, HDPE 3408/4710, SDR 11, ASTM D2513, ASTM D3350, ASTM D3261 ASTM F1055. CENTRAL PLASTICS OR APPROVED EQUAL. | ASTM D2513 |
| 104 | 1 | 2" X 1" | 560779 | TAPPING TEE, ELECTROFUSION, IPS X IPS, HDPE 3408/4710, SDR 11, ASTM D2513, ASTM D3350, ASTM D3261, ASTM F1055. CENTRAL PLASTICS OR APPROVED EQUAL. | ASTM D2513 |
| 170 | 1 | 4" x 2" | 543028 | BAND CLAMP, WITH WELDED 2" FNPT SERVICE OUTLET, 304L SS SINGLE SECTION BAND AND GAP BRIDGES, SS STUDS WITH TEFLON COATED HEX NUTS, COMPLETELY LINED WITH NITRILE RUBBER GASKET. MUELLER 540 SERVI-SEAL OR APPROVED EQUAL. COMPLETE WITH PLUG. | |
| 255 | AS REQUIRED | 2" | 579840 | COUPLING, MECHANICAL COMPRESSION, SDR 11 IPS, DUPONT ZYTEL ST-801 NYLON BODY, 316 SS COMPRESSION RING, INTERNAL STIFFENER, ASTM D-2513, ASTM F1924. METFIT OR APPROVED EQUAL. | ASTM D2513 |
| 263 | 10' | 2" | 554025 | PIPE, IPS, HDPE 3408/4710 SDR 11, ASTM D2513, ASTM D3350, PERFORMANCE PIPE OR APPROVED EQUAL | ASTM D2513 |
| 270 | AS REQUIRED | 1/2" | 542609 | END CAP, MECHANICAL STAB, CTS, HDPE, PE 4710/3408, ASTM D2513, WITH SS GRIPPING SUPPORT RING, ACETAL COLLET AND SPACER RETAINER RING, PE THRUST WASHER, BUNA-N O-RING, ZINC-PLATED CS INSERT STIFFENER, PERFECTION WITH END CAP OR APPROVED EQUAL. | ASTM D2513 |

NOTE:
1. REFER TO GENERAL NOTES ON SHEET #2.

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| BLISS STREET MAIN RELAY | | | |
| NEW BEDFORD, MASSACHUSETTS | | | |
| LOCATION A - PHASE 1, 2 AND SCHEDULE OF MATERIALS | | | |
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| EK 12/23/2020 | | | |


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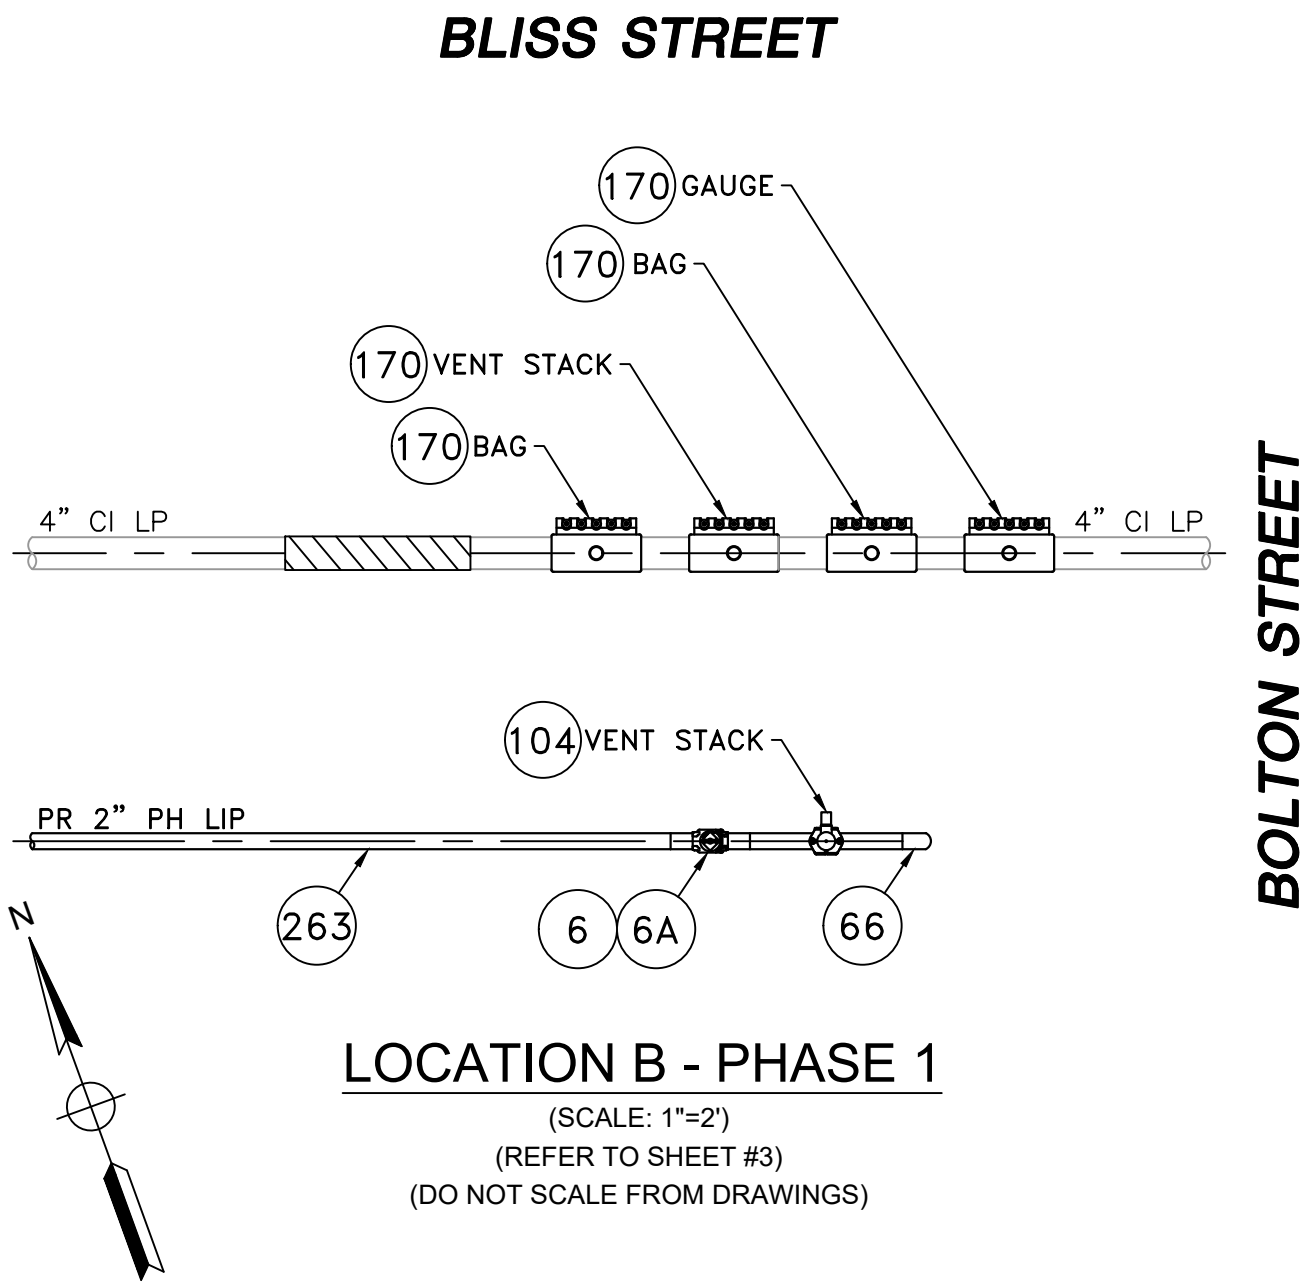
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LICENSE EXPIRATION:
06/30/2022

DESIGNED IN ACCORDANCE WITH TITLE 49, PART 192 OF MINIMUM FEDERAL SAFETY STANDARDS AND GPTC GUIDE FOR GAS TRANSMISSION AND DISTRIBUTION PIPING SYSTEMS, LATEST EDITION.
ENEngineering
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MARLBOROUGH, MA 01752
TEL (630) 353-4000
FAX (630) 353-7777
WWW.ENENGINEERING.COM

FIELD VERIFY DIMENSIONS
PRIOR TO PIPE FABRICATION




LOCATION B - PLAN VIEW
(SCALE: 1"=30")
(REFER TO SHEET #3)
(DO NOT SCALE FROM DRAWINGS)

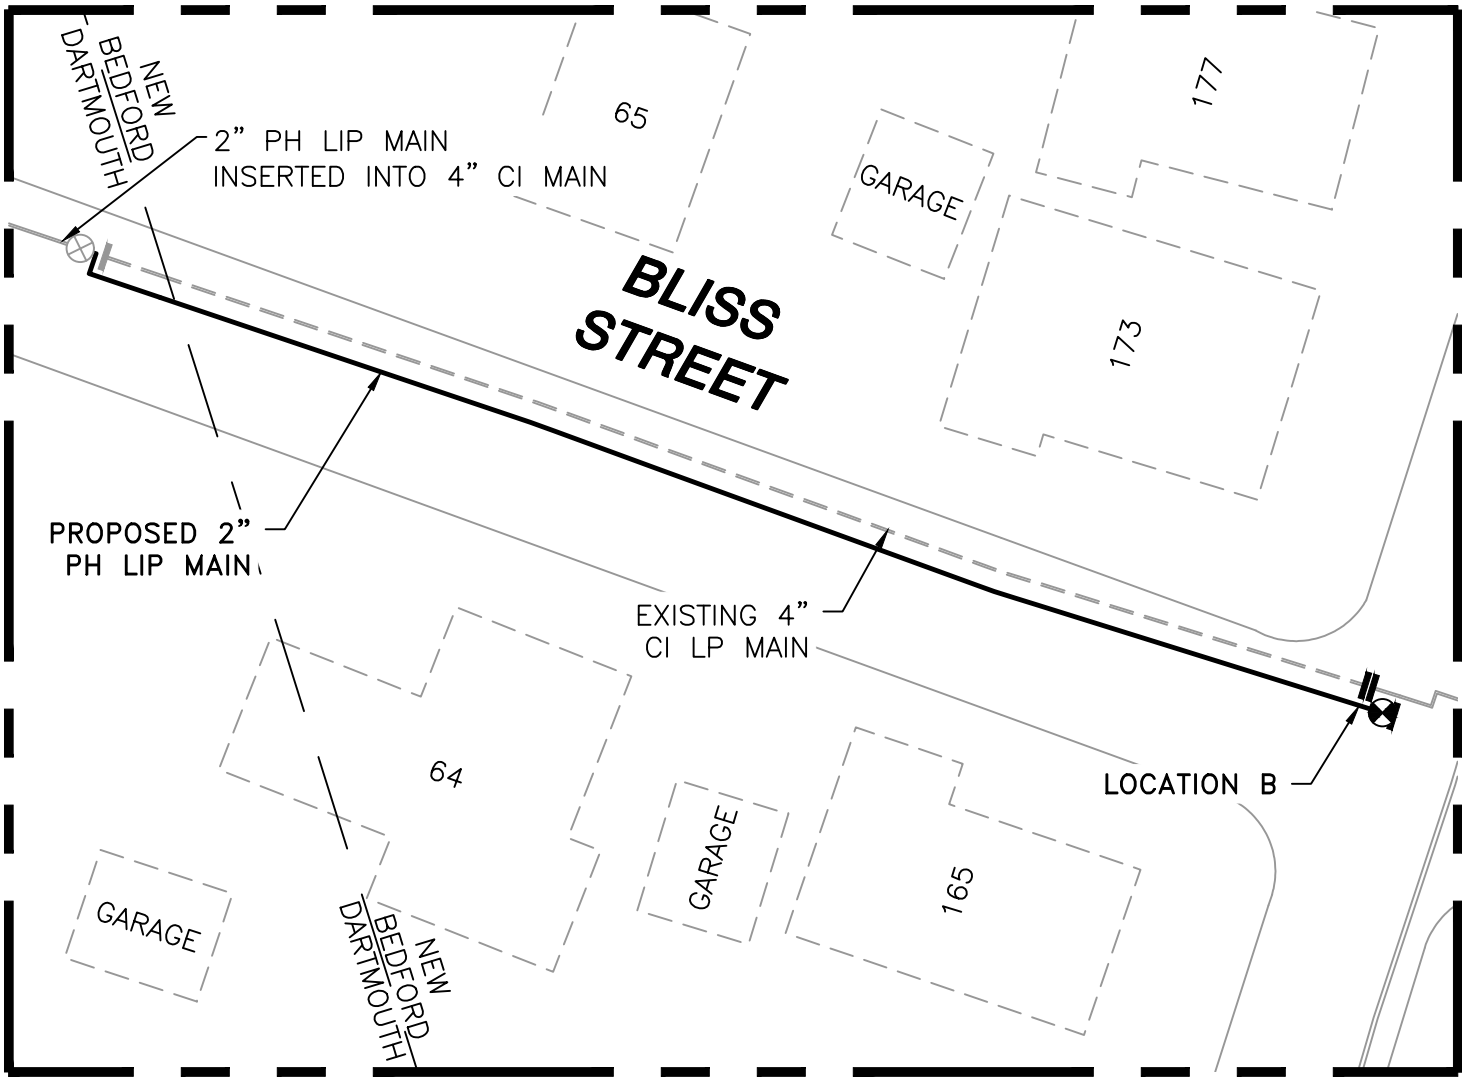

LOCATION B - PHASE 1
(SCALE: 1"=2")
(REFER TO SHEET #3)
(DO NOT SCALE FROM DRAWINGS)

| BLISS STREET MAIN RELAY - LOCATION B - SCHEDULE OF MATERIALS | | | | | |
|--|-------------|---------|------------|--|------------|
| ITEM | QTY | SIZE | MAXIMO NO. | DESCRIPTION | MATERIAL |
| 6 | 1 | 2" | 562087 | BALL VALVE, BUTT FUSION, IPS, HDPE 3408/4710, SDR 11, ASTM D2513, ASME B16.40. FULL PORT, 1/4 TURN, KEROTEST POLYBALL OR APPROVED EQUAL. | ASTM D2513 |
| 6A | 1 | 2" | | BOX, VALVE, PLASTIC, SNAP-ON, ADJ, W/CI NON-LOCKING LID | PLASTIC |
| 66 | AS REQUIRED | 2" | 542572 | CAP, BUTT FUSION, IPS, HDPE 4710, SDR 11, ASTM D2513, ASTM D3350, ASTM D3261. PERFORMANCE PIPE OR APPROVED EQUAL. | ASTM D2513 |
| 104 | 1 | 2" X 1" | 560779 | TAPPING TEE, ELECTROFUSION, IPS X IPS, HDPE 3408/4710, SDR 11, ASTM D2513, ASTM D3350, ASTM D3261, ASTM F1055. CENTRAL PLASTICS OR APPROVED EQUAL. | ASTM D2513 |
| 152 | 2 | 4" | 578128 | END CAP, BOLTED MECHANICAL, CIP. SMITH-BLAIR MAXI-GRIP OR APPROVED EQUAL | |
| 170 | 4 | 4" x 2" | 543028 | BAND CLAMP, WITH WELDED 2" FNPT SERVICE OUTLET, 304L SS SINGLE SECTION BAND AND GAP BRIDGES, SS STUDS WITH TEFLON COATED HEX NUTS, COMPLETELY LINED WITH NITRILE RUBBER GASKET. MUELLER 540 SERVI-SEAL OR APPROVED EQUAL. COMPLETE WITH PLUG. | |
| 263 | 10' | 2" | 554025 | PIPE, IPS, HDPE 3408/4710 SDR 11, ASTM D2513, ASTM D3350, PERFORMANCE PIPE OR APPROVED EQUAL | ASTM D2513 |
| 272 | AS REQUIRED | 1" | 542612 | END CAP, MECHANICAL STAB, IPS, HDPE, PE 4710/3408, ASTM D2513, WITH SS GRIPPING SUPPORT RING, ACETAL COLLET AND SPACER RETAINER RING, PE THRUST WASHER, BUNA-N O-RING, ZINC-PLATED CS INSERT STIFFENER, PERFECTION WITH END CAP OR APPROVED EQUAL. | ASTM D2513 |

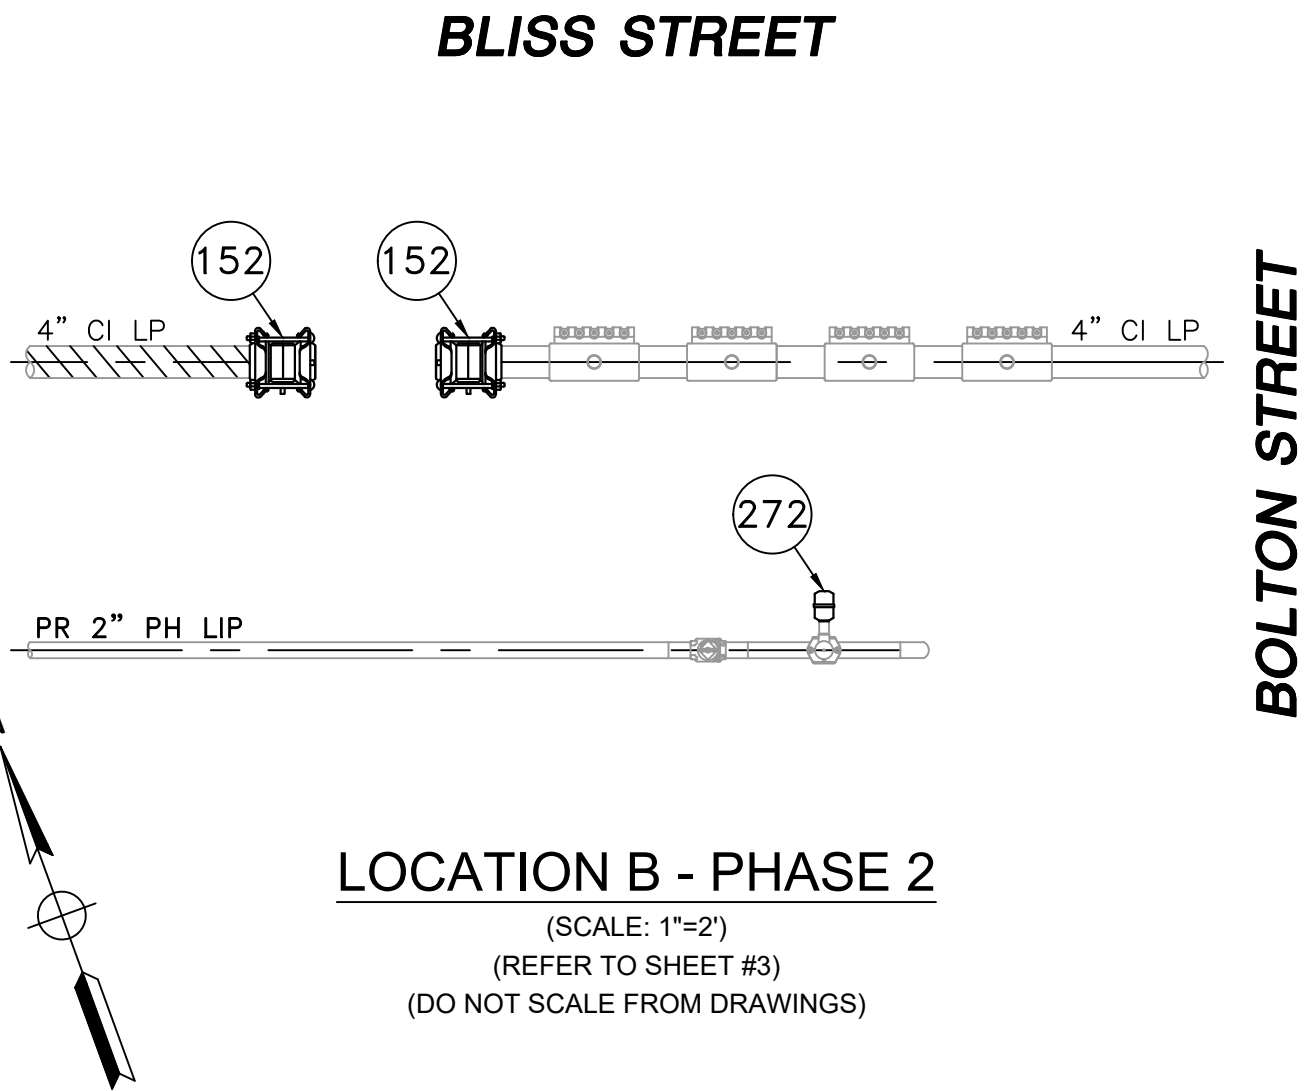

LOCATION B - PHASE 2
(SCALE: 1"=2")
(REFER TO SHEET #3)
(DO NOT SCALE FROM DRAWINGS)

NOTE:
1. REFER TO GENERAL NOTES ON SHEET #2.

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| 0 | ISSUED FOR CONSTRUCTION | 12/23/2020 | TG/AB/EK |
| NO. | DESCRIPTION | DATE | DW/CK/AP |
| REVISION STATUS | | | |
| EVERSOURCE ENERGY | | | |
| BLISS STREET MAIN RELAY | | | |
| NEW BEDFORD, MASSACHUSETTS | | | |
| LOCATION B - PHASE 1, 2 AND SCHEDULE OF MATERIALS | | | |
| SCALE: AS NOTED | | SHEET 5 OF 6 | |
| DRAWN BY / DATE TG 12/10/2020 | CHECKED BY / DATE AB 12/23/2020 | SHEET NUMBER | REV. NO. |
| APPROVED BY / DATE EK 12/23/2020 | MANEB21PIP030R0 | MA-NEB-21-PIP-030-05 | 0 |

SEALED BY:

SIGNATURE

SEALED ON:

12/27/2020

LICENSE EXPIRATION:





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| CATHODIC PROTECTION BILL OF MATERIALS | | | | |
|---------------------------------------|-----|------|------------|--|
| ITEM | QTY | SIZE | MAXIMO NO. | DESCRIPTION |
| 396 | X | EA | 577776 | ANODE,BAG, 17 LB NET, HIGH POTENTIAL MAGNESIUM, W/ 10 FT #10 AWG TW ORANGE LEAD WIRE, PACKED IN CARDBOARD BOX 42 LB TOTAL WEIGHT |
| 397 | X | EA | 517626 | CONNECTOR, SPLIT BOLT, 12 SOLID - 10 STRANDED, CU TO CU, HOUSING (COVER) MATE IN 590389, |
| 398 | X | EA | 590389 | HOUSING, 50 V MAX, 10 AWG MAX, FOR PROTECTING TRACER WIRE SPLICES, USED WITH CONNECTOR IN 517626. 10/BAG |
| 399 | X | EA | 590871 | BOX VALVE, TEST STATION, CP TEST #178, 10-1/4 IN DIA, LID, 8-3/8 IN I.D. 16 IN H., ASTM A48 CL 25 CAST IRON, FOR OFF-ROAD USE ONLY |
| 400 | X | BOX | 508567 | POWDER, CARTRIDGE, TYPE IS F-33, ALLOY , CAP COLOR CLEAR, 15 GM CHARGE, 20/PAC, FOR STEEL PIPE |
| 401 | X | EA | 559168 | SLEEVE,ELECTRICAL, #14 TO 10 AWG, W/ THERMITE WELDER, FOR CATHODIC PROTECTION |
| 402 | X | ES | 584045 | EDI CONCENTRIC COUPON ASSEMBLY INCLUDING UCB-ZIN-LW010, 10 FT OF CABLE |
| 403 | X | ES | 603126 | EDI CONCENTRIC COUPON ASSEMBLY INCLUDING UCB-ZIN-LW025, 25 FT OF CABLE |
| 404 | X | ROLL | 603140 | WIRE,ELECTRICAL, THHN, 1/C, #10 AWG, STRANDED, RED, INSULATED, CU, 500 FT SPOOL, WIRE |
| 405 | X | ROLL | 578415 | WIRE,ELECTRICAL, THHN, 1/C, #10 AWG, STRANDED, WHITE, INSULATED, CU, 500 FT SPOOL, WIRE |
| 406 | X | ROLL | 603141 | WIRE,ELECTRICAL, THHN, 1/C, #10 AWG, STRANDED, BLUE INSULATED, CU, 500 FT SPOOL, WIRE |
| 407 | X | ROLL | 603139 | WIRE,ELECTRICAL, THHN, 1/C, #10 AWG, STRANDED, BLACK, INSULATED, CU, 500 FT SPOOL,WIRE |
| 408 | X | EA | 500804 | WELDER,THERMITE, THERMITE, FOR GAS PIPE, #12 CABLE,HORIZONTAL STEEL PIPE 4 IN AND LARGER DIAMETER |
| 409 | X | EA | 500805 | WELDER,THERMITE, THERMITE, FOR GAS PIPE, #12 CABLE, HORIZONTAL STEEL PIPE 3/4 - 3-1/2 IN DIAMETER |
| 410 | X | FT | 513850 | CABLE, INSULATED, CATHODIC PROTECTION, 1/C, #4 AWG, 7 STR, 600 V, BLACK, HMWPE, CU, 1000 FT ROLLS |

- NOTES:**
- ALL TEST STATION BOXES SHOULD BE INSTALLED IN A SAFE LOCATION WHERE ONE INDIVIDUAL CAN SAFELY OPEN AND ACCESS THE TEST WIRES. ALL TEST WIRES INSIDE THE BOX SHOULD HAVE ENOUGH SLACK ON THE WIRES SO THEY CAN EXTEND A MINIMUM OF 12" ABOVE GRADE.
 - FOR TYPE A TEST STATIONS, THE TWO WIRES SHOULD BE THERMITE WELDED TO THE COATED STEEL MAIN AND BE THE SAME COLOR. (COUPONS COULD BE ADDED TO THE TEST STATION TYPE).
 - FOR TYPE B TEST STATIONS, EACH OF THE FOUR WIRES SHOULD BE A DIFFERENT COLOR AND DOCUMENTED
 - FOR TYPE C TEST STATIONS, THE WIRES SHOULD BE THE SAME COLOR ON EACH SIDE OF THE INSULATED COUPLING. (ANODES AND/OR COUPONS COULD BE ADDED TO THIS TEST STATION TYPE).
 - FOR TYPE D TEST STATIONS WHICH ARE AT A CASING, WHITE WIRES ARE NORMALLY INSTALLED ON THE STEEL CASING AND BLACK WIRES ON INSTALLED ON THE CARRIER PIPE. (ANODES AND/OR COUPONS COULD BE ADDED TO THIS TEST STATION TYPE).
 - FOR TYPE M TEST STATIONS, THE TWO WIRES THERMITE WELDED TO THE CARRIER PIPE SHOULD BE THE SAME COLOR WIRE. THERE IS ALSO MAGNESIUM ANODE(S) WIRE(S) LOCATED INSIDE THE TEST STATION BOX.THE WIRE COLOR (TYPICALLY ORANGE) FOR THE ANODES. IF THE ANODE WIRES ARE SPliced TO A COMMON ANODE HEADER CABLE, THE ANODE HEADER CABLE SHOULD BE A (WHITE OR RED) DIFFERENT COLOR WIRE THAN THE WIRE THAT WAS THERMITE WELDED TO THE CARRIER PIPE. AT A TYPE M TEST STATION, NO MAGNESIUM ANODES SHOULD BE DIRECTLY THERMITE WELDED TO THE CARRIER PIPE OR IN CONTACT WITH THE CARRIER PIPE. THE ANODE HEADER WIRE OR INDIVIDUAL ANODE WIRES SHOULD TERMINATE INSIDE THE TEST STATION BOX. ANODES SHOULD BE SPACED A MINIMUM OF 5' ON CENTER FROM EACH OTHER AND A MINIMUM OF 12" AWAY AND BELOW THE BOTTOM OF THE STEEL MAIN.
 - IF COUPONS ARE TO BE INSTALLED , FIRST REMOVE THE PROTECTIVE LABEL COVERING THE STEEL COUPON AND THE RED STICKERS COVERING EACH SENSING PORT. CLEAN THE ENTIRE STEEL COUPON SURFACE WITH ALCOHOL TO REMOVE THE CORROSION INHIBITOR .PLACE THE COUPON ASSEMBLY APPROXIMATELY 12" FROM THE GAS MAIN BEING MONITORED WITH THE SENSING PORTS FACING THE GAS MAIN. THE COUPON ASSEMBLY SHOULD BE LOCATED ADJACENT TO THE BOTTOM PORTION OF THE GAS MAIN, ANYWHERE BETWEEN 3 O'CLOCK AND 9 O'CLOCK. THE SOIL BETWEEN THE COUPON AND THE MAIN SHOULD BE WELL COMPACTED AND CONTAIN NO ROCKS LARGER THAN A CENTIMETER IN DIAMETER OR FOREIGN MATERIAL.

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| NO. | DESCRIPTION | DATE | DW/CK/AP |

| REVISION STATUS | | | |
|---|-------------------|----------------------|--------------|
| EVERSOURCE ENERGY | | | |
| BLISS STREET MAIN RELAY | | | |
| NEW BEDFORD, MASSACHUSETTS | | | |
| STANDARD CORROSION DETAILS | | | |
| SCALE: 1"=2' (DO NOT SCALE FROM DRAWINGS) | | | SHEET 6 OF 6 |
| DRAWN BY / DATE | CHECKED BY / DATE | SHEET NUMBER | REV. NO. |
| TG 12/10/2020 | AB 12/23/2020 | MA-NEB-21-PIP-030-06 | 0 |
| APPROVED BY / DATE | | | |
| EK 12/23/2020 | | | |

*THESE DETAILS WERE PROVIDED BY EVERSOURCE FOR TYPICAL INSTALLATIONS AND ARE FOR REFERENCE USE ONLY.

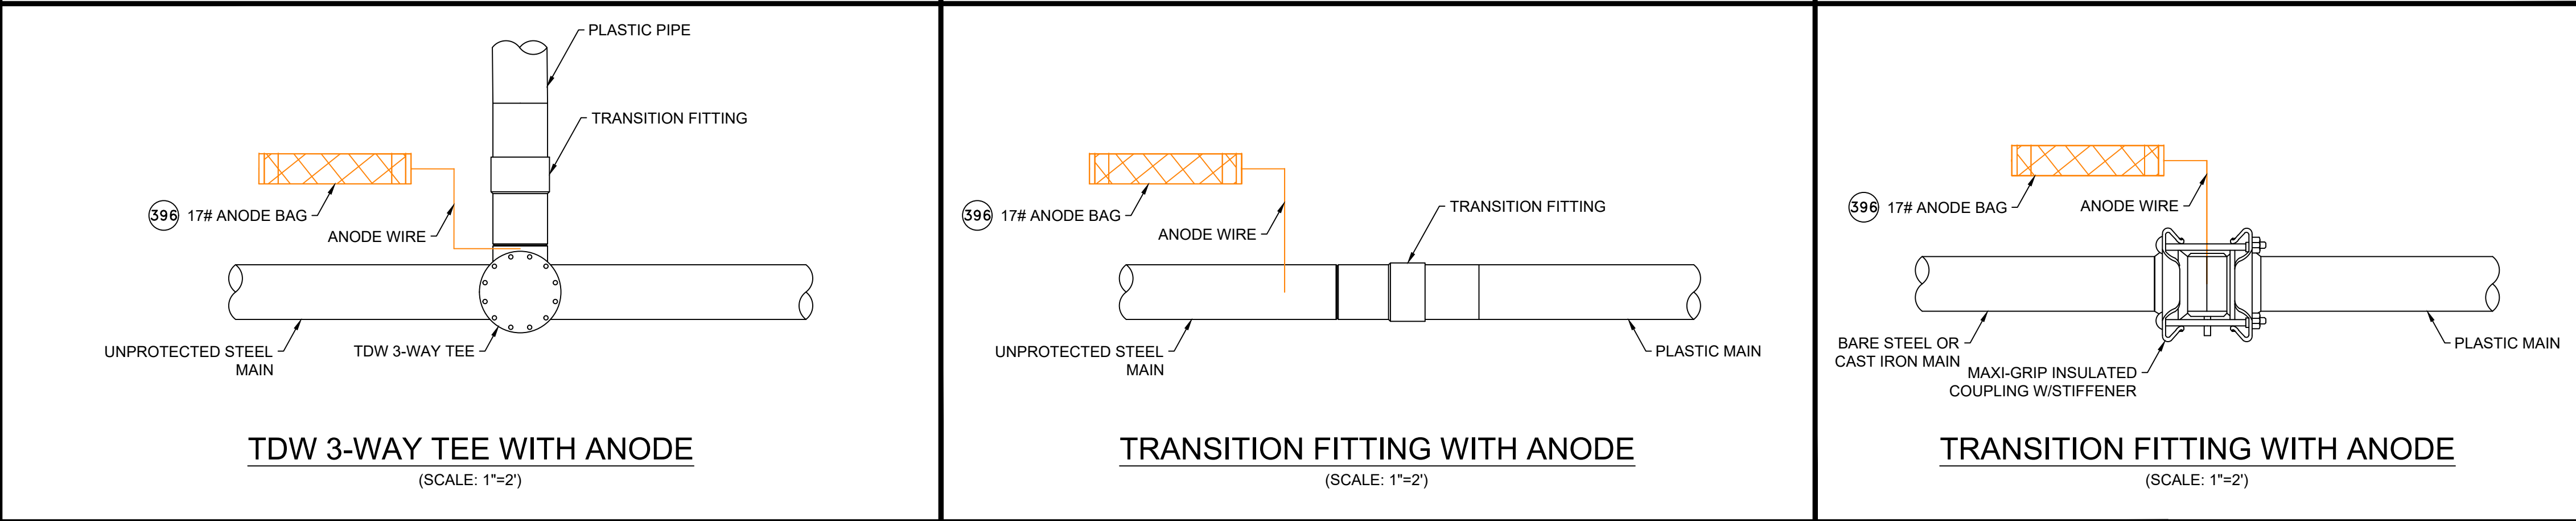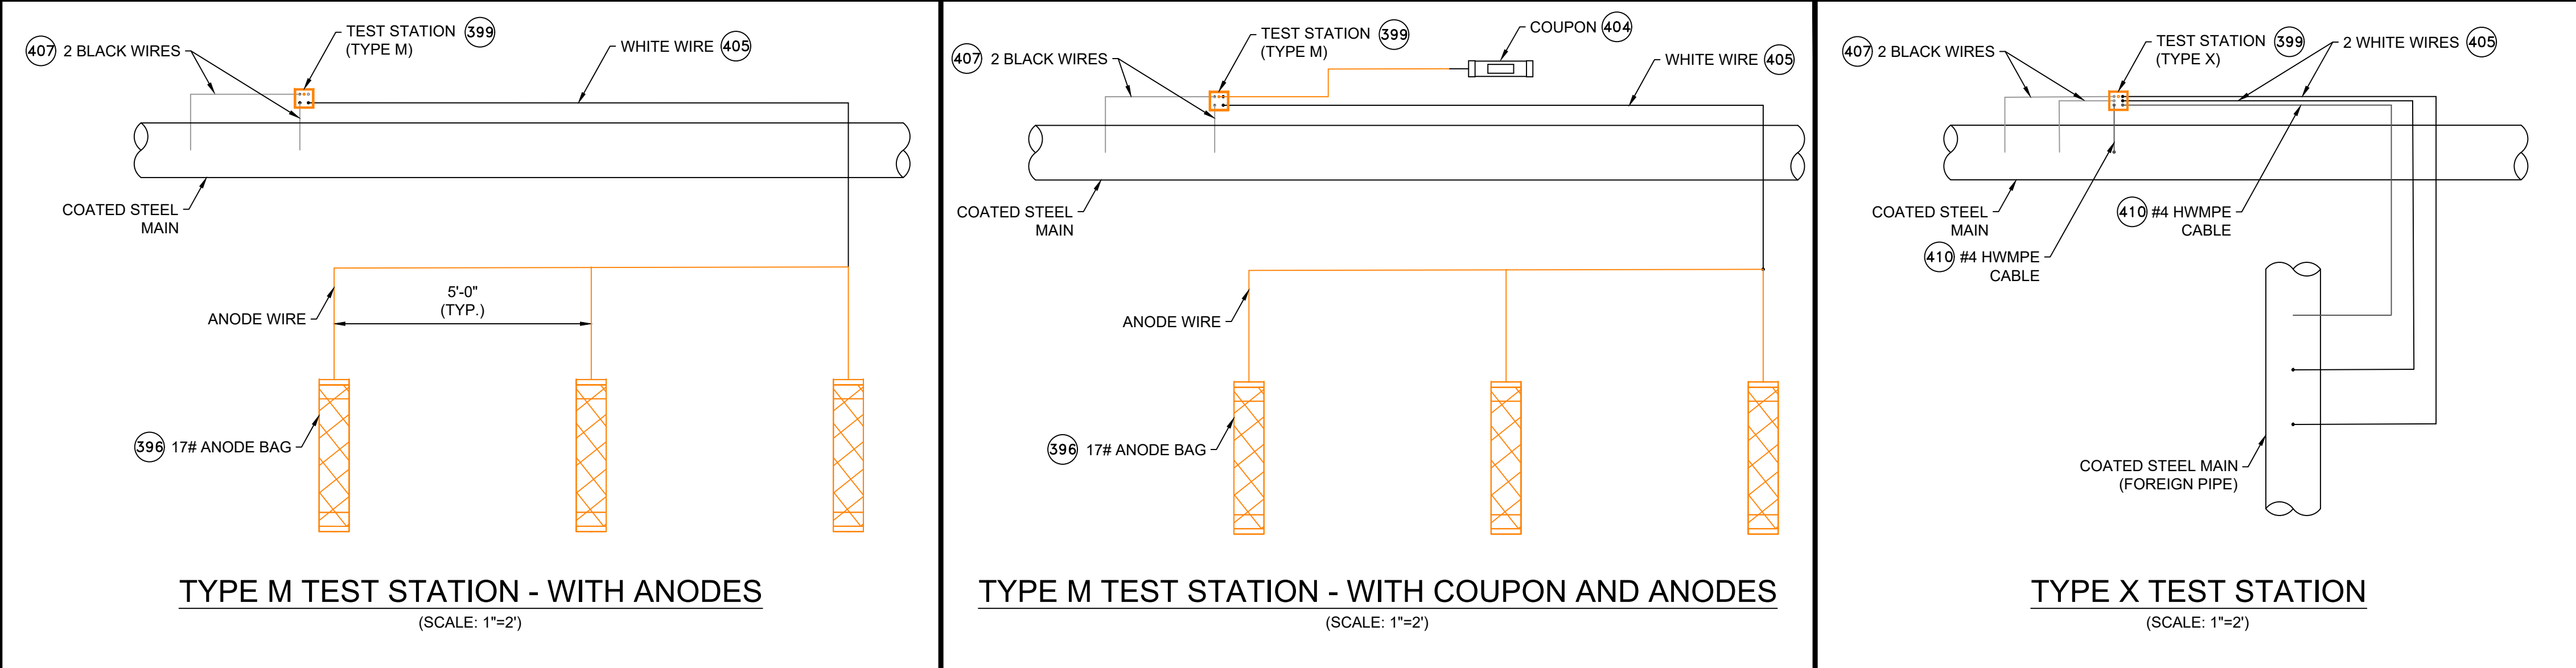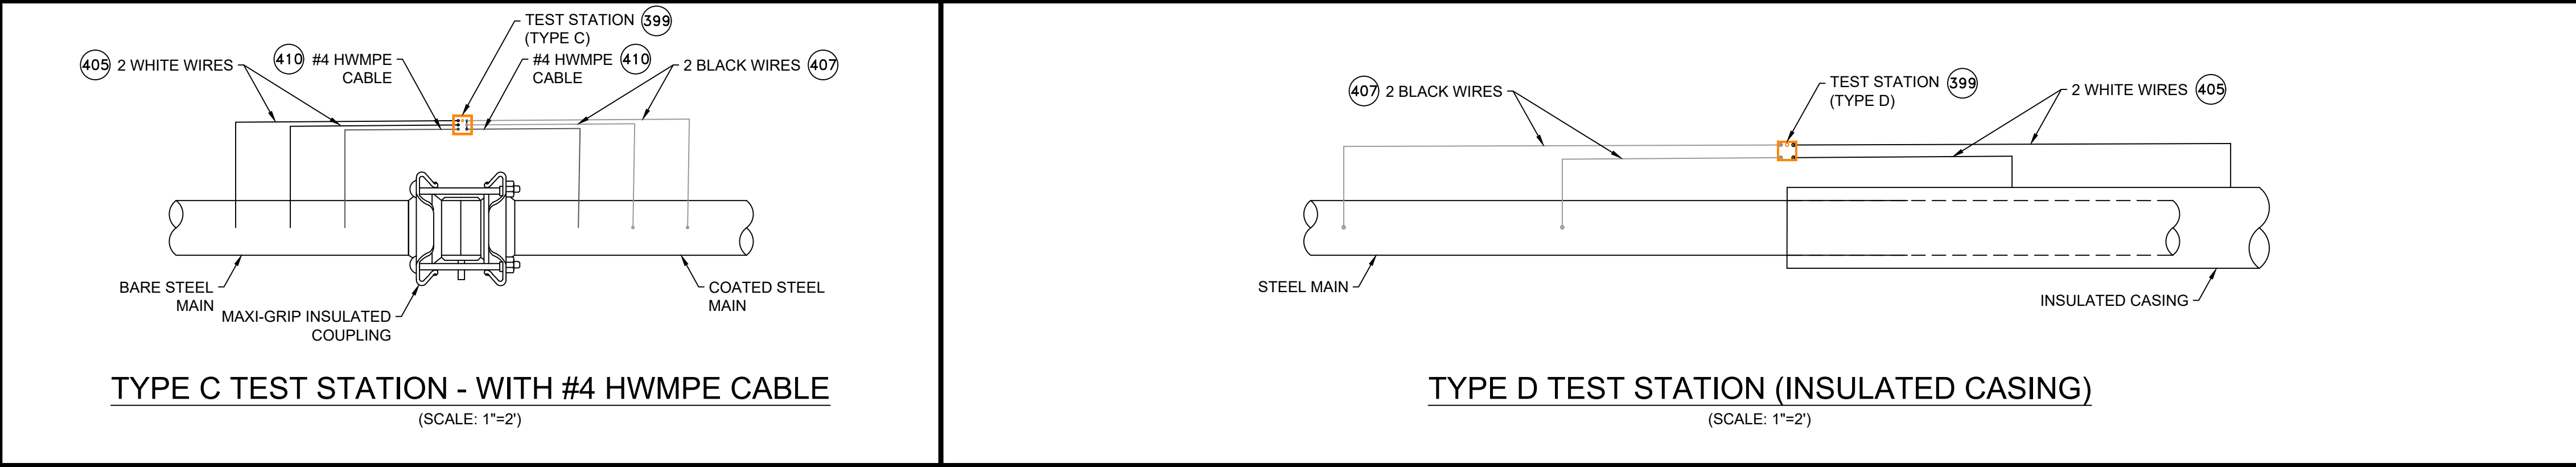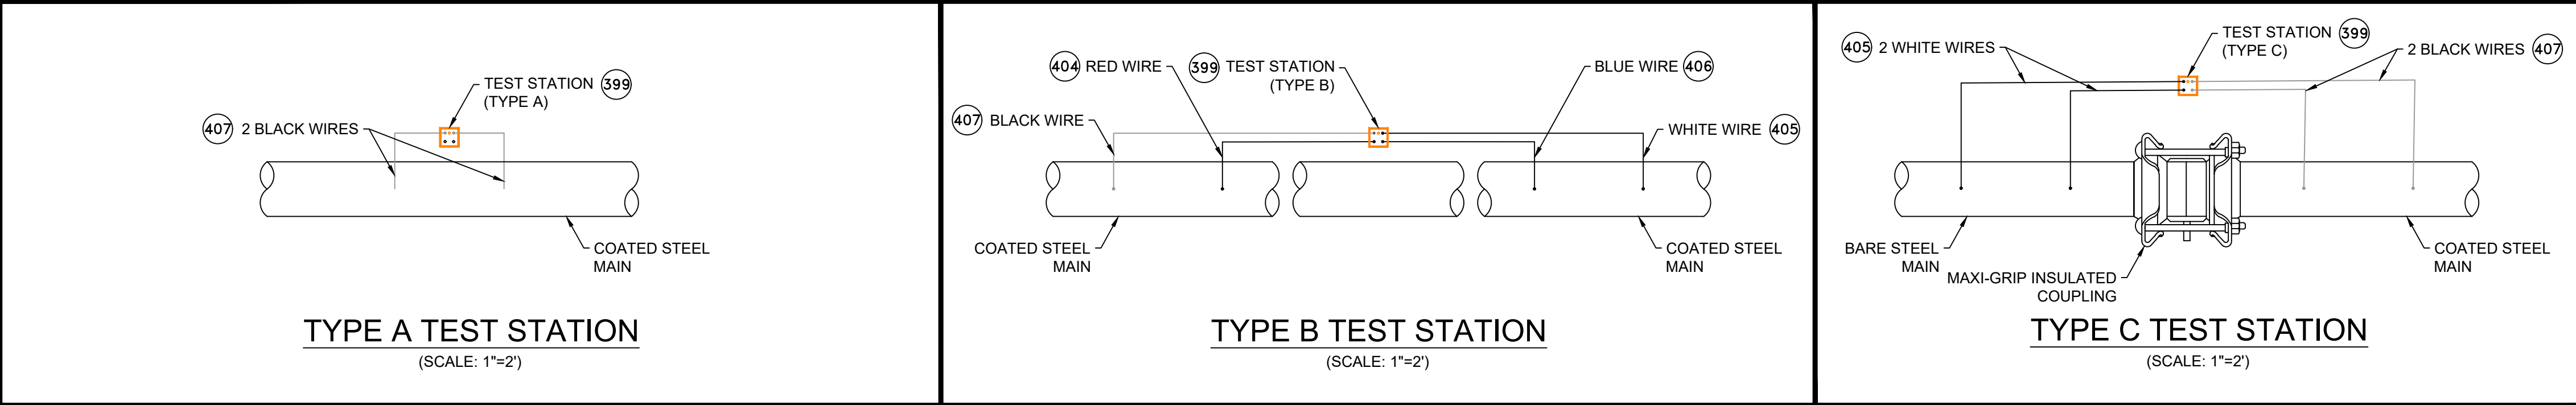ISSUED FOR
CONSTRUCTION
12/23/2020

SEALED BY:
ERIC VINAI KUMAR
No. 54771
REGISTERED PROFESSIONAL ENGINEER
SIGNATURE

SEALED ON:
12/27/2020
LICENSE EXPIRATION:
06/30/2022

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